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**CONSTRUCTION PLANS
CITY OF NAPLES WWTP
MCC REPLACEMENT**

FOR

CITY OF NAPLES


LOCATED IN

SECTION 03, TOWNSHIP 50 SOUTH, RANGE 25 EAST


NAPLES, FL

DEC. 2018


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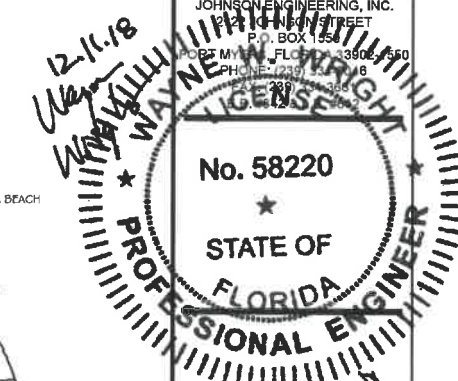
LOCATION MAP

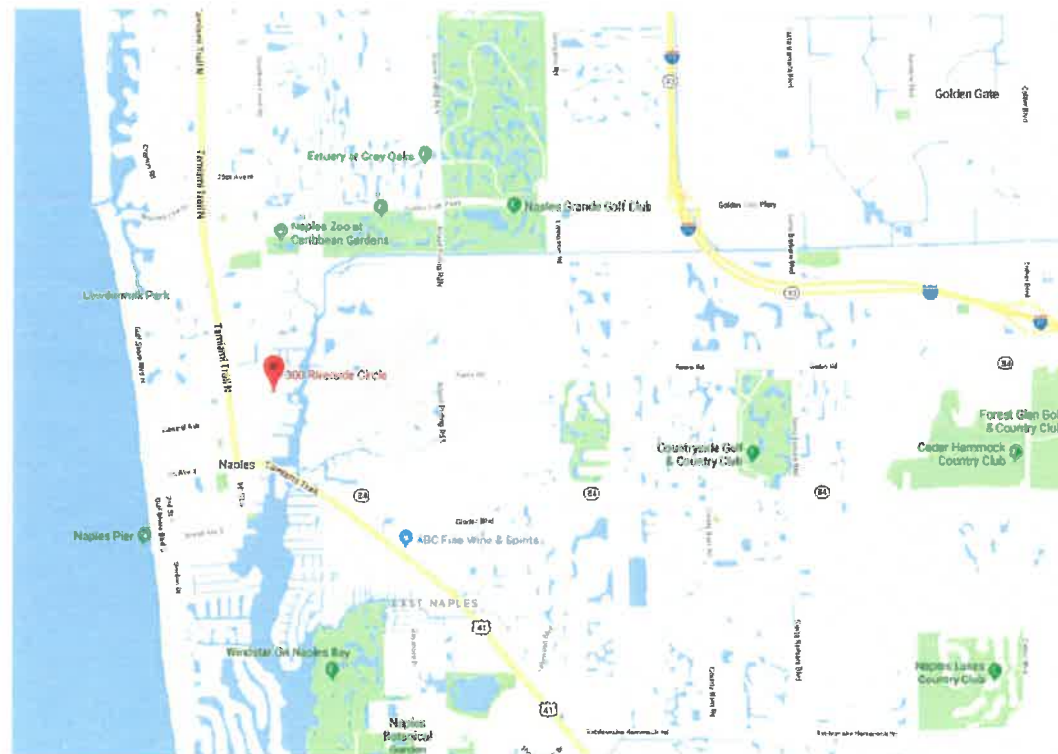

LOCATION OF PROJECT

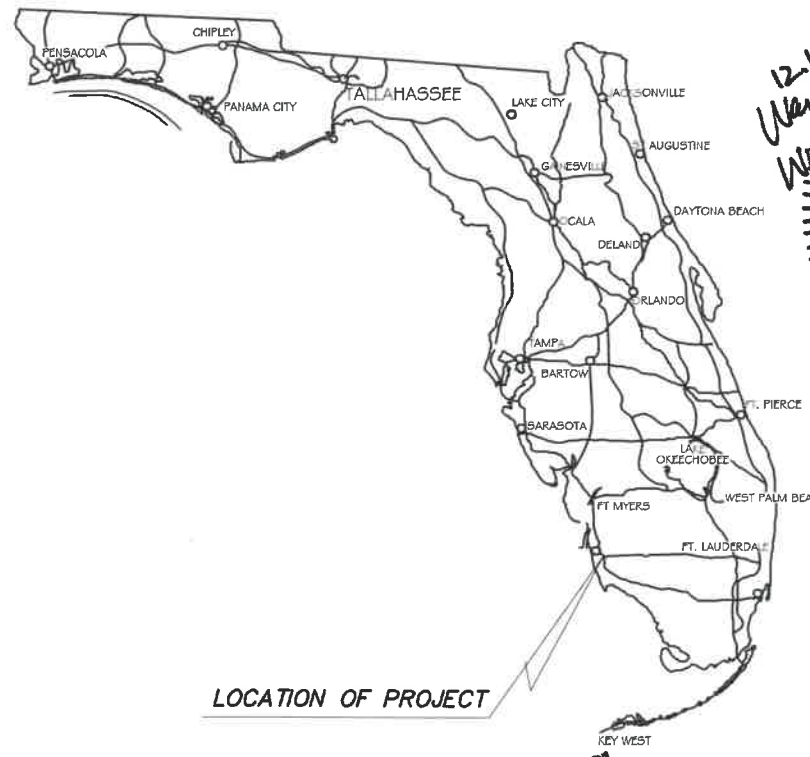

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E.B. #642 & L.B. #642

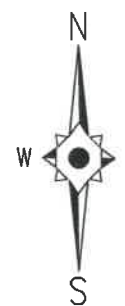

CITY OF NAPLES WWTP
MCC REPLACEMENT
CONSTRUCTION PLANS
CITY OF NAPLES
NAPLES, FL

NO.	DESCRIPTION	DATE

DATE: DEC. 2018
PROJECT NO. 20150110-007
FILE NO. 03-50-25
SCALE: NONE

DESIGN CONSULTANT



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PROJECT COVER SHEET

SHEET NUMBER
E50

ABBREVIATIONS

A	AMPERES, AMBER OR ALARM
AH	AMP HOUR OR ALARM HORN
AL	ALARM LIGHT
ALM	ALARM
ASR	ALARM SILENCE RELAY
AHU	AIR HANDLING UNIT
AIC	AMPS INTERRUPTING CURRENT
ATS	AUTOMATIC TRANSFER SWITCH
AUX	AUXILIARY
BAT	BATTERY
BPC	BACKUP PUMP CONTROLLER
BOM	BILL OF MATERIAL
CB	CIRCUIT BREAKER
C	CONDUIT
CP	CONTROL PANEL
CPSA	CONTROL PANEL SURGE ARRESTOR
CT	CURRENT TRANSFORMER
CU	COPPER
DISC	DISCONNECT
DO	DIGITAL OUTPUT
DPDT	DOUBLE POLE DOUBLE THROW
DPST	DOUBLE POLE SINGLE THROW
EG	EQUIPMENT GROUND
ETM	ELAPSED TIME METER
F	FUSE
FLT	FAULT
FPL	FLORIDA POWER AND LIGHT
FMC	FLEXIBLE METALLIC CONDUIT
FS	FLOAT SWITCH
GEN	GENERATOR
GFCI	GROUND FAULT CIRCUIT INTERRUPTER
GND, G	GROUND
GRS	GALVANIZED RIGID STEEL
H	HIGH
HS	HAND SWITCH
HOA	HAND-OFF-AUTOMATIC
HOR	HAND-OFF-REMOTE
HMI	HUMAN MACHINE INTERFACE
I	INDICATOR
I&C	INSTRUMENTATION & CONTROL
INTR	INTRUSION
JB	JUNCTION BOX
L	LEVEL OR LOW
LR	LINE REACTOR
NEUT, N	NEUTRAL
NTS	NOT TO SCALE
O/C	OPEN / CLOSE
OIT	OPERATOR INTERFACE TERMINAL
MOV	MOTOR OPERATED VALVE
MSC	MANUFACTURER'S SUPPLIED CABLE
NF	NON-FUSIBLE
P	PRESSURE
PB	PUSHBUTTON
PLC	PROGRAMMABLE LOGIC CONTROLLER
PH, Ø	PHASE
PC	PHOTOCELL
PCP	PUMP CONTROL PANEL
PM	PHASE MONITOR
PS	POWER SUPPLY
PIT	PUSH-TO-TEST
Q	TOTALIZER
RECEPT.	RECEPTACLE
R	RELAY, TREND, RESISTOR
RTU	REMOTE TELEMETRY UNIT
SCCR	SHORT CIRCUIT CURRENT RATING
SHLD	SHIELDED
SPD	SURGE PROTECTION DEVICE
S	SWITCH
SS	SELECTOR SWITCH
SSOL	SOLID STATE OVERLOAD
SV	SOLENOID VALVE
TB	TERMINAL BLOCK
TD	TIME DELAY
TSP	TWISTED SHIELDED PAIR
UG	UNDERGROUND
UPS	UNINTERRUPTABLE POWER SUPPLY
VFD	VARIABLE FREQUENCY DRIVE
XFMR	TRANSFORMER
Z	POSITION

SYMBOLS

	MAGNETIC FLOW INDICATING TRANSMITTER
	PRESSURE INDICATING TRANSMITTER
	FLOW INDICATING TRANSMITTER
	FLOW ELEMENT
	LEVEL (FLOAT) SWITCH
	PRESSURE SWITCH
	FLOW SWITCH
	MOTOR OPERATED VALVE (MOV)
	SOLENOID VALVE (SV)
	SOLENOID VALVE (SV)
	DIAPHRAGM VALVE
	VOLTMETER
	AMMETER
	GROUND FAULT INTERRUPTER
	DRAW-OUT CIRCUIT BREAKER
	CIRCUIT BREAKER WITH TRIP RATING
	MOTOR WITH HP RATING
	EQUIPMENT GROUND
	DRIVEN ROD-TYPE GROUNDING ELECTRODE
	DRIVEN ROD-TYPE GROUNDING ELECTRODE WITH GROUND ACCESS WELL
	NON-FUSIBLE DISCONNECT SWITCH, 30A, 3P UNLESS OTHERWISE INDICATED
	CURRENT TRANSFORMER
	TRANSFORMER
	CONDUIT OR WIRE ROUTING; SHORT HASH MARK = PHASE CONDUCTOR LONG HASH MARK = NEUTRAL CONDUCTOR
	MOTOR OVERLOAD (EUTECTIC ALLOY)
	AC/DC POWER SUPPLY
	SURGE SUPPRESSOR (PROTECTED/UNPROTECTED)
	FUSED LEVER-TYPE TERMINAL BLOCK WITH LED INDICATOR
	CT SHORTING BAR

	DUPLEX RECEPTACLE
	NORMALLY OPEN CONTACT
	NORMALLY CLOSED CONTACT
	LIMIT SWITCH, NORMALLY OPEN
	LIMIT SWITCH, NORMALLY CLOSED
	PRESSURE SWITCH, NORMALLY OPEN
	PRESSURE SWITCH, NORMALLY CLOSED
	FLOAT SWITCH, NORMALLY OPEN
	FLOAT SWITCH, NORMALLY CLOSED
	FLOW SWITCH, NORMALLY OPEN
	FLOW SWITCH, NORMALLY CLOSED
	TEMP. SWITCH, NORMALLY OPEN
	TEMP. SWITCH, NORMALLY CLOSED
	NORMALLY OPEN TIMED TO CLOSE CONTACT
	NORMALLY CLOSED TIMED TO OPEN CONTACT
	NORMALLY OPEN TIMED TO OPEN CONTACT
	LIMIT SWITCH
	TORQUE SWITCH
	PRESSURE SWITCH
	VIBRATION SWITCH
	ALARM RELAY
	CONTROL RELAY
	MOTOR STARTER
	TIMING RELAY
	INDICATING LIGHT WITH COLOR
	NORMALLY OPEN PUSHBUTTON
	NORMALLY CLOSED PUSHBUTTON
	MAINTAINED SWITCH
	FUSE WITH RATING
	REMOTE TERMINAL POINT
	HORN
	PUMP
	TERMINAL BLOCK
	KEY INTERLOCK

GENERAL ELECTRICAL NOTES


- ALL NEW CONSTRUCTION SHALL COMPLY WITH APPLICABLE N.E.C. AND LOCAL CODES.
- CONDUCTORS SHALL NOT BE SPLICED.
- ALL MULTICONDUCTOR CONTROL CABLE SHALL BE #14 AWG XHHW-2, OMNIBCALE P/N AF114XX, OR EQ.
- ALL BELOW GRADE CONDUIT RUNS SHALL BE IN SCHEDULE 80 PVC CONDUIT UNLESS NOTED OTHERWISE. ALL ABOVE GRADE CONDUIT RUNS SHALL BE IN RIGID ALUMINUM CONDUIT UNLESS NOTED OTHERWISE. PROVIDE PVC CONDUIT SLEEVE AROUND CONDUIT PENETRATIONS IN CONCRETE FOR PROTECTION.
- ALL BONDING CONDUCTORS SHALL BE ROUTED IN SCHEDULE 80 PVC CONDUIT.
- ALL CONDUIT RACEWAYS SHALL HAVE AN INSULATED COPPER SYSTEM GROUND CONDUCTOR THROUGHOUT THE ENTIRE LENGTH OF THE CIRCUIT INSTALLED PER N.E.C.
- ALL CONDUIT RACEWAYS WHICH ARE INSTALLED FOR FUTURE USE SHALL HAVE A NYLON PULLCORD.
- PVC CONDUIT JOINTS SHALL BE SOLVENT-WELDED, EXCEPT FOR RIGID METALLIC TO PVC COUPLINGS.
- MINIMUM CONDUIT SIZE SHALL BE 3/4".
- ALL CONDUIT RACEWAYS SHALL BE RUN IN NEAT AND WORKMANLIKE MANNER AND SHALL BE PROPERLY SUPPORTED PER N.E.C.
- ALL CONNECTIONS TO MOTORS AND OTHER VIBRATING EQUIPMENT OR AT OTHER LOCATIONS WHERE REQUIRED SHALL BE MADE WITH FLEXIBLE LIQUID-TIGHT STEEL CONDUIT 12" TO 36" IN LENGTH.
- ALL FEEDER AND BRANCH CIRCUIT WIRING SHALL BE COLOR CODED AS FOLLOWS:
3-PHASE 480Y/277VAC (A/B/C/N/G) : PUR/BRN/YEL/WHT/GRN
3-PHASE 240/120VAC (A/B(HI)/C/N/G) : BLK/RED(ORG)/BLU/WHT/GRN
1-PHASE AC POWER : BLK, 12 AWG MIN.
AC POWER HOT : BLK, 12 AWG MIN.
AC POWER NEUTRAL : WHT, 12 AWG MIN.
AC SWITCHED : RED, 16 AWG MIN.
EXTERNALLY POWERED : YEL, 16 AWG MIN.
GROUND : GRN, 12 AWG MIN.
DC + : BLU, 16 AWG MIN.
DC - : BLU WITH WHT STRIPE, 16 AWG MIN.
TSP (+/-) : RED/BLK, 16 AWG. MIN., BELDEN 1118A, OR EQ.
- ALL CONDUCTORS SHALL BE 600-VOLT RATED, STRANDED COPPER.
- ETHERNET CABLE SHALL BE CAT-5e 600V UL AWM RATED
- ALL WIRES AND CABLES SHALL BE MARKED USING WHITE HEAT SHRINK MARKERS.
- BRANCH CIRCUITS EXCEEDING 75' SHALL BE WIRED WITH MINIMUM #10AWG WIRE.
- COORDINATE ALL SERVICE ENTRANCE WORK WITH THE LOCAL ELECTRIC UTILITY AND ADHERE TO ALL UTILITY STANDARDS.
- CONTRACTOR SHALL BE RESPONSIBLE FOR PERFORMING THE WORK AND FURNISHING ALL MATERIALS OUTLINED IN THESE PLANS AND ANY OTHER MATERIALS AND WORK NECESSARY FOR A FULLY OPERATIONAL SYSTEM.

PROJECT ELECTRICAL NOTES

- ALL DEMOED EQUIPMENT SHALL BE DISPOSED OF BY THE CONTRACTOR.
- SEE SPECIFICATIONS FOR CONSTRUCTION STAGING SCHEDULE, DETAILS, PROCEDURES AND LIMITATIONS ON EQUIPMENT UNAVAILABILITY.

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CITY OF NAPLES WWTP
MCC REPLACEMENT
CONSTRUCTION PLANS
CITY OF NAPLES
NAPLES, FL

NO.	REVISIONS DESCRIPTION	DATE

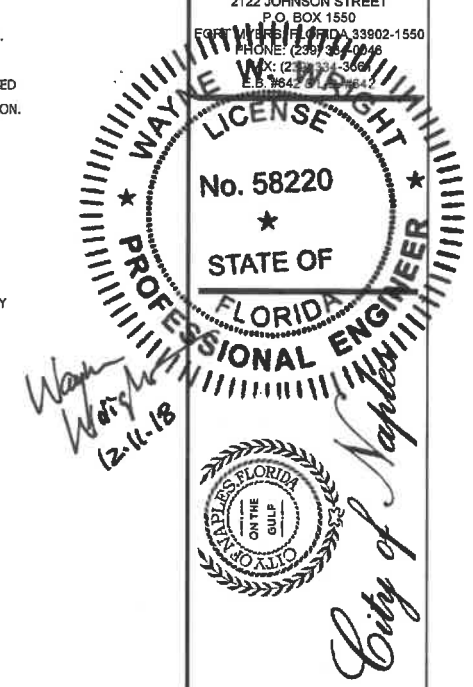DATE: DEC. 2018
PROJECT NO. 20150110-007
FILE NO. 03-50-25
SCALE: NONE


NOTES & SYMBOLS

SHEET NUMBER
E51



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Wayne
 12-14-18

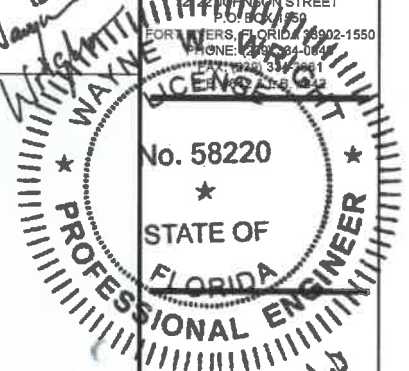

City of Naples

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 CONSTRUCTION PLANS
 CITY OF NAPLES
 NAPLES, FL


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DATE: DEC. 2018
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 FILE NO. 03-50-25
 SCALE: NONE

WWTP SITE PLAN


SHEET NUMBER

E52

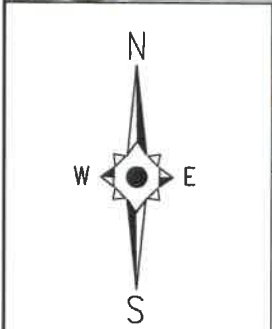

UNIFORM BUILDING
 MCC-3 AND MCC-4

ADMIN. BUILDING

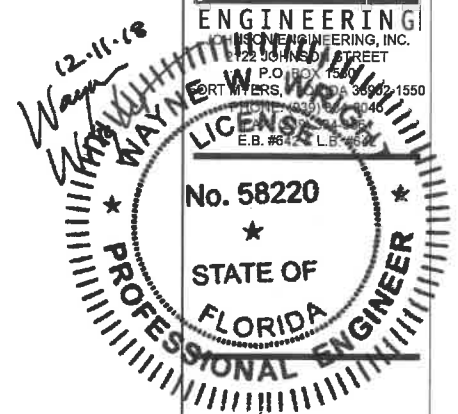

City of Naples


CITY OF NAPLES WWTP
 MCC REPLACEMENT
 CONSTRUCTION PLANS
 CITY OF NAPLES
 NAPLES, FL


NO.	DATE	DESCRIPTION

MCC-3 SINGLE LINE DIAGRAM

SHEET NUMBER
E53

- NOTES: #
- NEW EQUIPMENT DEPICTED IN BOLD.
 - 480VAC, 3PH, 3W, 600A HORIZONTAL BUS, 600A VERTICAL BUS, 300A GROUND BUS, MAIN C/B, NEMA 12 ENCLOSURE, RATED 42KAIC MIN., TIN-PLATED COPPER BUS. PROVIDE NAMEPLATES FOR ALL BUCKETS.
 - AUXILIARY CABINET TO CONTAIN POWER METER AND SURGE PROTECTION DEVICE WITH EXTERNAL DISPLAY.
 - COMBINATION MOTOR STARTER BUCKETS TO BE ELECTRONIC MCP TYPE, WITH SOLID STATE ELECTRONIC OVERLOADS, NEMA STARTER (1NO, 1NC), HAND-OFF-AUTO SELECTOR SWITCH, GRN "RUNNING" P-T-T LIGHT, RED "STOPPED" P-T-T LIGHT, AMB "FAULT" P-T-T LIGHT, WITH TWO PRIMARY AND ONE SECONDARY CPT FUSING (SEE TYP. MOTOR STARTER WIRING DETAIL).
 - EQUIPPED WITH KEY INTERLOCK (K)

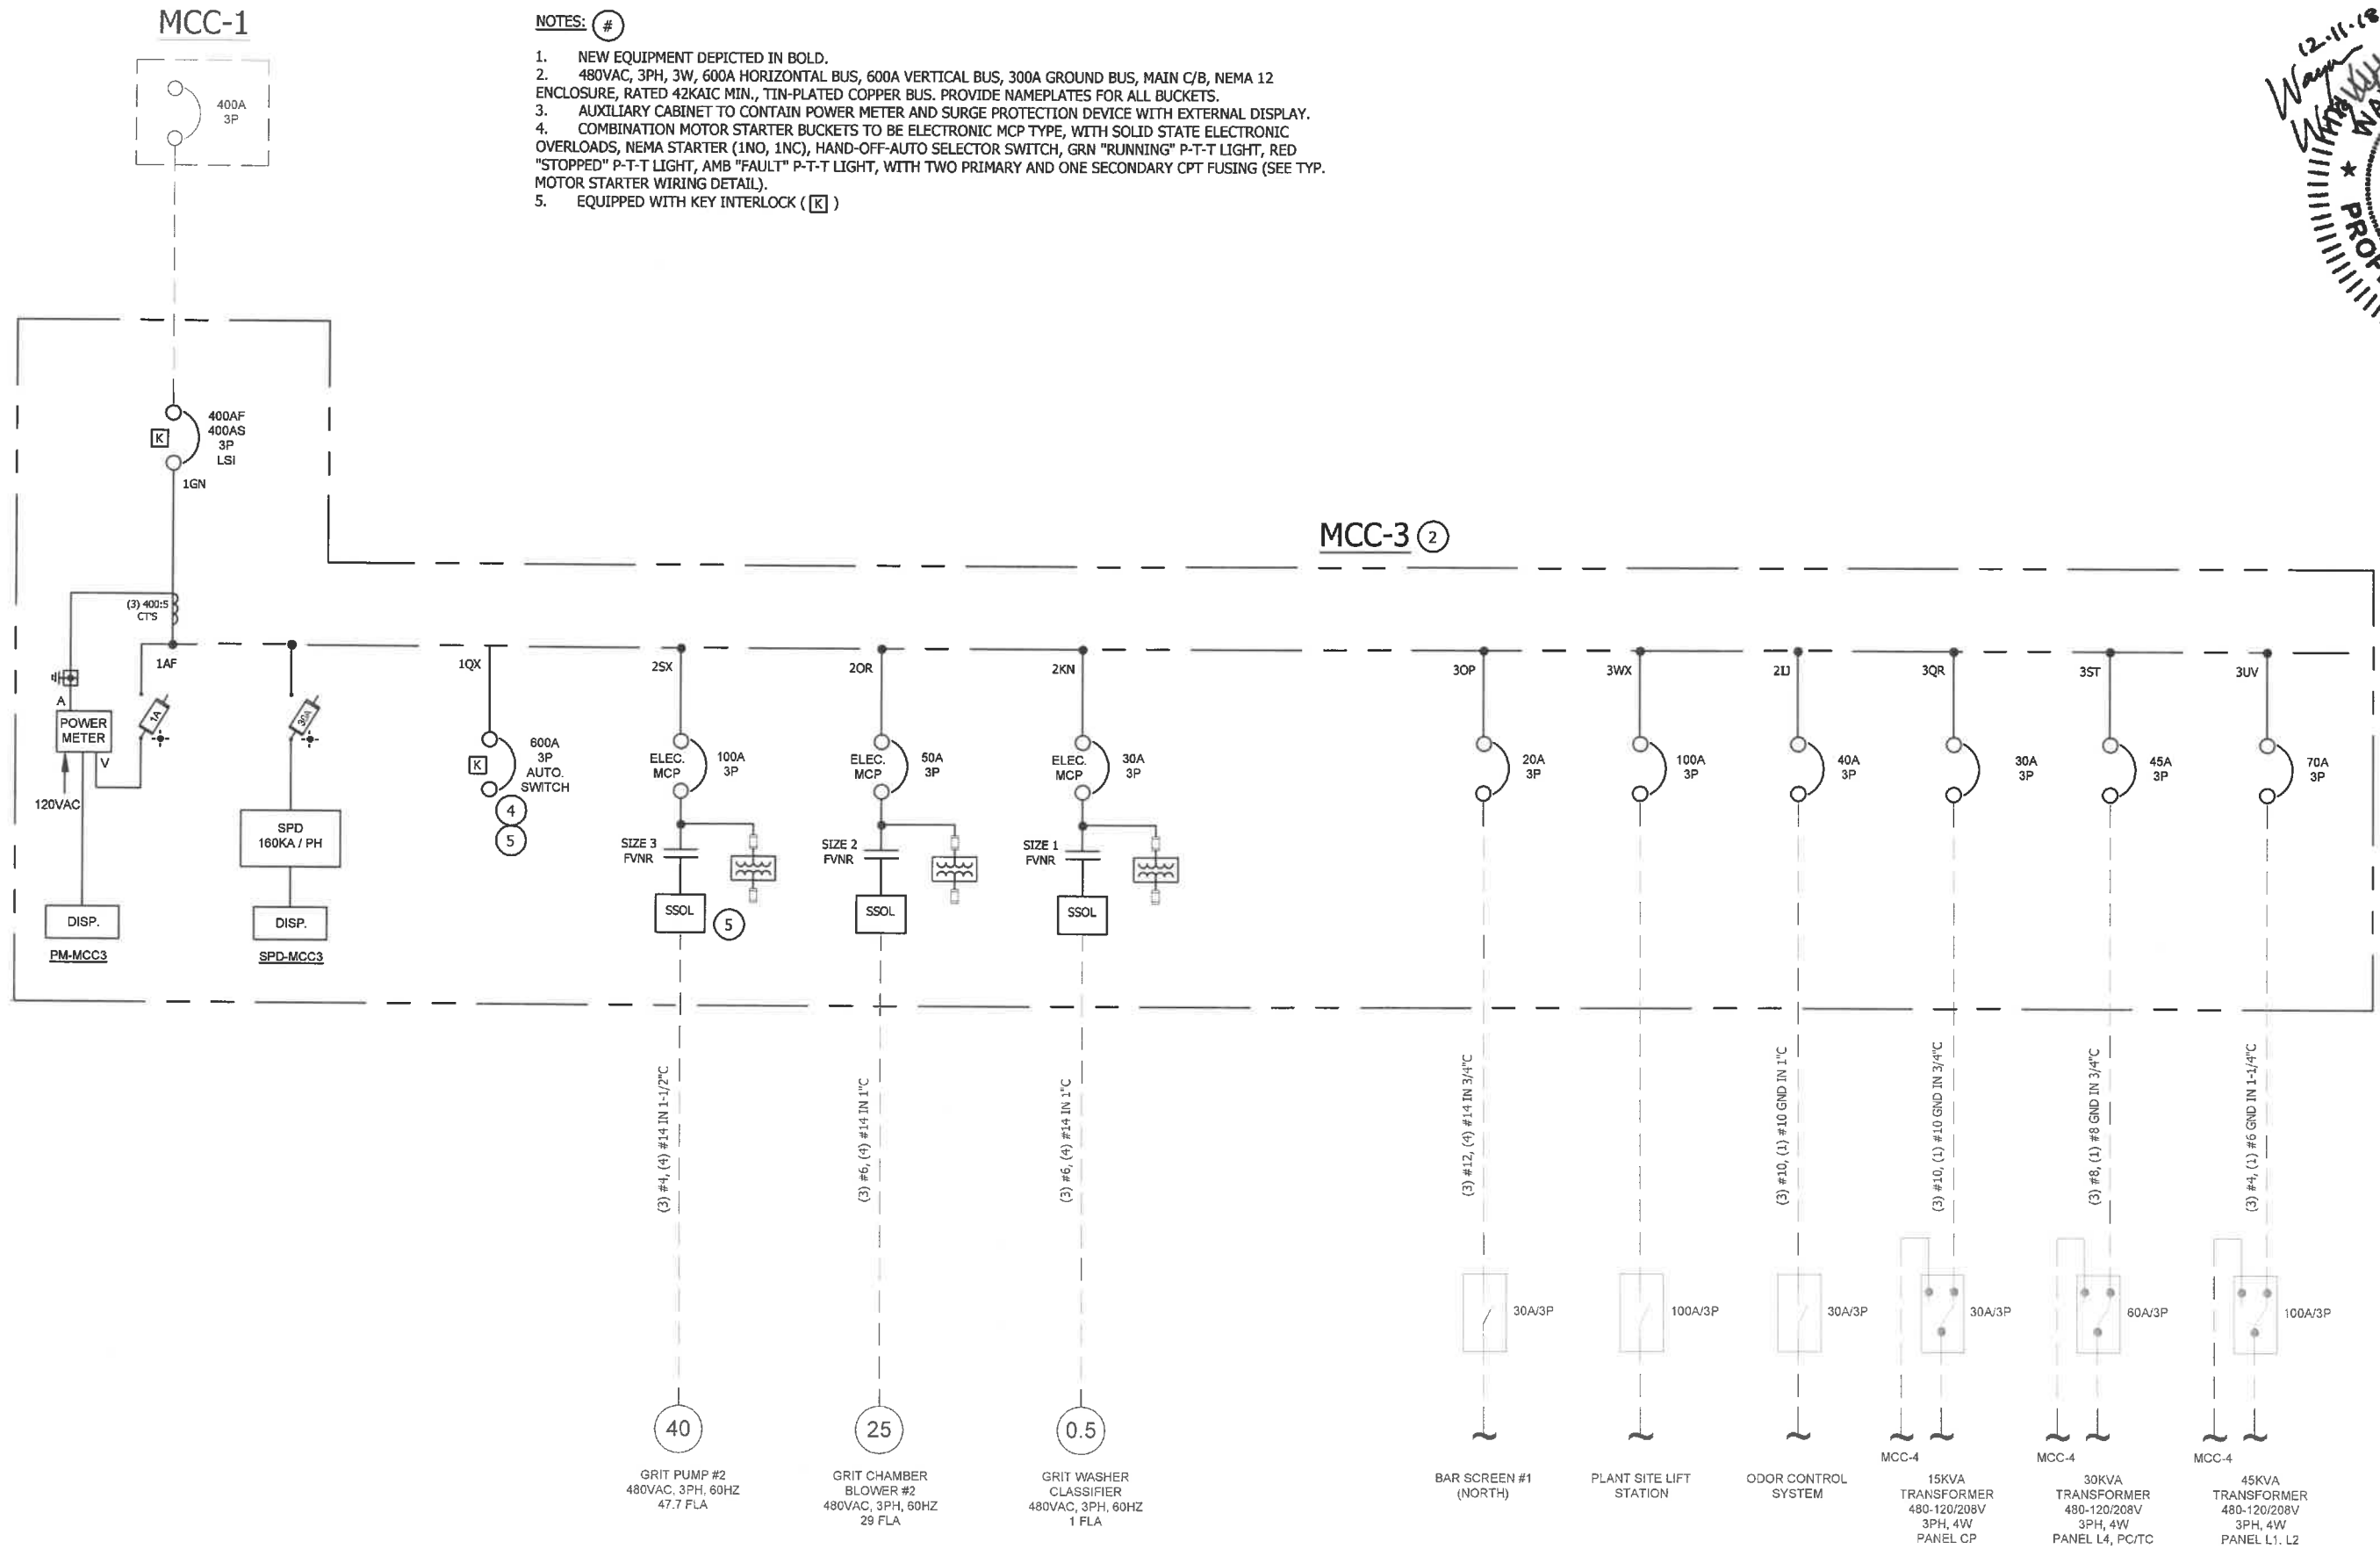

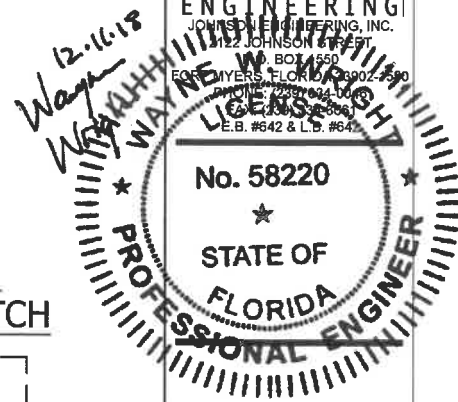

Wayne W. Johnson
 City of Naples

CITY OF NAPLES WWTP
 MCC REPLACEMENT
 CONSTRUCTION PLANS
 CITY OF NAPLES
 NAPLES, FL


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DATE: DEC. 2018
 PROJECT NO. 20150110-007
 FILE NO. 03-50-25
 SCALE: NONE


MCC-4 SINGLE LINE DIAGRAM

SHEET NUMBER
E54


NOTES: #
 1. SEE NOTES FOR MCC-3.

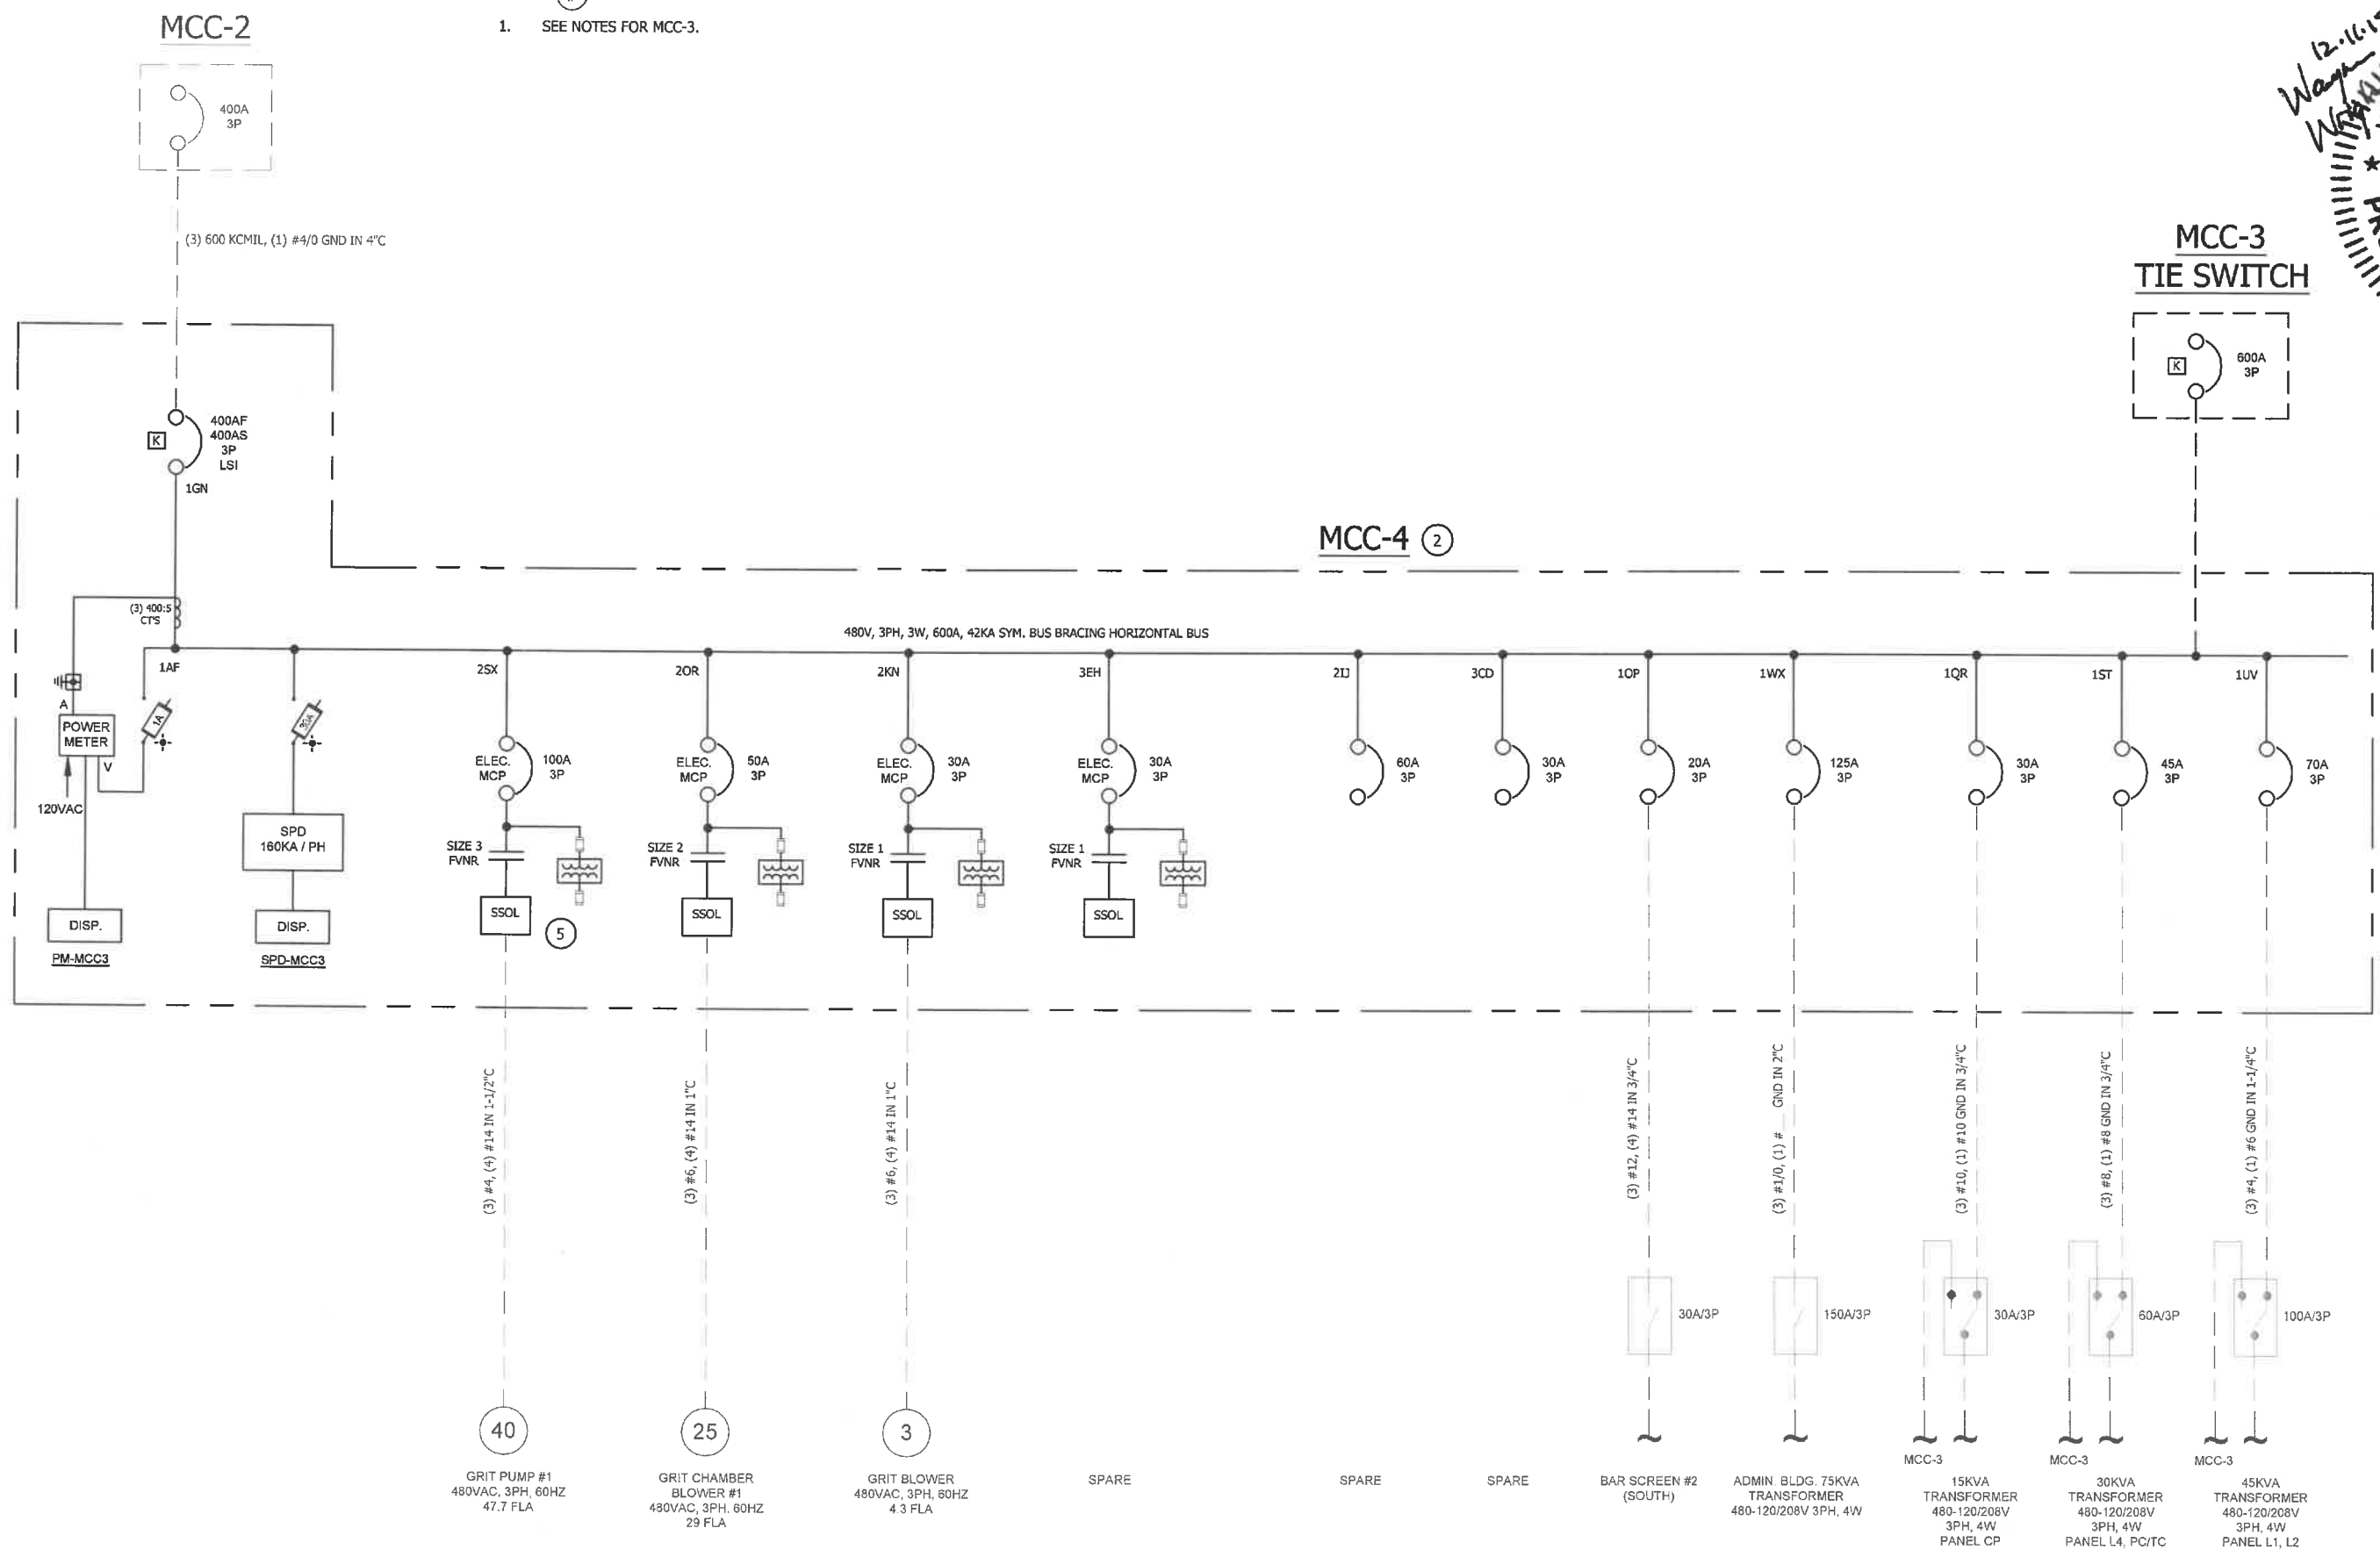

EXISTING MCC ARRANGEMENT

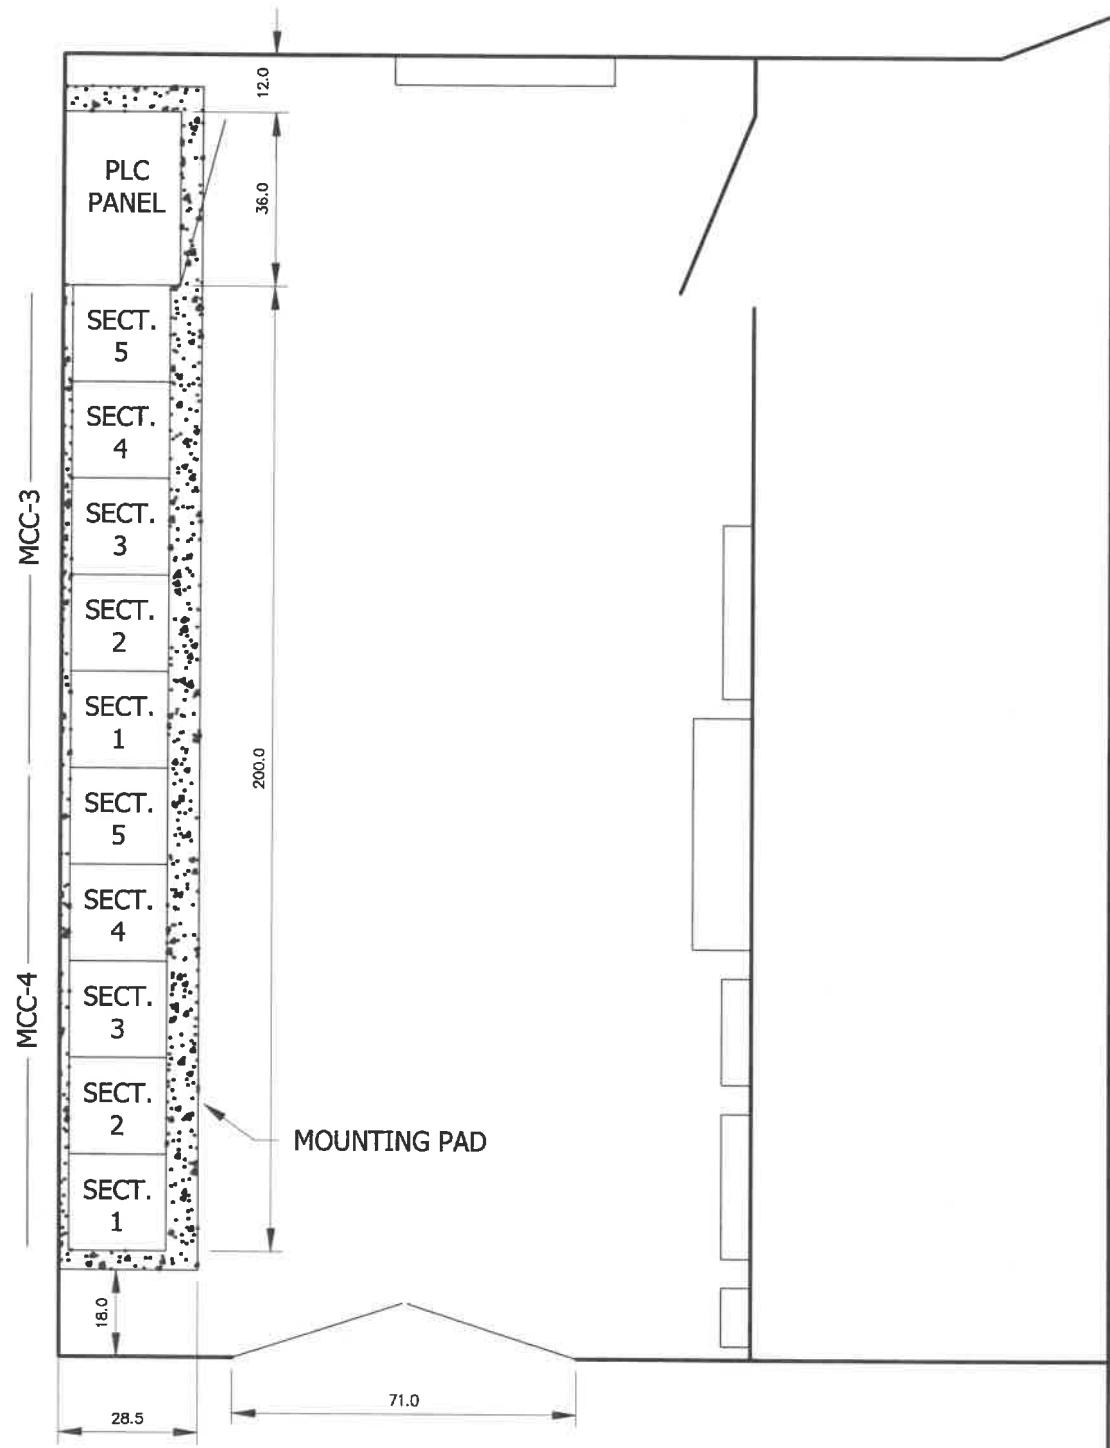

PROPOSED MCC ARRANGEMENT

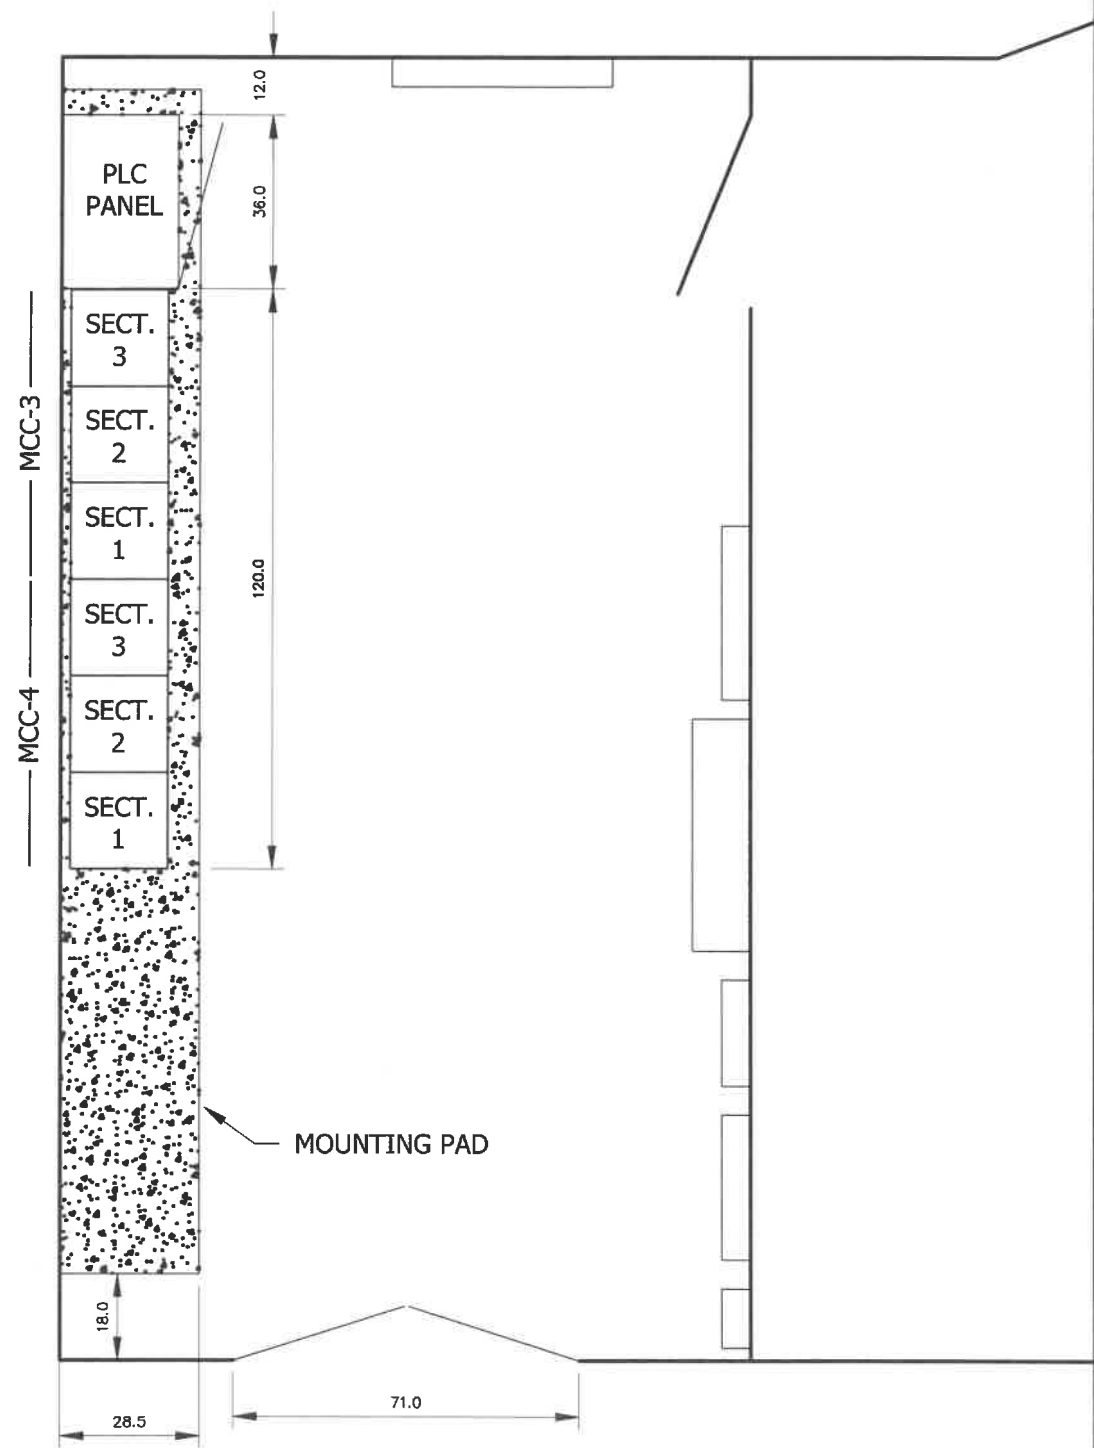

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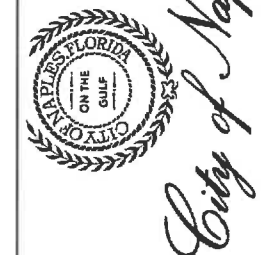
CITY OF NAPLES WWTP
 MCC REPLACEMENT
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 CITY OF NAPLES
 NAPLES, FL

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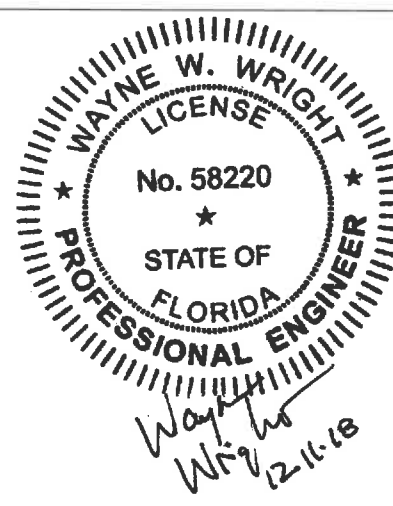
DATE: DEC. 2018
 PROJECT NO. 20150110-007
 FILE NO. 03-50-25
 SCALE: 1" = 40'

MCC-3 & MCC-4
 SITE PLAN

SHEET NUMBER
 E55



CITY OF NAPLES WWTP
 MCC REPLACEMENT
 CONSTRUCTION PLANS
 CITY OF NAPLES
 NAPLES, FL




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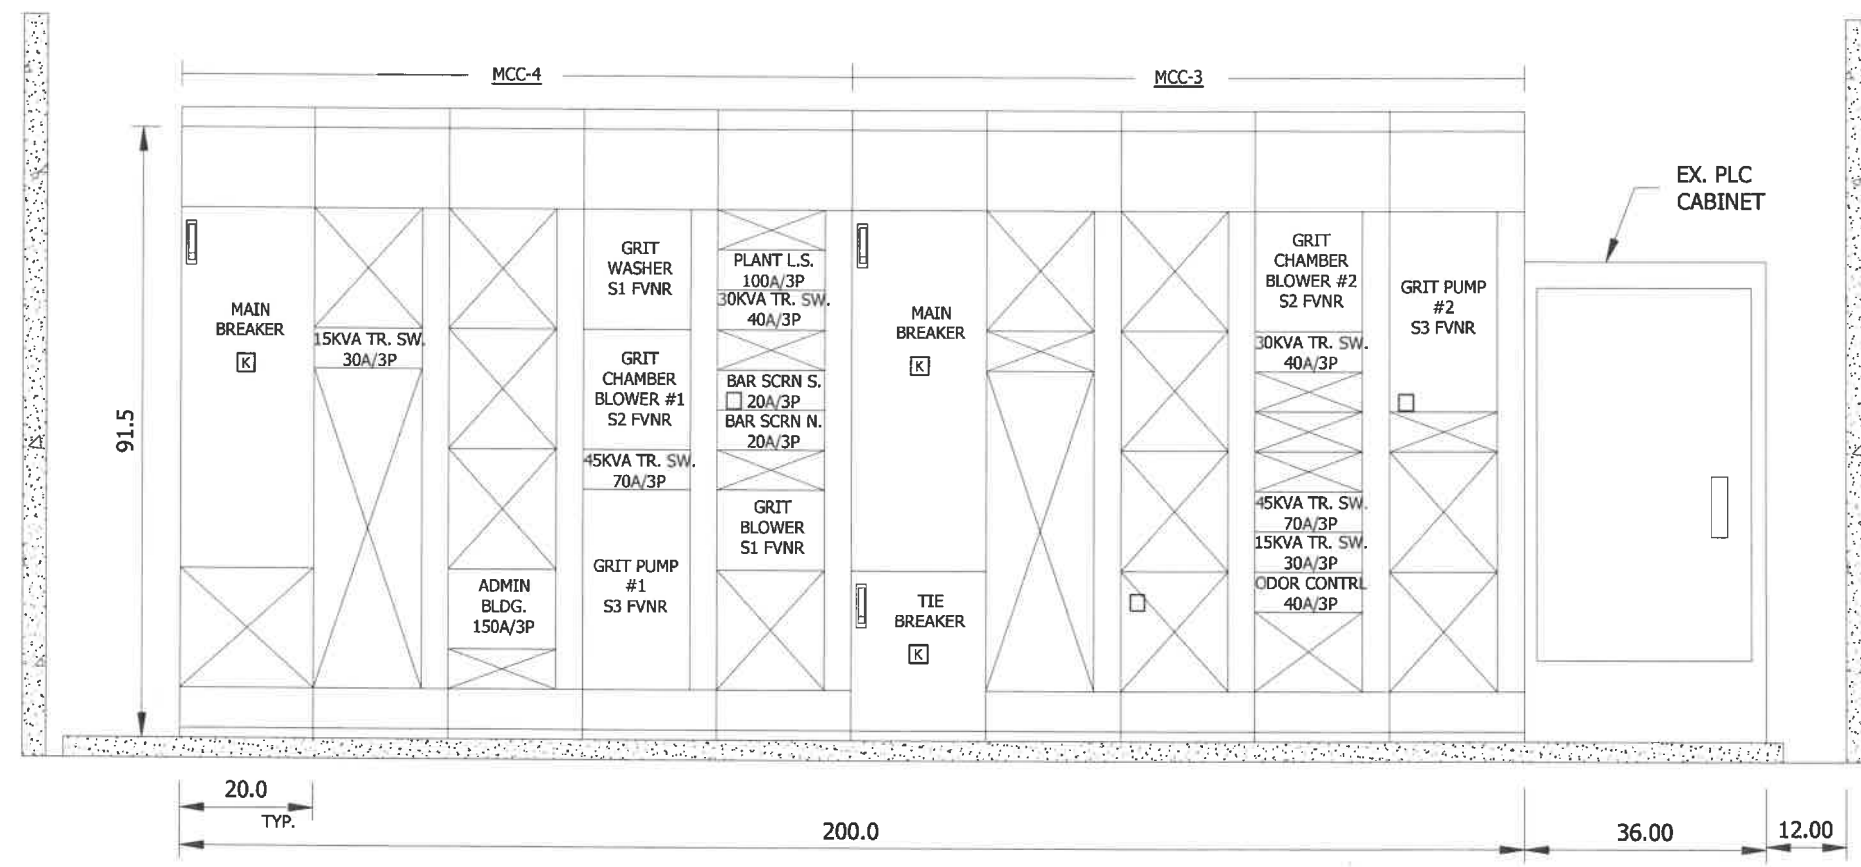
MCC-3 & MCC-4
 ELEVATION

SHEET NUMBER
 E56

MCC-4				MCC-3			
DEVICE	LOC.	TYPE	RATING	DEVICE	LOC.	TYPE	RATING
MAIN CIRCUIT BREAKER	1AH	MAIN	400A/3P	MAIN CIRCUIT BREAKER	3AH	MAIN	400A/3P
AUX. CABINET	1IN	AUX.	-	AUX. CABINET	3IN	AUX.	-
BAR SCREEN #2 (SOUTH)	1OP	FDR	20A/3P	BAR SCREEN #1 (NORTH)	3OP	FDR	20A/3P
MAN. TRANSFER SWITCH 15KVA TRANSFORMER (PNL-CP)	1QR	FDR	30A/3P	MAN. TRANSFER SWITCH 15KVA TRANSFORMER (PNL-CP)	3QR	FDR	30A/3P
MAN. TRANSFER SWITCH 30KVA TRANSFORMER (PNL-L4,PC/TC)	1ST	FDR	45A/3P	MAN. TRANSFER SWITCH 30KVA TRANSFORMER (PNL-L4,PC/TC)	3ST	FDR	45A/3P
MAN. TRANSFER SWITCH 45KVA TRANSFORMER (PNL-L1,L2)	1UV	FDR	70A/3P	MAN. TRANSFER SWITCH 45KVA TRANSFORMER (PNL-L1,L2)	3UV	FDR	70A/3P
ADMIN. BLDG. 75KVA TRANSFORMER	1WX	FDR	125A/3P	PLANT SITE LIFT STATION	3WX	FDR	100A/3P
space	2AD	-	-	space	2AD	-	-
space	2EH	-	-	space	2EH	-	-
SPARE C/B	2IJ	FDR	60A/3P	ODOR CONTROL SYSTEM	2IJ	FDR	40A/3P
GRIT BLOWER	2KN	MS	S1 FVNR	GRIT WASHER CLASSIFIER	2KN	MS	S1 FVNR
GRIT CHAMBER BLOWER #1	2OR	MS	S2 FVNR	GRIT CHAMBER BLOWER #2	2OR	MS	S2 FVNR
GRIT PUMP #1	2SX	MS	S3 FVNR	GRIT PUMP #2	2SX	MS	S3 FVNR
SPARE C/B	3AB	FDR	30A/3P	space	1AB	-	-
SPARE MS	3CD	MS	S1 FVNR	space	CF	-	-
space	3EH	-	-	space	1GL	-	-
space	3GL	-	-	space	1MP	-	-
space	3MP	-	-	TIE SWITCH	1QX	TIE	600A/3P
space	3QR	-	-				
INCOMING LUGS	3SX	LUGS	-				

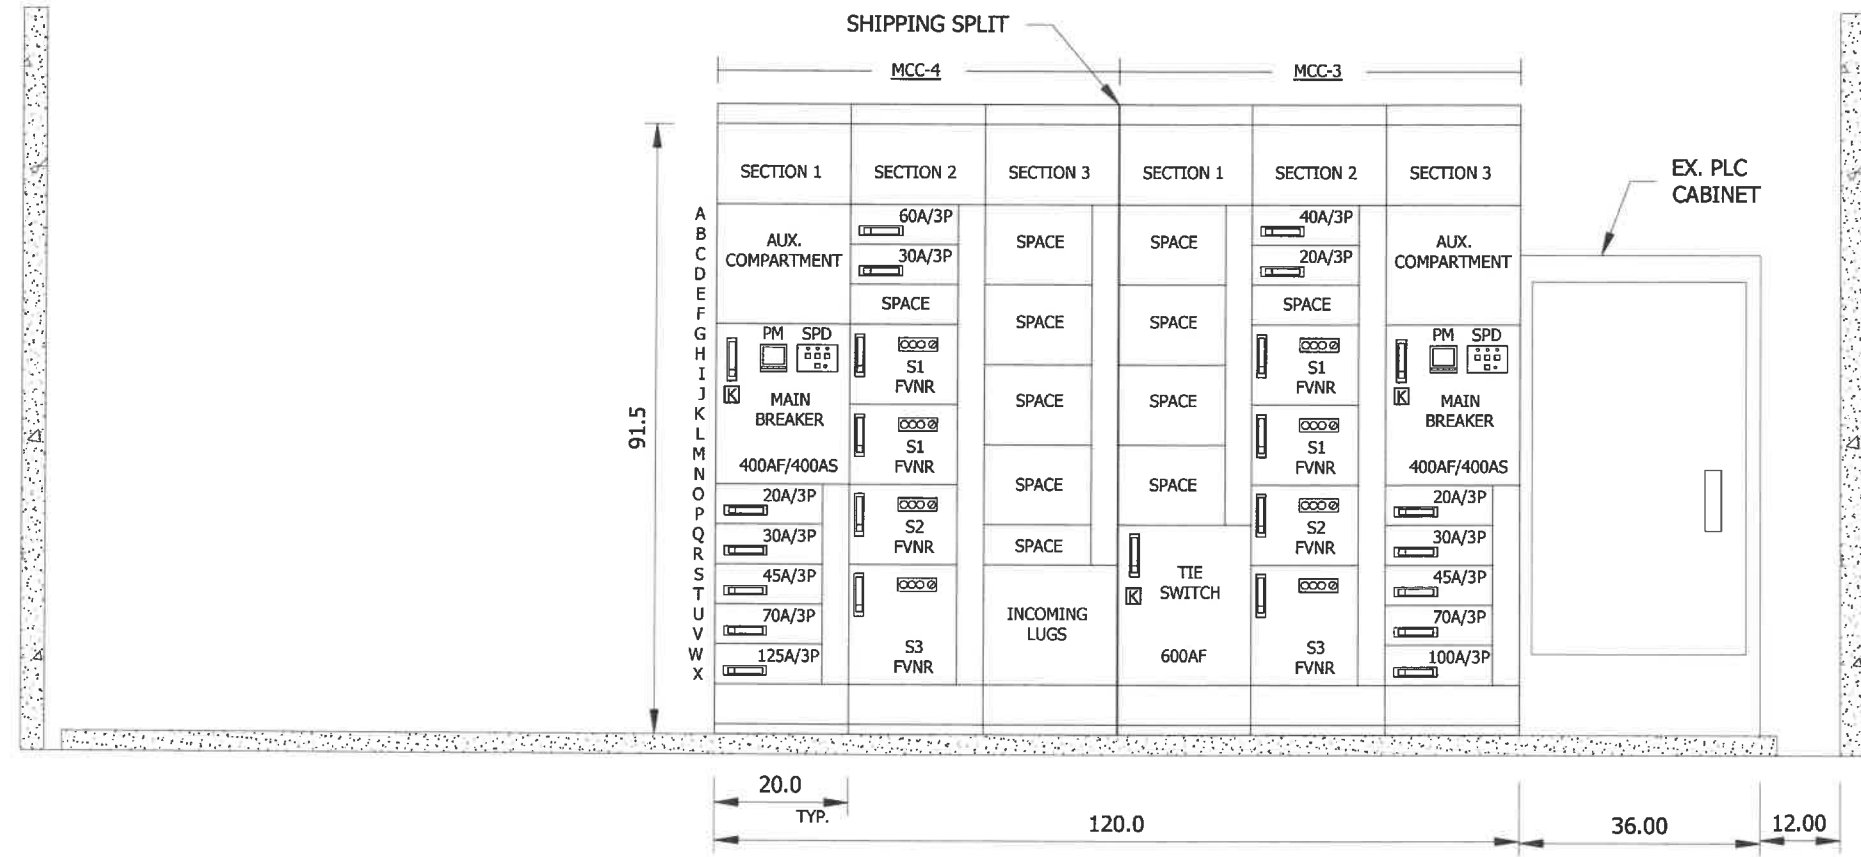


PROPOSED MCC ARRANGEMENT




EXISTING MCC ARRANGEMENT

NOTES: (##)

1. ETHERNET CABLES TO BE 600V RATED, CAT 5e, 24AWG, SHIELDED TWISTED BONDED PAIRS, BELDEN #7958A, OR EQ.

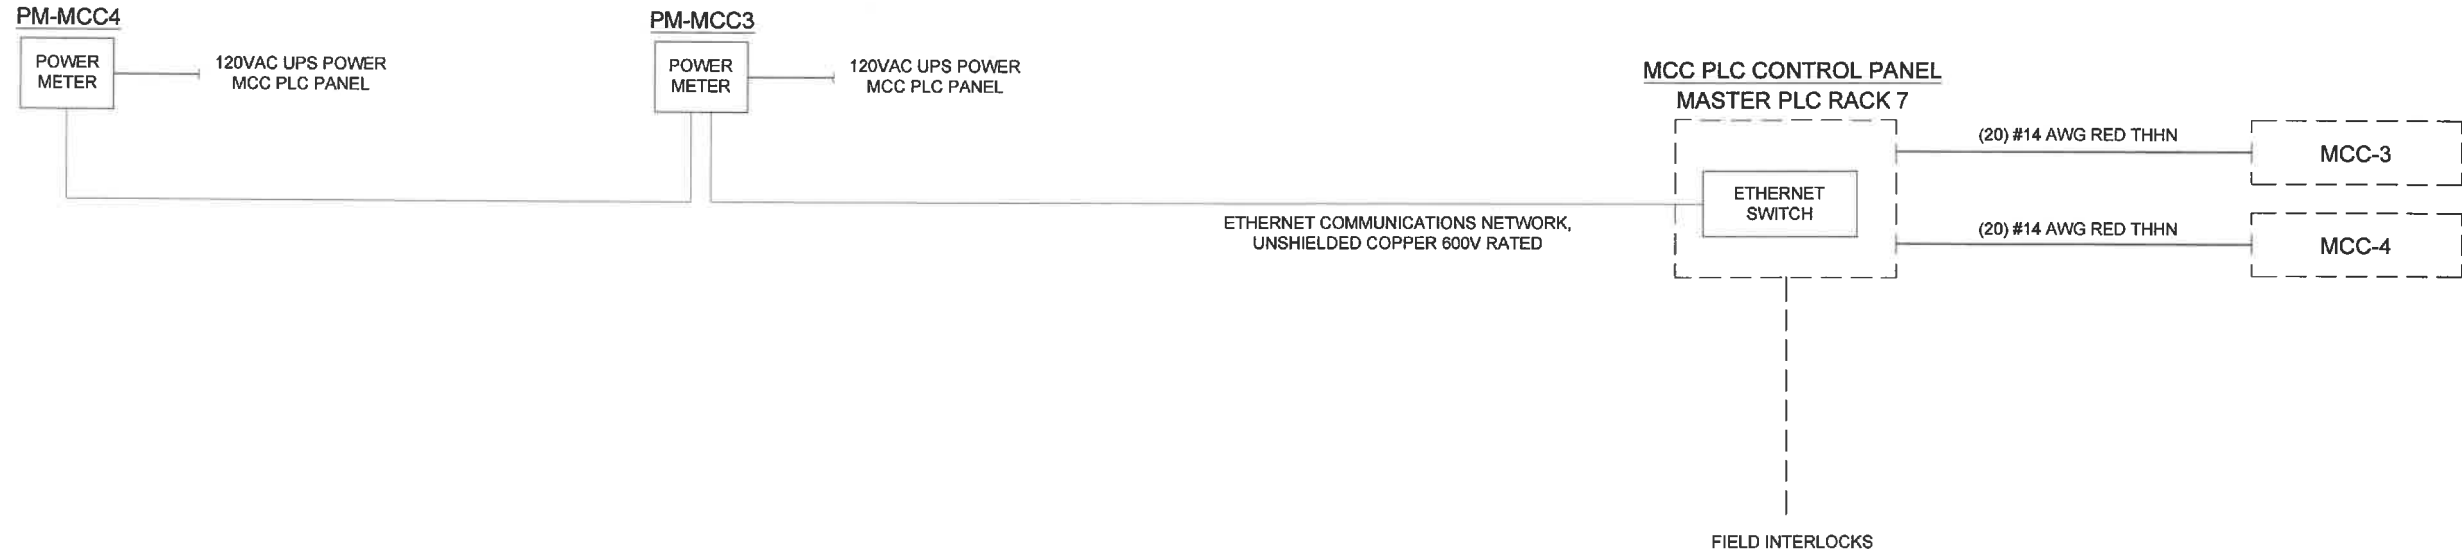

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CITY OF NAPLES WWTP
MCC REPLACEMENT
CONSTRUCTION PLANS
CITY OF NAPLES
NAPLES, FL

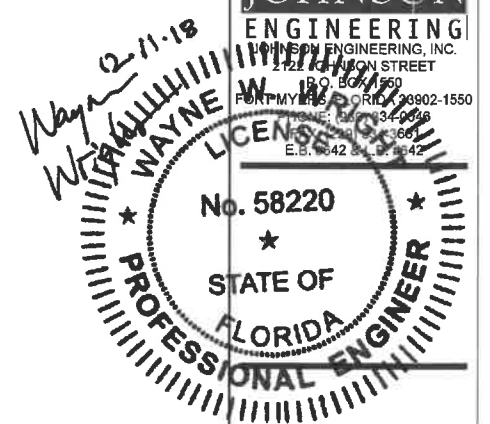NO.	DESCRIPTION	DATE



DATE: DEC. 2018
PROJECT NO. 20150110-007
FILE NO. 03-50-25
SCALE: NONE

**MCC-3 & MCC-4
NETWORK AND
INTERCONNECTION
DIAGRAM**

SHEET NUMBER
E57

MCC CONSTRUCTION STAGING PLAN PHASE 1


MCC CONSTRUCTION STAGING PLAN PHASE 2

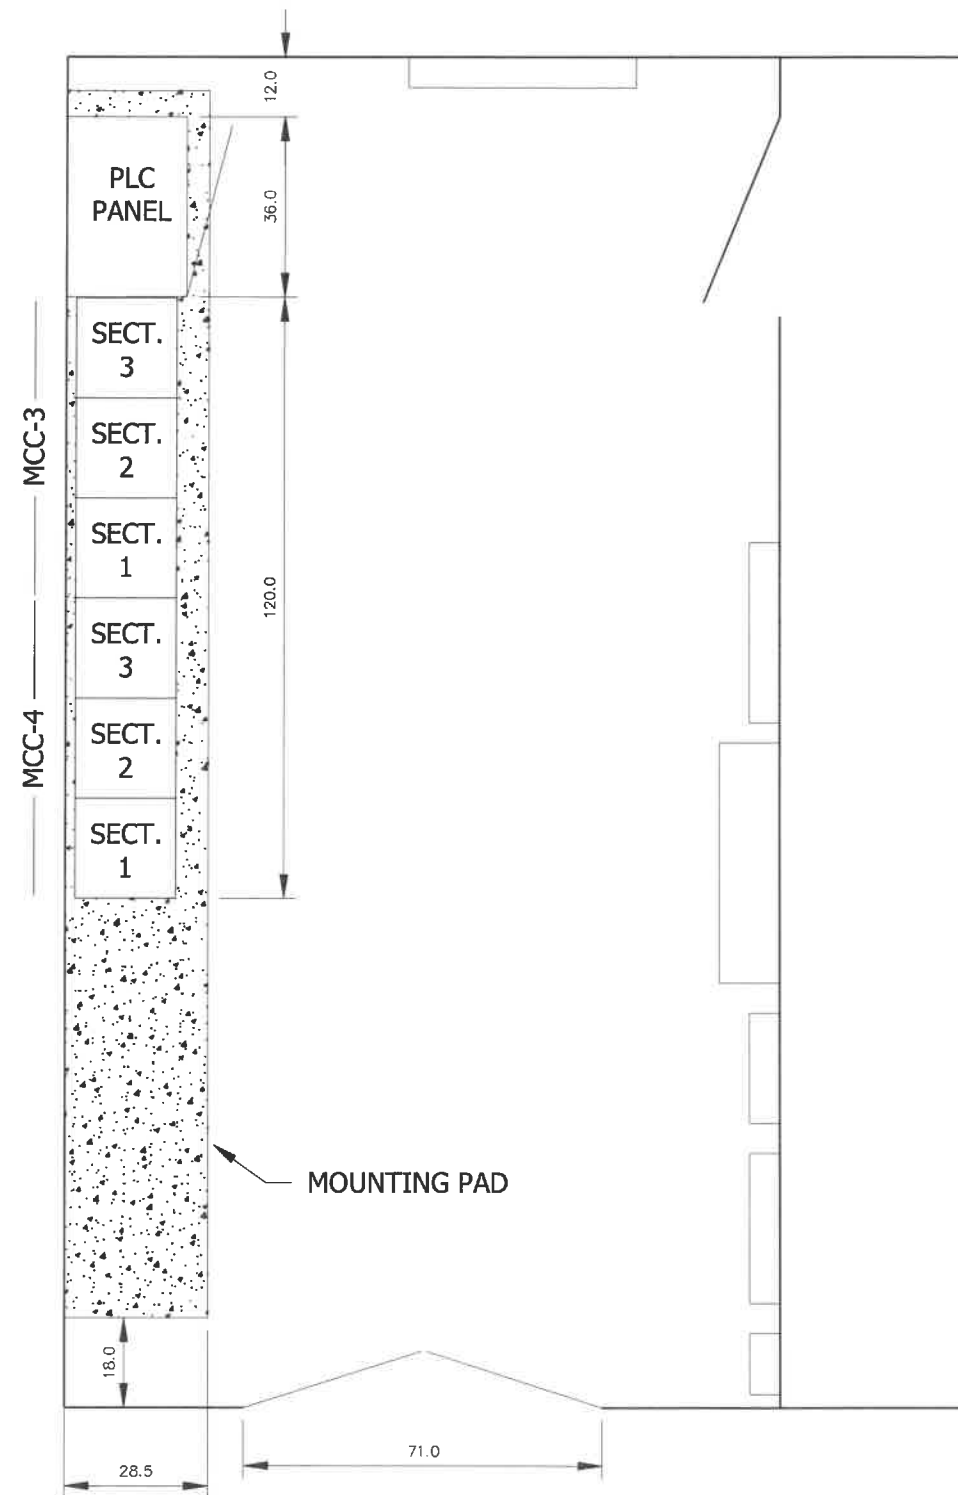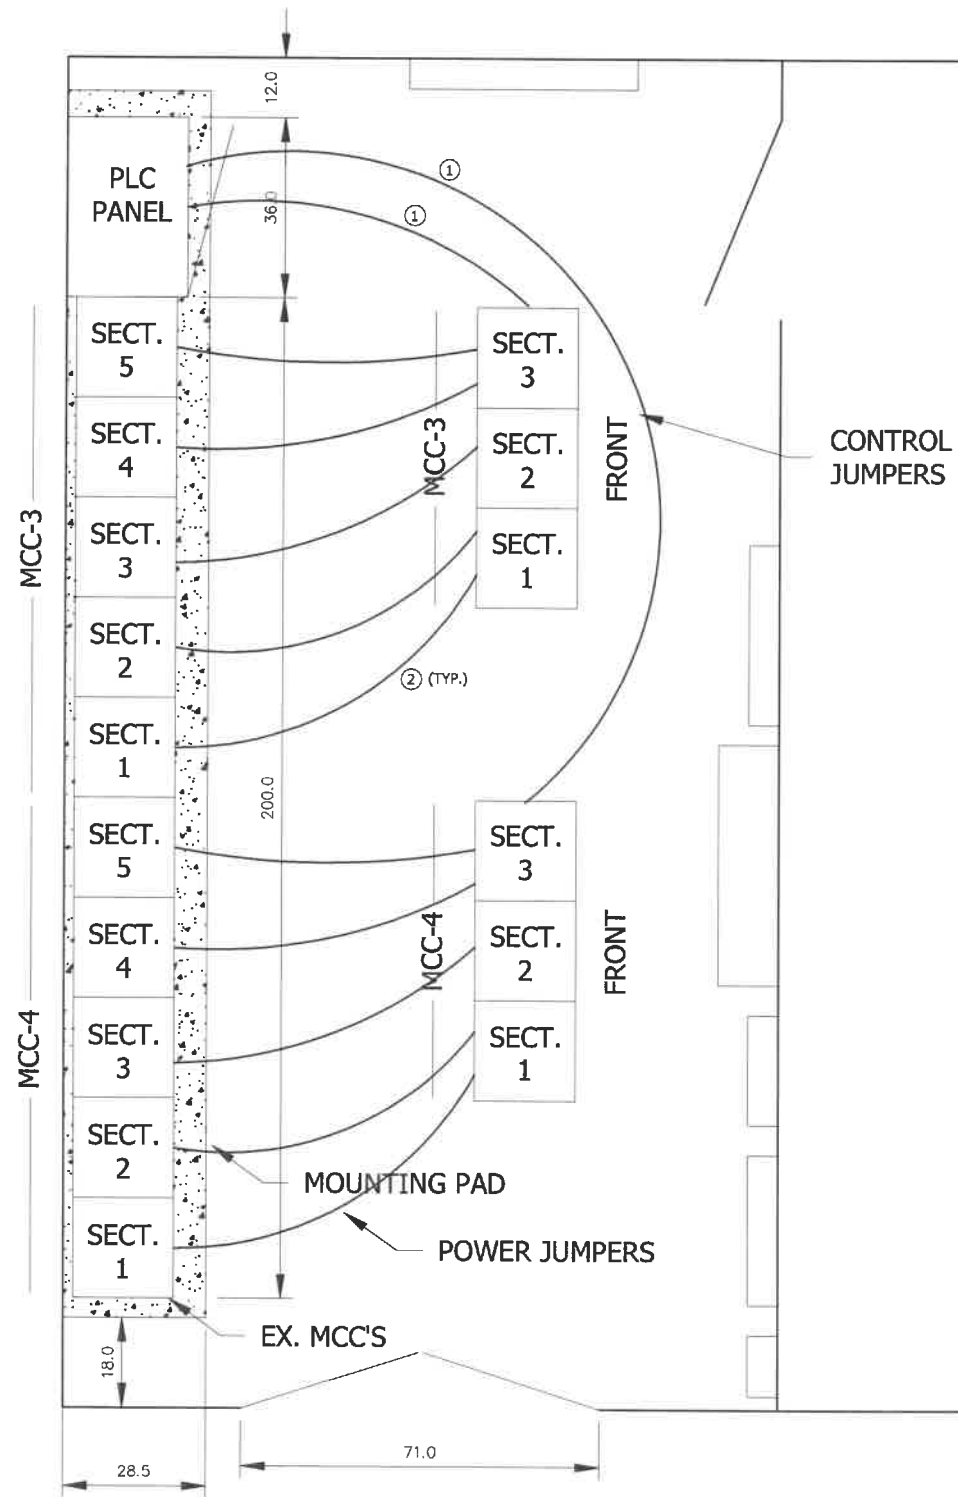

NOTES: Ⓜ

1. ROUTE NEW # 14 AWG TEMPORARY CONTROL JUMPERS TO CONTROL PANEL.
2. EXTEND TEMPORARY POWER JUMPERS FROM OLD MCC TO NEW MCC WITH POLARIS SPLICE TAPS MODEL ISR-1/0.

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 #642318

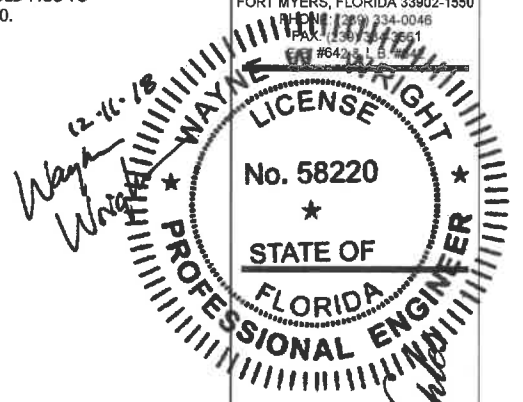

PHASE 1 STAGING SEQUENCE

OBJECTIVE: 1. PROVIDE TEMPORARY POWER TO ALL MCC LOADS.
 2. DE-ENERGIZE THE EXISTING MCC'S.


1. (TEMP.) INSTALL NEW MOTOR CONTROL CENTERS MCC-3 AND MCC-4 AS SHOWN.
 2. PREPARE AND PRE-POSITION ALL TEMP. POWER AND CONTROL EXTENSION AND INTERCONNECTING WIRING TO MCC-3, MCC-4 AND THE PLC PANEL.
 3. FEED TRANSFORMERS FROM MCC-4.
 4. * STOP OR TURN OFF ALL MCC-3 LOADS.
 5. * SHUT DOWN THE MAIN BREAKER TO MCC-3.
 6. * DE-ENERGIZE MCC-3 FROM THE UPSTREAM DISCONNECT AT MCC-1.
 7. * DISCONNECT TOP INCOMING SERVICE AND RECONNECT TO MAIN BREAKER IN NEW MCC-3.
 8. * USE TEMP. EXTENSION POWER AND CONTROL WIRING TO TEMP. RELOCATE LOADS FROM THE OLD MCC-3 TO THE NEW MCC-3.
- NOTE: ALL MCC-3 LOADS ARE TEMPORARILY POWERED FROM NEW MCC-3
9. FEED TRANSFORMERS FROM MCC-3.
 10. * STOP OR TURN OFF ALL MCC-4 LOADS.
 11. * SHUT DOWN THE MAIN BREAKER TO MCC-4.
 12. * DE-ENERGIZE MCC-4 FROM THE UPSTREAM DISCONNECT AT MCC-2.
 13. * DISCONNECT TOP INCOMING SERVICE AND RECONNECT TO MAIN BREAKER IN NEW MCC-4.
 14. * USE TEMP. EXTENSION POWER AND CONTROL WIRING TO TEMP. RELOCATE LOADS FROM THE OLD MCC-4 TO THE NEW MCC-4.
- NOTE: ALL MCC-3 AND MCC-4 LOADS ARE TEMPORARILY POWERED FROM NEW MCC-3 AND MCC-4. EX. MCC-3 AND EX. MCC-4 ARE COMPLETELY DE-ENERGIZED.

PHASE 2 STAGING SEQUENCE

OBJECTIVE: 1. DEMO EXISTING MCC'S
 2. INSTALL NEW MCC'S
 3. REINSTALL AND COMMISSION ALL LOADS.

1. DEMO EXISTING MCC-3 AND MCC-4.
2. FEED TRANSFORMERS FROM MCC-4.
3. * DE-ENERGIZE TEMP. NEW MCC-3 AND COMPLETE INSTALLATION OF NEW MCC-3.
4. COMMISSION NEW MCC-3
5. FEED TRANSFORMERS FROM MCC-3.
6. * DE-ENERGIZE TEMP. NEW MCC-4 AND COMPLETE INSTALLATION OF NEW MCC-4.
7. COMMISSION NEW MCC-4 AND ENTIRE SYSTEM.

* LIMITED EQUIPMENT OUTAGE PERIOD

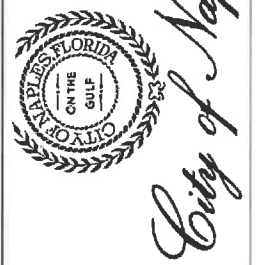

CITY OF NAPLES WWTP
 MCC REPLACEMENT
 CONSTRUCTION PLANS
 CITY OF NAPLES
 NAPLES, FL


REVISIONS	DATE
DESCRIPTION	

NO.
 DATE: DEC. 2018
 PROJECT NO. 20150110-007
 FILE NO. 03-50-25
 SCALE: 1" = 40'

MCC - CONSTRUCTION STAGING PLAN


SHEET NUMBER

E58

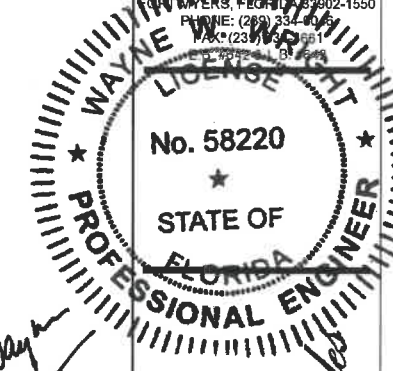

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12-16-18
City of Naples

To prevent paralleling of lines A and B. Two loads, fed from either source.

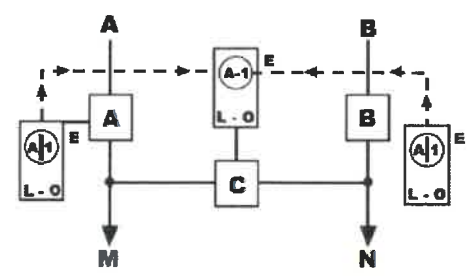


Breaker A is closed to supply load M. Breaker B is closed to supply load N. Tie-breaker C is open. Keys A-1 are held in interlocks on both breakers A and B. Tie-breaker C cannot be closed unless either A or B is locked open.

To transfer load N to breaker A:




1. Open breaker B
2. Turn key A-1 in L-O Interlock on breaker B to lock open. Key A-1 is now free.
3. Insert key A-1 in L-O Interlock on tie-breaker C and turn to unlock. Key A-1 is now held.
4. Close tie-breaker C.

Reverse sequence to restore service.

Load M can be supplied through breaker B in a similar manner.

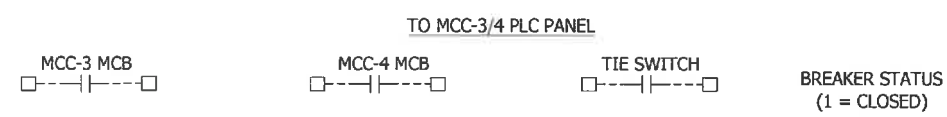

MCC-3 AND MCC-4 KEY INTERLOCK [K] SCHEME

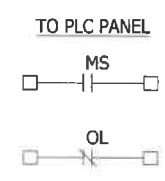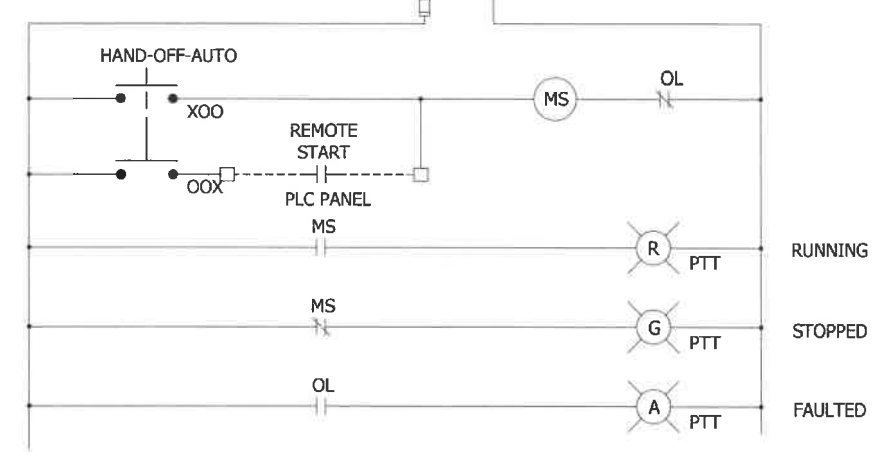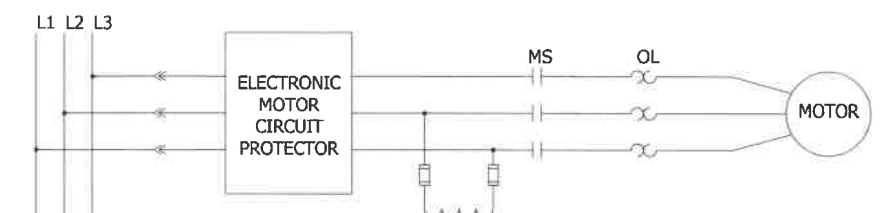

MOTOR CONTROL CENTER FVNR MOTOR STARTER WIRING DIAGRAM (TYP.)

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CONSTRUCTION PLANS
CITY OF NAPLES
NAPLES, FL

NO.	DATE	DESCRIPTION



DATE: DEC. 2018
PROJECT NO. 20150110-007
FILE NO. 03-50-25
SCALE: AS SHOWN

ELECTRICAL DETAILS

SHEET NUMBER
ED51

TETRA TECH
www.tetratech.com
710 ANDRUS DRIVE
NAPLES, FLORIDA 34109
PHONE: (239) 439-8800

Wayne Wright
12.11.18

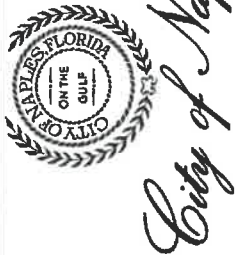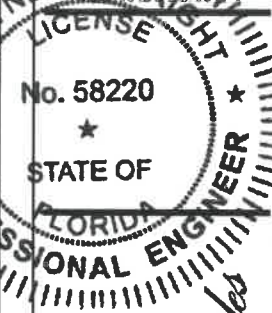

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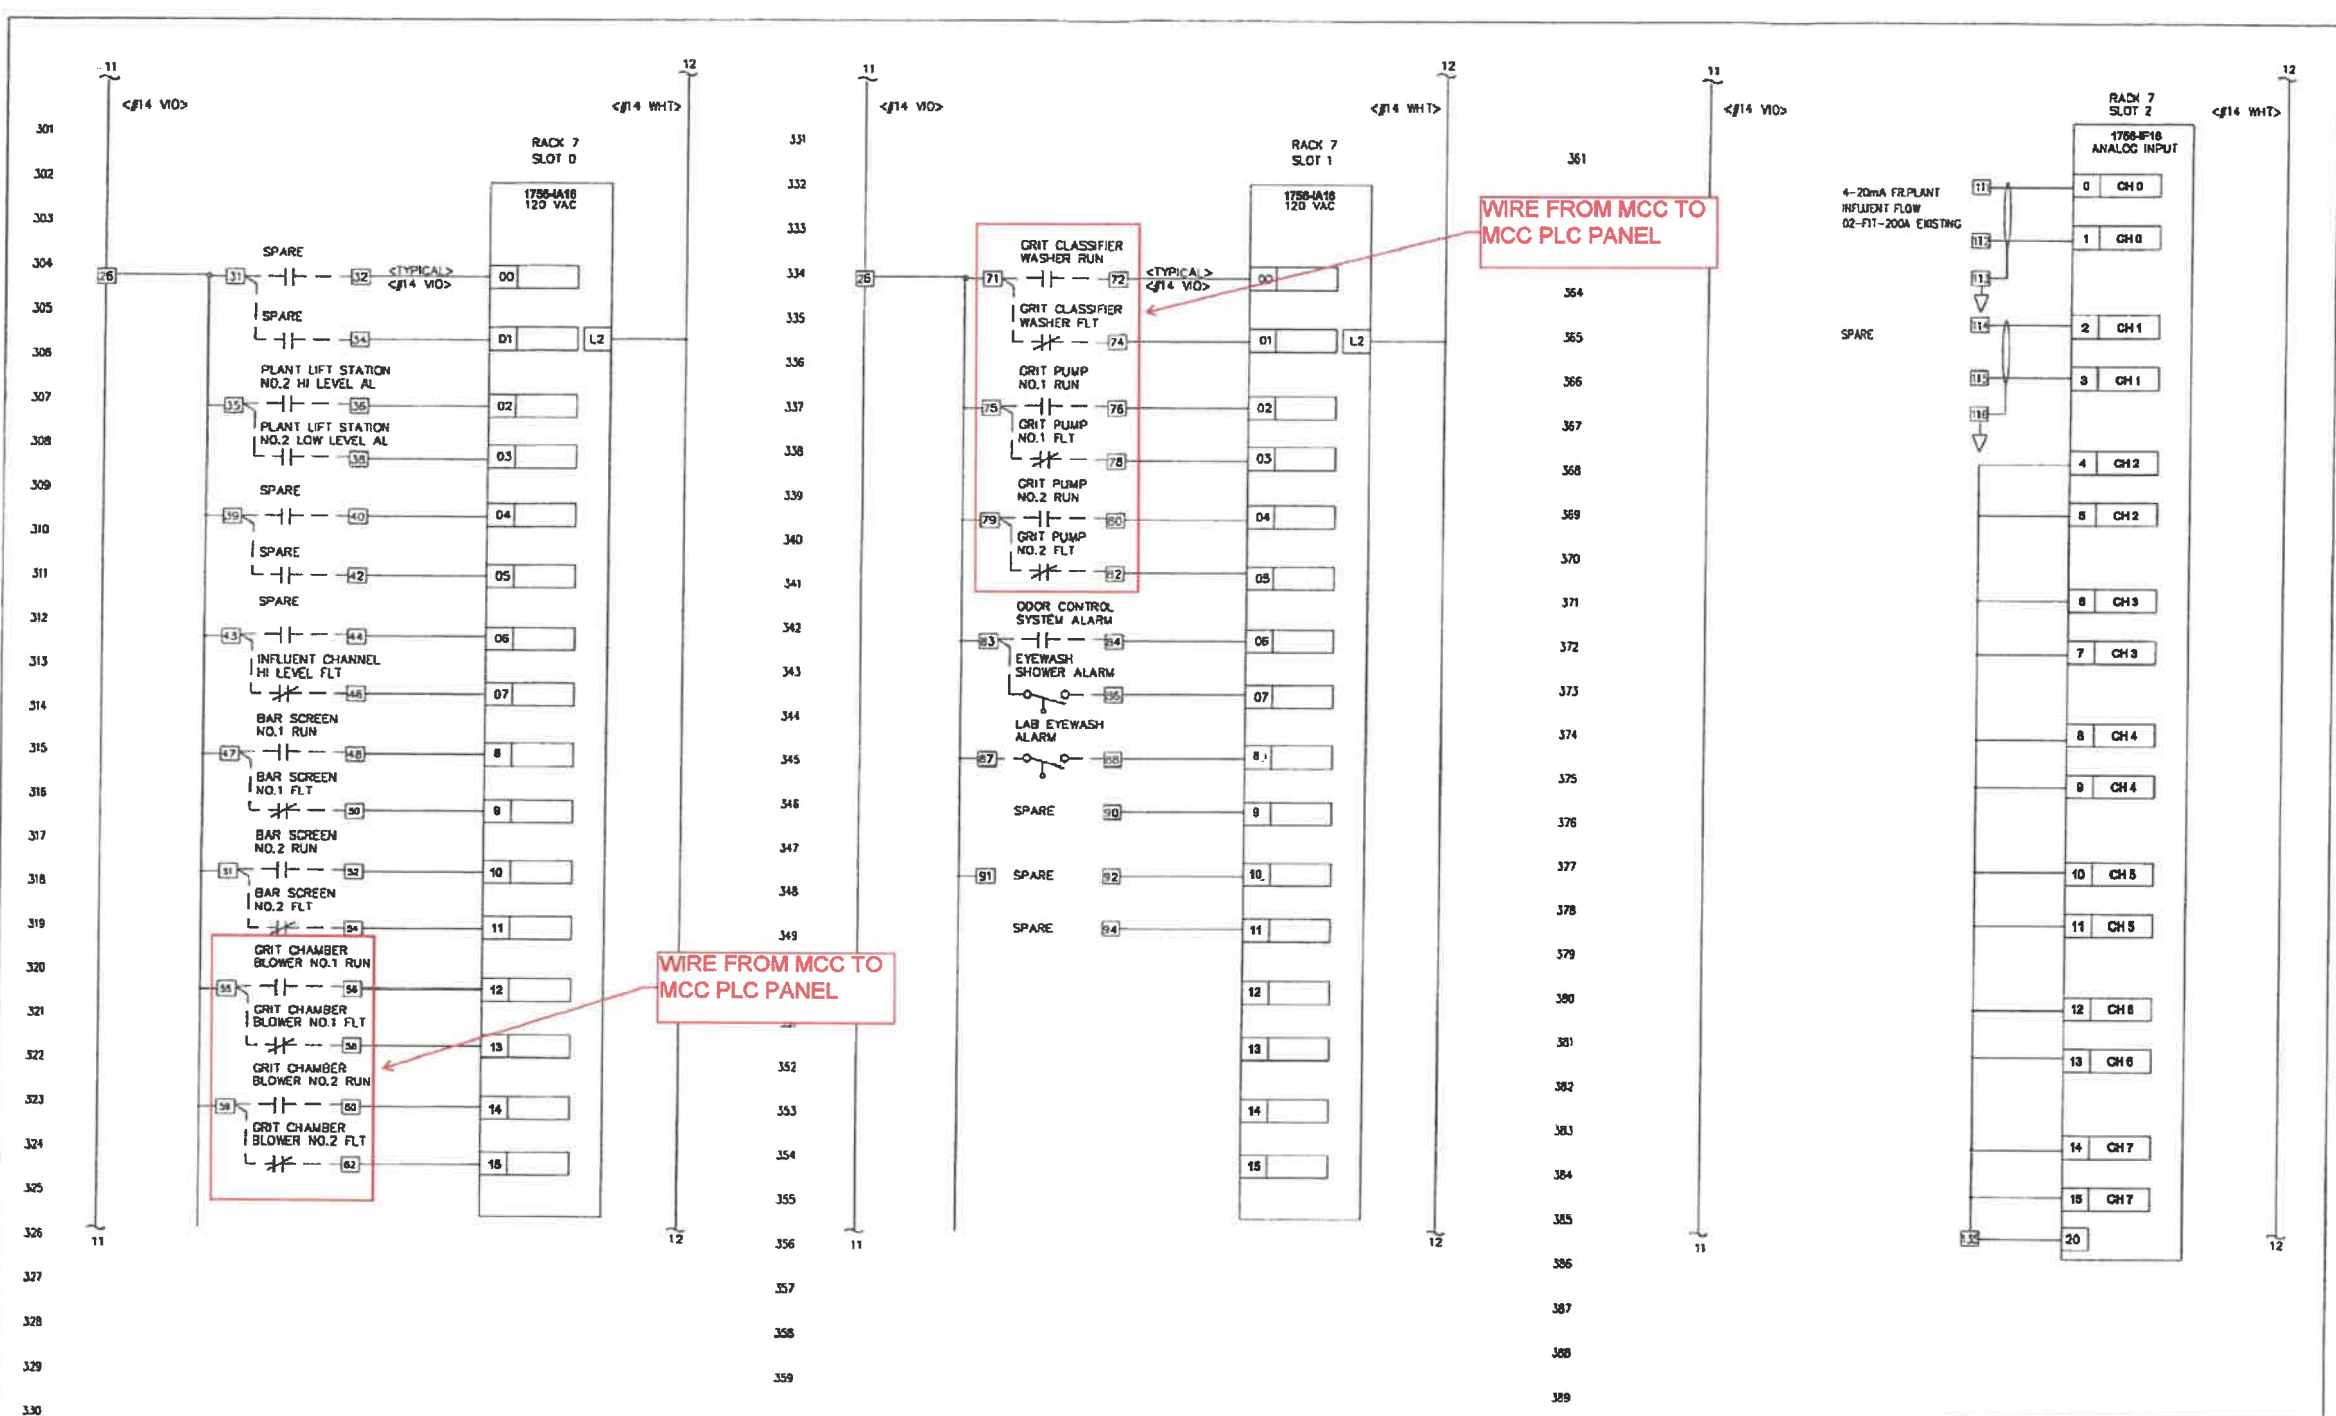
NO.	DATE	DESCRIPTION

DATE: DEC. 2018
PROJECT NO. 20150110-007
FILE NO. 03-50-25
SCALE: AS SHOWN

(REF) EX. MCC PLC PANEL SCHEMATIC

SHEET NUMBER

ER51



REV	DESCRIPTION	BY	DATE	ISSUE DATES
3	AS BUILT UPDATE		12/18/18	
1	PDR ENG. COMMENTS		11/15/18	7/10/15/17

PROJECT: CITY OF NAPLES 1099-323-9

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ANVIC
 TITLE: OLD PLANT ELECTRICAL BUILDING REMOTE I/O CONTROL PANEL
 PROJECT: CITY OF NAPLES 1099-323-9
 SHEET 3 OF 3
 DRAWING NUMBER

CITY OF NAPLES, FLORIDA
WWTP PLC-6 REPLACEMENT
OLD PLANT ELECTRICAL BUILDING
I/O CONTROL PANEL

Project No.: 200-08818-10002
Designed By: MSJ
Drawn By: JLB
Checked By: GCI

E-27

Bar Measures 1 Inch

NOTES:
1. THIS DRAWING IS PROVIDED FOR REFERENCE ONLY.



EX. MCC-3 AND MCC-4
UNIFORM BLDG.



EX. MCC PLC CONTROL PANEL
UNIFORM BLDG.



EQUIPMENT ACCESS AND CONDUIT RACEWAY
UNIFORM BLDG.



EX MCC-3 INCOMING TOP-ENTRY FEEDER
UNIFORM BLDG.

JOHNSON

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WAYNE WRIGHT
LICENSE
No. 58220
STATE OF
FLORIDA
PROFESSIONAL ENGINEER
Wayne Wright 12.11.18
City of Naples

CITY OF NAPLES WWTP
SWITCHGEAR REPLACEMENT
CONSTRUCTION PLANS
CITY OF NAPLES
NAPLES, FL

REVISIONS	DATE
DESCRIPTION	
NO.	

DATE: DEC. 2018
PROJECT NO. 20150110-007
FILE NO. 03-50-25
SCALE: AS SHOWN

(REF) PHOTOS

SHEET NUMBER

ER52