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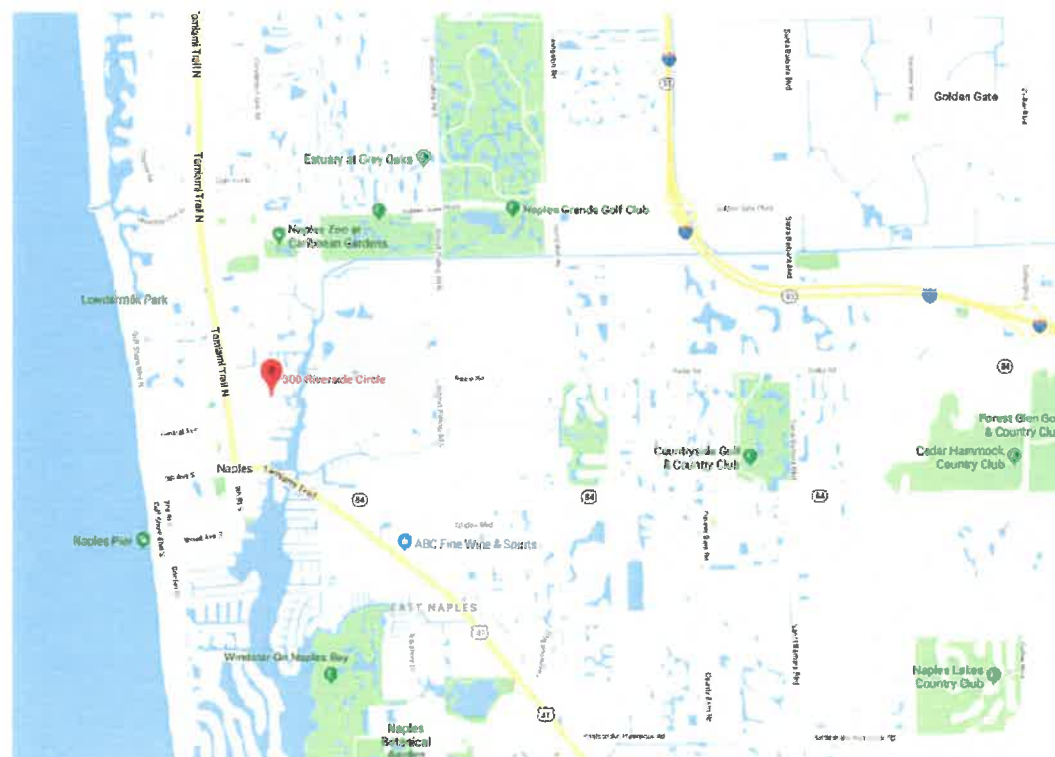
REFERENCE

- ER01 - (REF) EX. SWITCHGEAR SINGLE LINE DIAGRAM
- ER02 - (REF) EX. CONTROL CABINET JB
- ER03 - (REF) EX. INSTRU. CABINET JB
- ER04 - (REF) PHOTOS
- ER05 - (REF) PHOTOS

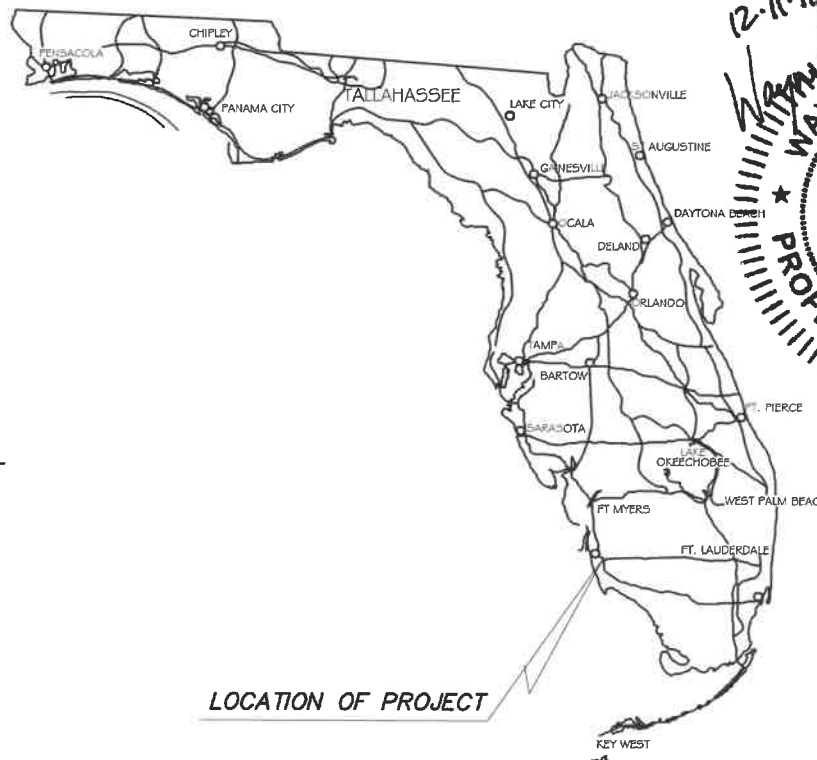
**CONSTRUCTION PLANS  
CITY OF NAPLES WWTP  
SWITCHGEAR REPLACEMENT  
FOR  
CITY OF NAPLES**

LOCATED IN  
SECTION 03, TOWNSHIP 50 SOUTH, RANGE 25 EAST  
**NAPLES, FL**  
**DEC. 2018**

CITY OF NAPLES REQUISITION NO. 11014



**LOCATION MAP**



LOCATION OF PROJECT



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CITY OF NAPLES WWTP  
SWITCHGEAR REPLACEMENT  
CONSTRUCTION PLANS  
CITY OF NAPLES  
NAPLES, FL

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DATE: DEC. 2018  
PROJECT NO. 20150110-007  
FILE NO. 03-50-25  
SCALE: NONE

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PROJECT COVER SHEET

SHEET NUMBER  
**E00**

ABBREVIATIONS

|         |                                  |
|---------|----------------------------------|
| A       | AMPERES, AMBER OR ALARM          |
| AH      | AMP HOUR OR ALARM HORN           |
| AL      | ALARM LIGHT                      |
| ALM     | ALARM                            |
| ASR     | ALARM SILENCE RELAY              |
| AHU     | AIR HANDLING UNIT                |
| AIC     | AMPS INTERRUPTING CURRENT        |
| ATS     | AUTOMATIC TRANSFER SWITCH        |
| AUX     | AUXILIARY                        |
| BAT     | BATTERY                          |
| BPC     | BACKUP PUMP CONTROLLER           |
| BOM     | BILL OF MATERIAL                 |
| CB      | CIRCUIT BREAKER                  |
| C       | CONDUIT                          |
| CP      | CONTROL PANEL                    |
| CPSA    | CONTROL PANEL SURGE ARRESTOR     |
| CT      | CURRENT TRANSFORMER              |
| CU      | COPPER                           |
| DISC    | DISCONNECT                       |
| DO      | DIGITAL OUTPUT                   |
| DPDT    | DOUBLE POLE DOUBLE THROW         |
| DPST    | DOUBLE POLE SINGLE THROW         |
| EG      | EQUIPMENT GROUND                 |
| ETM     | ELAPSED TIME METER               |
| F       | FUSE                             |
| FLT     | FAULT                            |
| FPL     | FLORIDA POWER AND LIGHT          |
| FMC     | FLEXIBLE METALLIC CONDUIT        |
| FS      | FLOAT SWITCH                     |
| GEN     | GENERATOR                        |
| GFCI    | GROUND FAULT CIRCUIT INTERRUPTER |
| GND, G  | GROUND                           |
| GRS     | GALVANIZED RIGID STEEL           |
| H       | HIGH                             |
| HS      | HAND SWITCH                      |
| HOA     | HAND-OFF-AUTOMATIC               |
| HOR     | HAND-OFF-REMOTE                  |
| HMI     | HUMAN MACHINE INTERFACE          |
| I       | INDICATOR                        |
| I&C     | INSTRUMENTATION & CONTROL        |
| INTR    | INTRUSION                        |
| JB      | JUNCTION BOX                     |
| L       | LEVEL OR LOW                     |
| LR      | LINE REACTOR                     |
| NEUT, N | NEUTRAL                          |
| NTS     | NOT TO SCALE                     |
| O/C     | OPEN / CLOSE                     |
| OIT     | OPERATOR INTERFACE TERMINAL      |
| MOV     | MOTOR OPERATED VALVE             |
| MSC     | MANUFACTURER'S SUPPLIED CABLE    |
| NF      | NON-FUSIBLE                      |
| P       | PRESSURE                         |
| PB      | PUSHBUTTON                       |
| PLC     | PROGRAMMABLE LOGIC CONTROLLER    |
| PH, Ø   | PHASE                            |
| PC      | PHOTOCELL                        |
| PCP     | PUMP CONTROL PANEL               |
| PM      | PHASE MONITOR                    |
| PS      | POWER SUPPLY                     |
| PTT     | PUSH-TO-TEST                     |
| Q       | TOTALIZER                        |
| RECPT.  | RECEPTACLE                       |
| R       | RELAY, TREND, RESISTOR           |
| RTU     | REMOTE TELEMETRY UNIT            |
| SCCR    | SHORT CIRCUIT CURRENT RATING     |
| SHLD    | SHIELDED                         |
| SPD     | SURGE PROTECTION DEVICE          |
| S       | SWITCH                           |
| SS      | SELECTOR SWITCH                  |
| SSOL    | SOLID STATE OVERLOAD             |
| SV      | SOLENOID VALVE                   |
| TB      | TERMINAL BLOCK                   |
| TD      | TIME DELAY                       |
| TSP     | TWISTED SHIELDED PAIR            |
| UG      | UNDERGROUND                      |
| UPS     | UNINTERRUPTABLE POWER SUPPLY     |
| VFD     | VARIABLE FREQUENCY DRIVE         |
| XFMR    | TRANSFORMER                      |
| Z       | POSITION                         |

SYMBOLS

|  |   |
|--|---|
|  | MAGNETIC FLOW INDICATING TRANSMITTER  |
|  | PRESSURE INDICATING TRANSMITTER   |
|  | FLOW INDICATING TRANSMITTER   |
|  | FLOW ELEMENT  |
|  | LEVEL (FLOAT) SWITCH  |
|  | PRESSURE SWITCH   |
|  | FLOW SWITCH   |
|  | MOTOR OPERATED VALVE (MOV)  |
|  | SOLENOID VALVE (SV)   |
|  | SOLENOID VALVE (SV)   |
|  | DIAPHRAGM VALVE   |
|  | VOLTMETER   |
|  | AMMETER   |
|  | GROUND FAULT INTERRUPTER  |
|  | DRAW-OUT CIRCUIT BREAKER  |
|  | CIRCUIT BREAKER WITH TRIP RATING  |
|  | MOTOR WITH HP RATING  |
|  | EQUIPMENT GROUND  |
|  | DRIVEN ROD-TYPE GROUNDING ELECTRODE   |
|  | DRIVEN ROD-TYPE GROUNDING ELECTRODE WITH GROUND ACCESS WELL   |
|  | NON-FUSIBLE DISCONNECT SWITCH, 30A, 3P UNLESS OTHERWISE INDICATED                                   |
|  | CURRENT TRANSFORMER   |
|  | TRANSFORMER   |
|  | CONDUIT OR WIRE ROUTING;<br>SHORT HASH MARK = PHASE CONDUCTOR<br>LONG HASH MARK = NEUTRAL CONDUCTOR |
|  | MOTOR OVERLOAD (EUTECTIC ALLOY)   |
|  | AC/DC POWER SUPPLY  |
|  | SURGE SUPPRESSOR (PROTECTED/UNPROTECTED)  |
|  | FUSED LEVER-TYPE TERMINAL BLOCK WITH LED INDICATOR  |
|  | CT SHORTING BAR   |

|  |  |
|--|--|
|  | DUPLEX RECEPTACLE                      |
|  | NORMALLY OPEN CONTACT                  |
|  | NORMALLY CLOSED CONTACT                |
|  | LIMIT SWITCH, NORMALLY OPEN            |
|  | LIMIT SWITCH, NORMALLY CLOSED          |
|  | PRESSURE SWITCH, NORMALLY OPEN         |
|  | PRESSURE SWITCH, NORMALLY CLOSED       |
|  | FLOAT SWITCH, NORMALLY OPEN            |
|  | FLOAT SWITCH, NORMALLY CLOSED          |
|  | FLOW SWITCH, NORMALLY OPEN             |
|  | FLOW SWITCH, NORMALLY CLOSED           |
|  | TEMP. SWITCH, NORMALLY OPEN            |
|  | TEMP. SWITCH, NORMALLY CLOSED          |
|  | NORMALLY OPEN TIMED TO CLOSE CONTACT   |
|  | NORMALLY CLOSED TIMED TO OPEN CONTACT  |
|  | NORMALLY CLOSED TIMED TO CLOSE CONTACT |
|  | NORMALLY OPEN TIMED TO OPEN CONTACT    |
|  | LIMIT SWITCH                           |
|  | TORQUE SWITCH                          |
|  | PRESSURE SWITCH                        |
|  | VIBRATION SWITCH                       |
|  | ALARM RELAY                            |
|  | CONTROL RELAY                          |
|  | MOTOR STARTER                          |
|  | TIMING RELAY                           |
|  | INDICATING LIGHT WITH COLOR            |
|  | NORMALLY OPEN PUSHBUTTON               |
|  | NORMALLY CLOSED PUSHBUTTON             |
|  | MAINTAINED SWITCH                      |
|  | FUSE WITH RATING                       |
|  | REMOTE TERMINAL POINT                  |
|  | HORN                                   |
|  | PUMP                                   |
|  | TERMINAL BLOCK                         |
|  | KEY INTERLOCK                          |

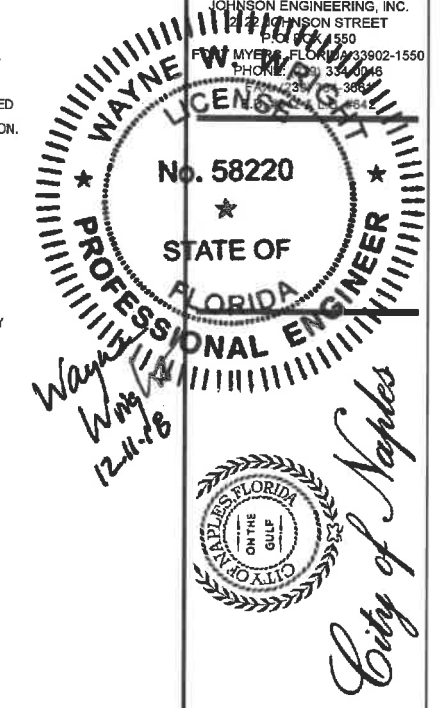
PROJECT ELECTRICAL NOTES

- ALL DEMOED EQUIPMENT SHALL BE DISPOSED OF BY THE CONTRACTOR.
- SEE SPECIFICATIONS FOR CONSTRUCTION STAGING SCHEDULE, DETAILS, PROCEDURES AND LIMITATIONS ON EQUIPMENT UNAVAILABILITY.

GENERAL ELECTRICAL NOTES

- ALL NEW CONSTRUCTION SHALL COMPLY WITH APPLICABLE N.E.C. AND LOCAL CODES.
- CONDUCTORS SHALL NOT BE SPLICED.
- ALL MULTICONDUCTOR CONTROL CABLE SHALL BE #14 AWG XHHW-2, OMNISCABLE P/N AF114XX, OR EQ.
- ALL BELOW GRADE CONDUIT RUNS SHALL BE IN SCHEDULE 80 PVC CONDUIT UNLESS NOTED OTHERWISE. ALL ABOVE GRADE CONDUIT RUNS SHALL BE IN RIGID ALUMINUM CONDUIT UNLESS NOTED OTHERWISE. PROVIDE PVC CONDUIT SLEEVE AROUND CONDUIT PENETRATIONS IN CONCRETE FOR PROTECTION.
- ALL BONDING CONDUCTORS SHALL BE ROUTED IN SCHEDULE 80 PVC CONDUIT.
- ALL CONDUIT RACEWAYS SHALL HAVE AN INSULATED COPPER SYSTEM GROUND CONDUCTOR THROUGHOUT THE ENTIRE LENGTH OF THE CIRCUIT INSTALLED PER N.E.C.
- ALL CONDUIT RACEWAYS WHICH ARE INSTALLED FOR FUTURE USE SHALL HAVE A NYLON PULLCORD.
- PVC CONDUIT JOINTS SHALL BE SOLVENT-WELDED, EXCEPT FOR RIGID METALLIC TO PVC COUPLINGS.
- MINIMUM CONDUIT SIZE SHALL BE 3/4".
- ALL CONDUIT RACEWAYS SHALL BE RUN IN NEAT AND WORKMANLIKE MANNER AND SHALL BE PROPERLY SUPPORTED PER N.E.C.
- ALL CONNECTIONS TO MOTORS AND OTHER VIBRATING EQUIPMENT OR AT OTHER LOCATIONS WHERE REQUIRED SHALL BE MADE WITH FLEXIBLE LIQUID-TIGHT STEEL CONDUIT 1/2" TO 3/8" IN LENGTH.
- ALL FEEDER AND BRANCH CIRCUIT WIRING SHALL BE COLOR CODED AS FOLLOWS:  
3-PHASE 480Y/277VAC (A/B/C/N/G) : PUR/BRN/YEL/WHT/GRN  
3-PHASE 240/120VAC (A/B(HI)/C/N/G) : BLK/RED(ORG)/BLU/WHT/GRN  
1-PHASE AC POWER : BLK, 12 AWG MIN.  
AC POWER HOT : BLK, 12 AWG MIN.  
AC POWER NEUTRAL : WHT, 12 AWG MIN.  
AC SWITCHED : RED, 16 AWG MIN.  
EXTERNALLY POWERED : YEL, 16 AWG MIN.  
GROUND : GRN, 12 AWG MIN.  
DC + : BLU, 16 AWG MIN.  
DC - : BLU WITH WHT STRIPE, 16 AWG MIN.  
TSP (+/-) : RED/BLK, 16 AWG. MIN., BELDEN 1118A, OR EQ.
- ALL CONDUCTORS SHALL BE 600-VOLT RATED, STRANDED COPPER.
- ETHERNET CABLE SHALL BE CAT-5e 600V UL AWM RATED
- ALL WIRES AND CABLES SHALL BE MARKED USING WHITE HEAT SHRINK MARKERS.
- BRANCH CIRCUITS EXCEEDING 75' SHALL BE WIRED WITH MINIMUM #10AWG WIRE.
- COORDINATE ALL SERVICE ENTRANCE WORK WITH THE LOCAL ELECTRIC UTILITY AND ADHERE TO ALL UTILITY STANDARDS.
- CONTRACTOR SHALL BE RESPONSIBLE FOR PERFORMING THE WORK AND FURNISHING ALL MATERIALS OUTLINED IN THESE PLANS AND ANY OTHER MATERIALS AND WORK NECESSARY FOR A FULLY OPERATIONAL SYSTEM.

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CITY OF NAPLES WWTP  
SWITCHGEAR REPLACEMENT  
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CITY OF NAPLES  
NAPLES, FL

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SCALE: NONE

NOTES & SYMBOLS

SHEET NUMBER

E01



ELECTRICAL ROOM #1  
SWITCHGEAR-1 AND GENERATOR-1



ADMIN. BUILDING

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*Wayne*  
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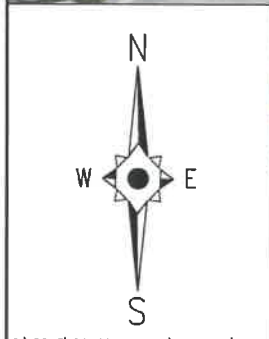
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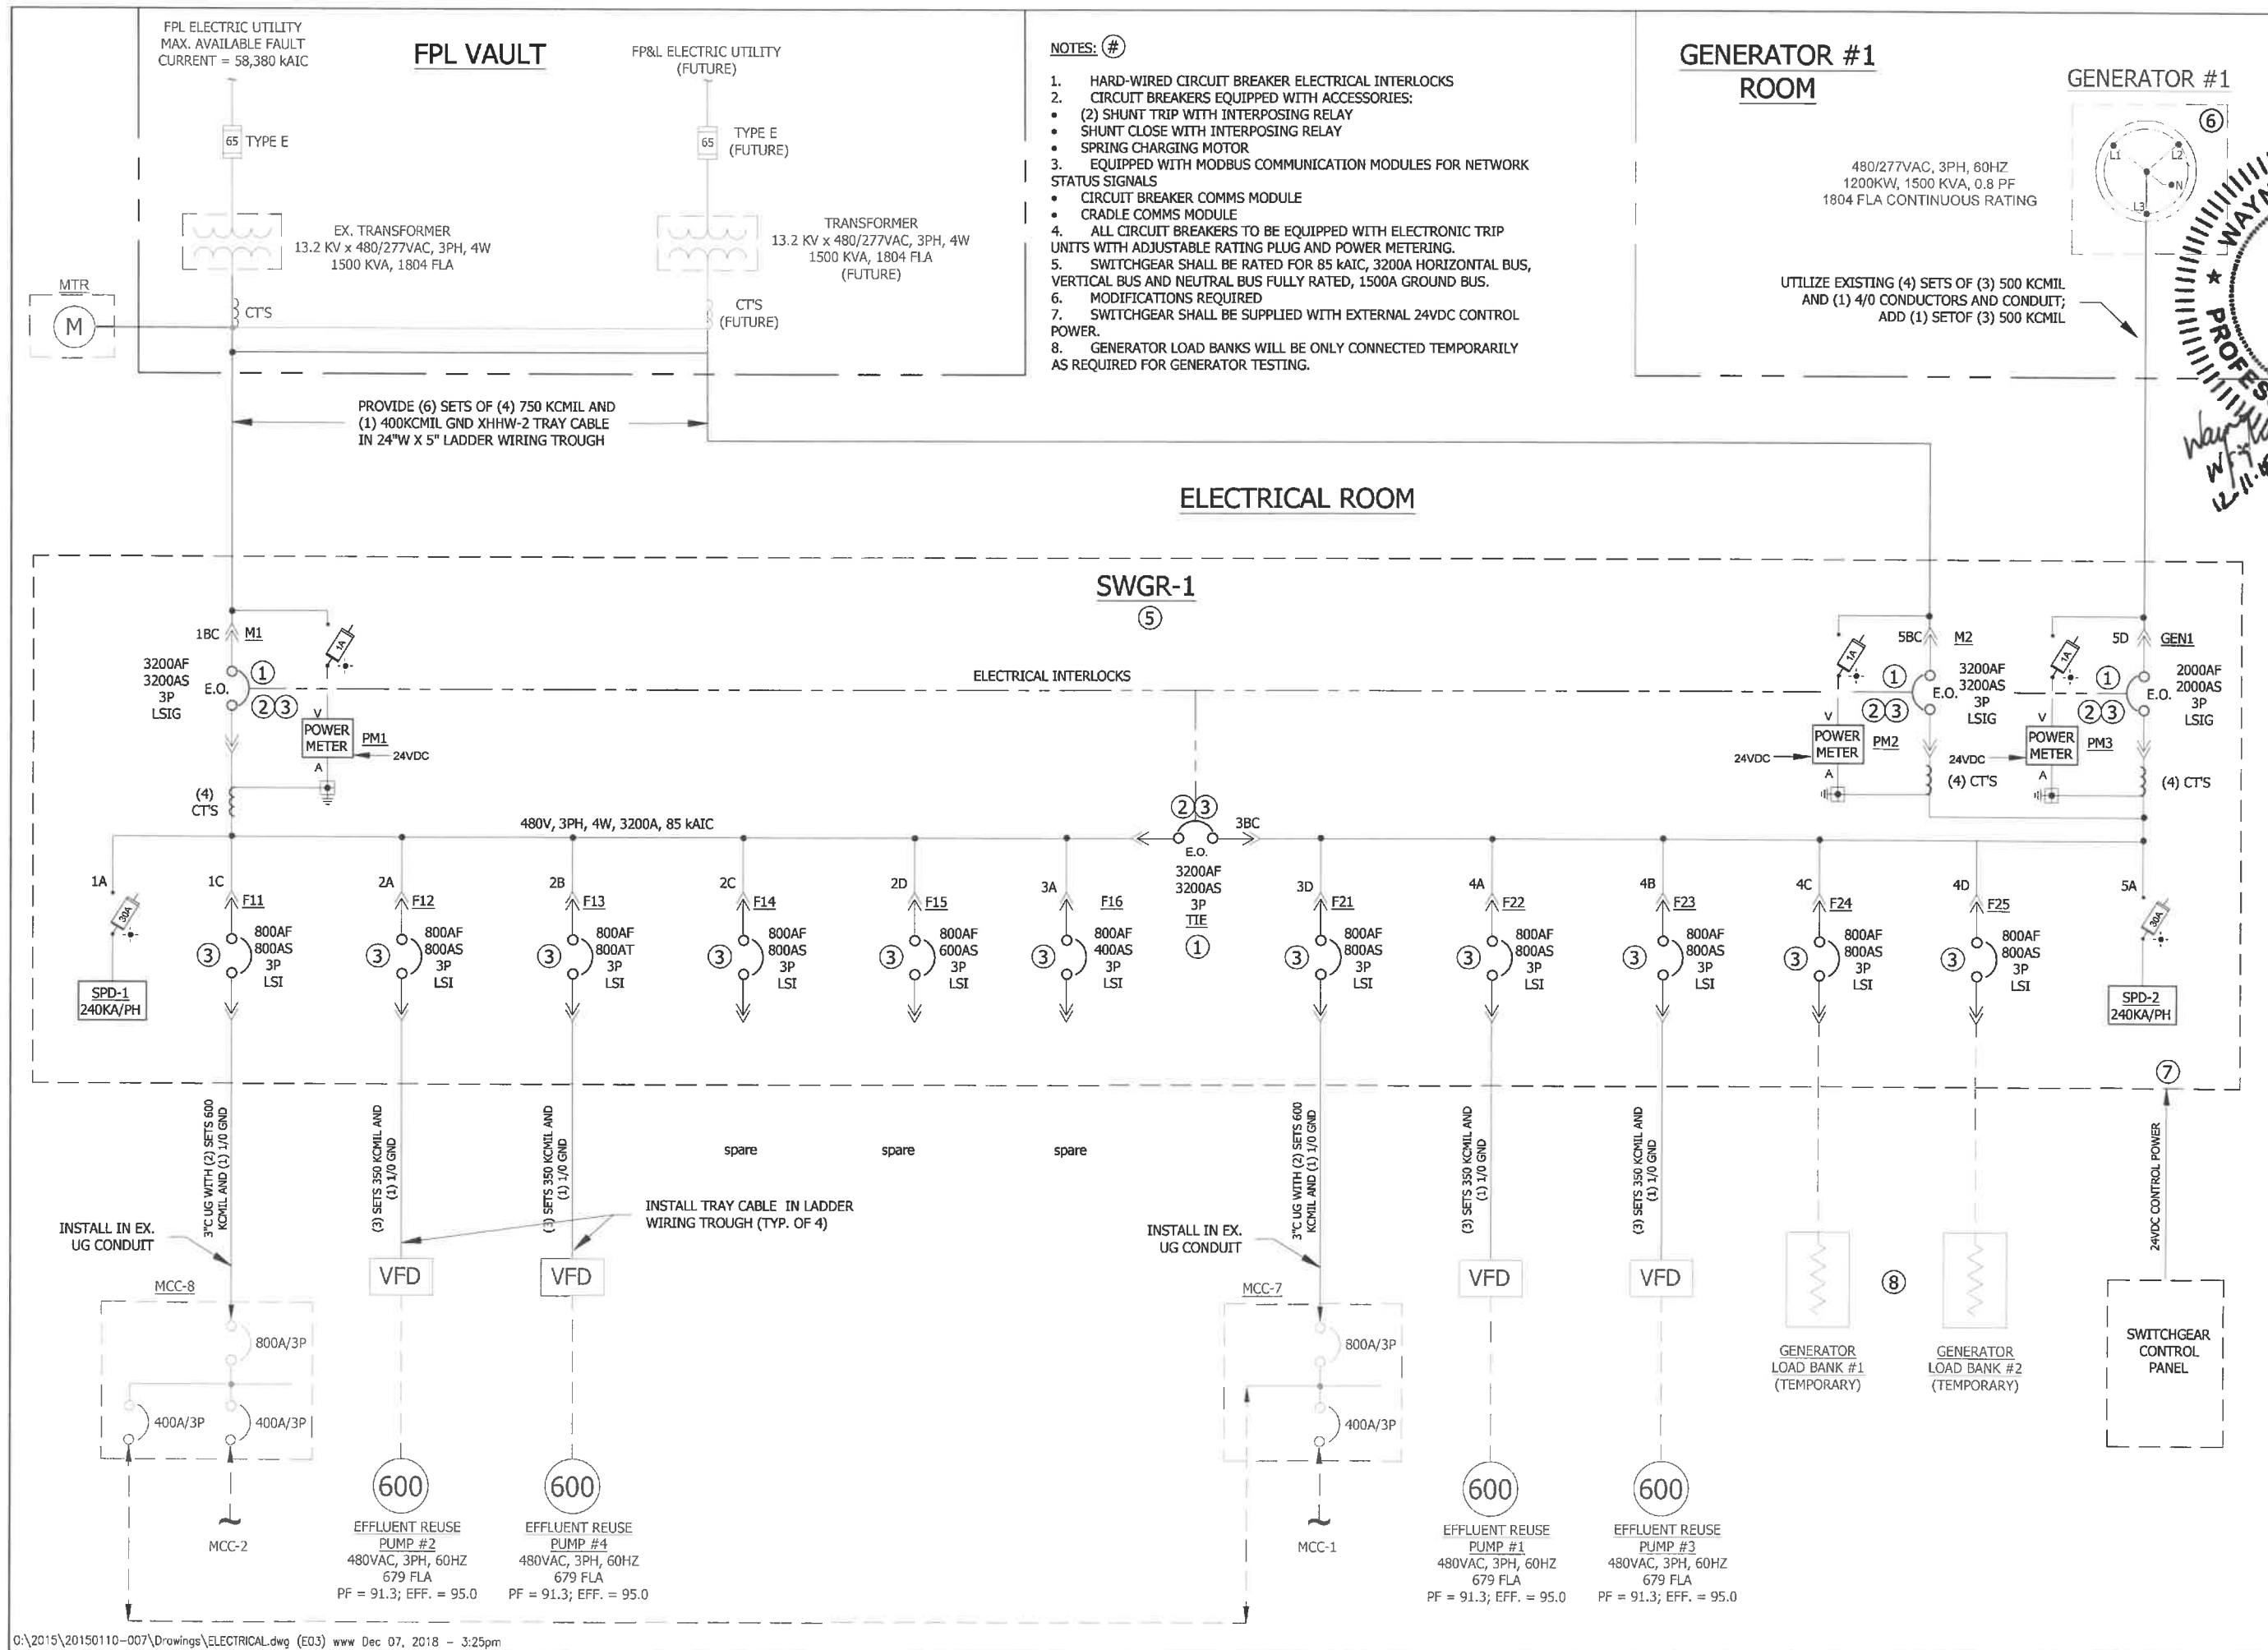
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WWTP SITE PLAN

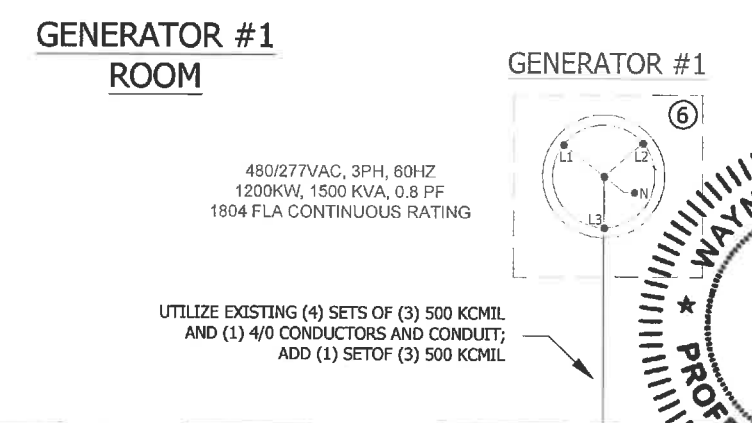
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E02







- NOTES: #**
1. HARD-WIRED CIRCUIT BREAKER ELECTRICAL INTERLOCKS
  2. CIRCUIT BREAKERS EQUIPPED WITH ACCESSORIES:
    - (2) SHUNT TRIP WITH INTERPOSING RELAY
    - SHUNT CLOSE WITH INTERPOSING RELAY
    - SPRING CHARGING MOTOR
  3. EQUIPPED WITH MODBUS COMMUNICATION MODULES FOR NETWORK STATUS SIGNALS
    - CIRCUIT BREAKER COMMS MODULE
    - CRADLE COMMS MODULE
  4. ALL CIRCUIT BREAKERS TO BE EQUIPPED WITH ELECTRONIC TRIP UNITS WITH ADJUSTABLE RATING PLUG AND POWER METERING.
  5. SWITCHGEAR SHALL BE RATED FOR 85 KAIC, 3200A HORIZONTAL BUS, VERTICAL BUS AND NEUTRAL BUS FULLY RATED, 1500A GROUND BUS.
  6. MODIFICATIONS REQUIRED
  7. SWITCHGEAR SHALL BE SUPPLIED WITH EXTERNAL 24VDC CONTROL POWER.
  8. GENERATOR LOAD BANKS WILL BE ONLY CONNECTED TEMPORARILY AS REQUIRED FOR GENERATOR TESTING.



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CITY OF NAPLES WWTP  
 SWITCHGEAR REPLACEMENT  
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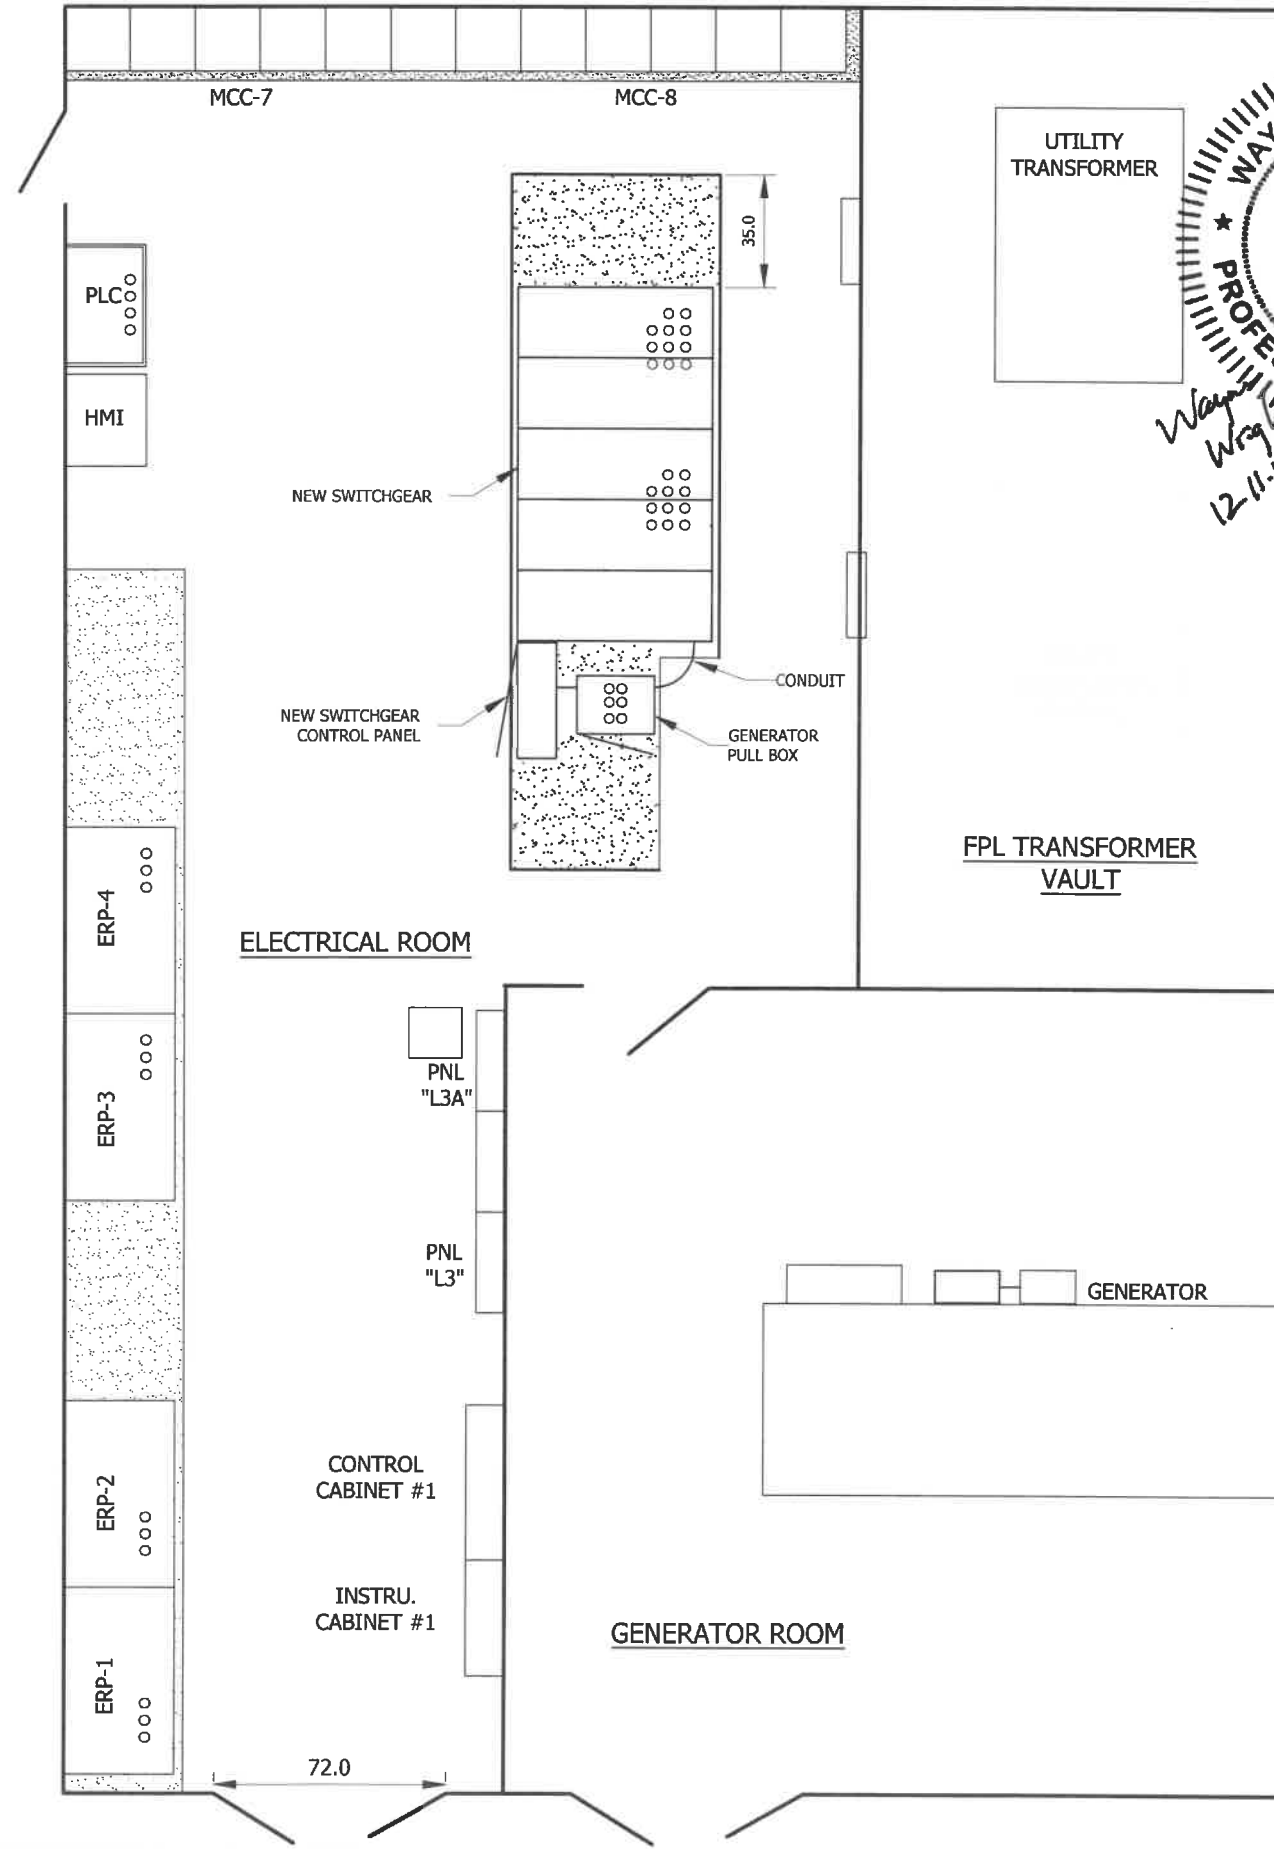
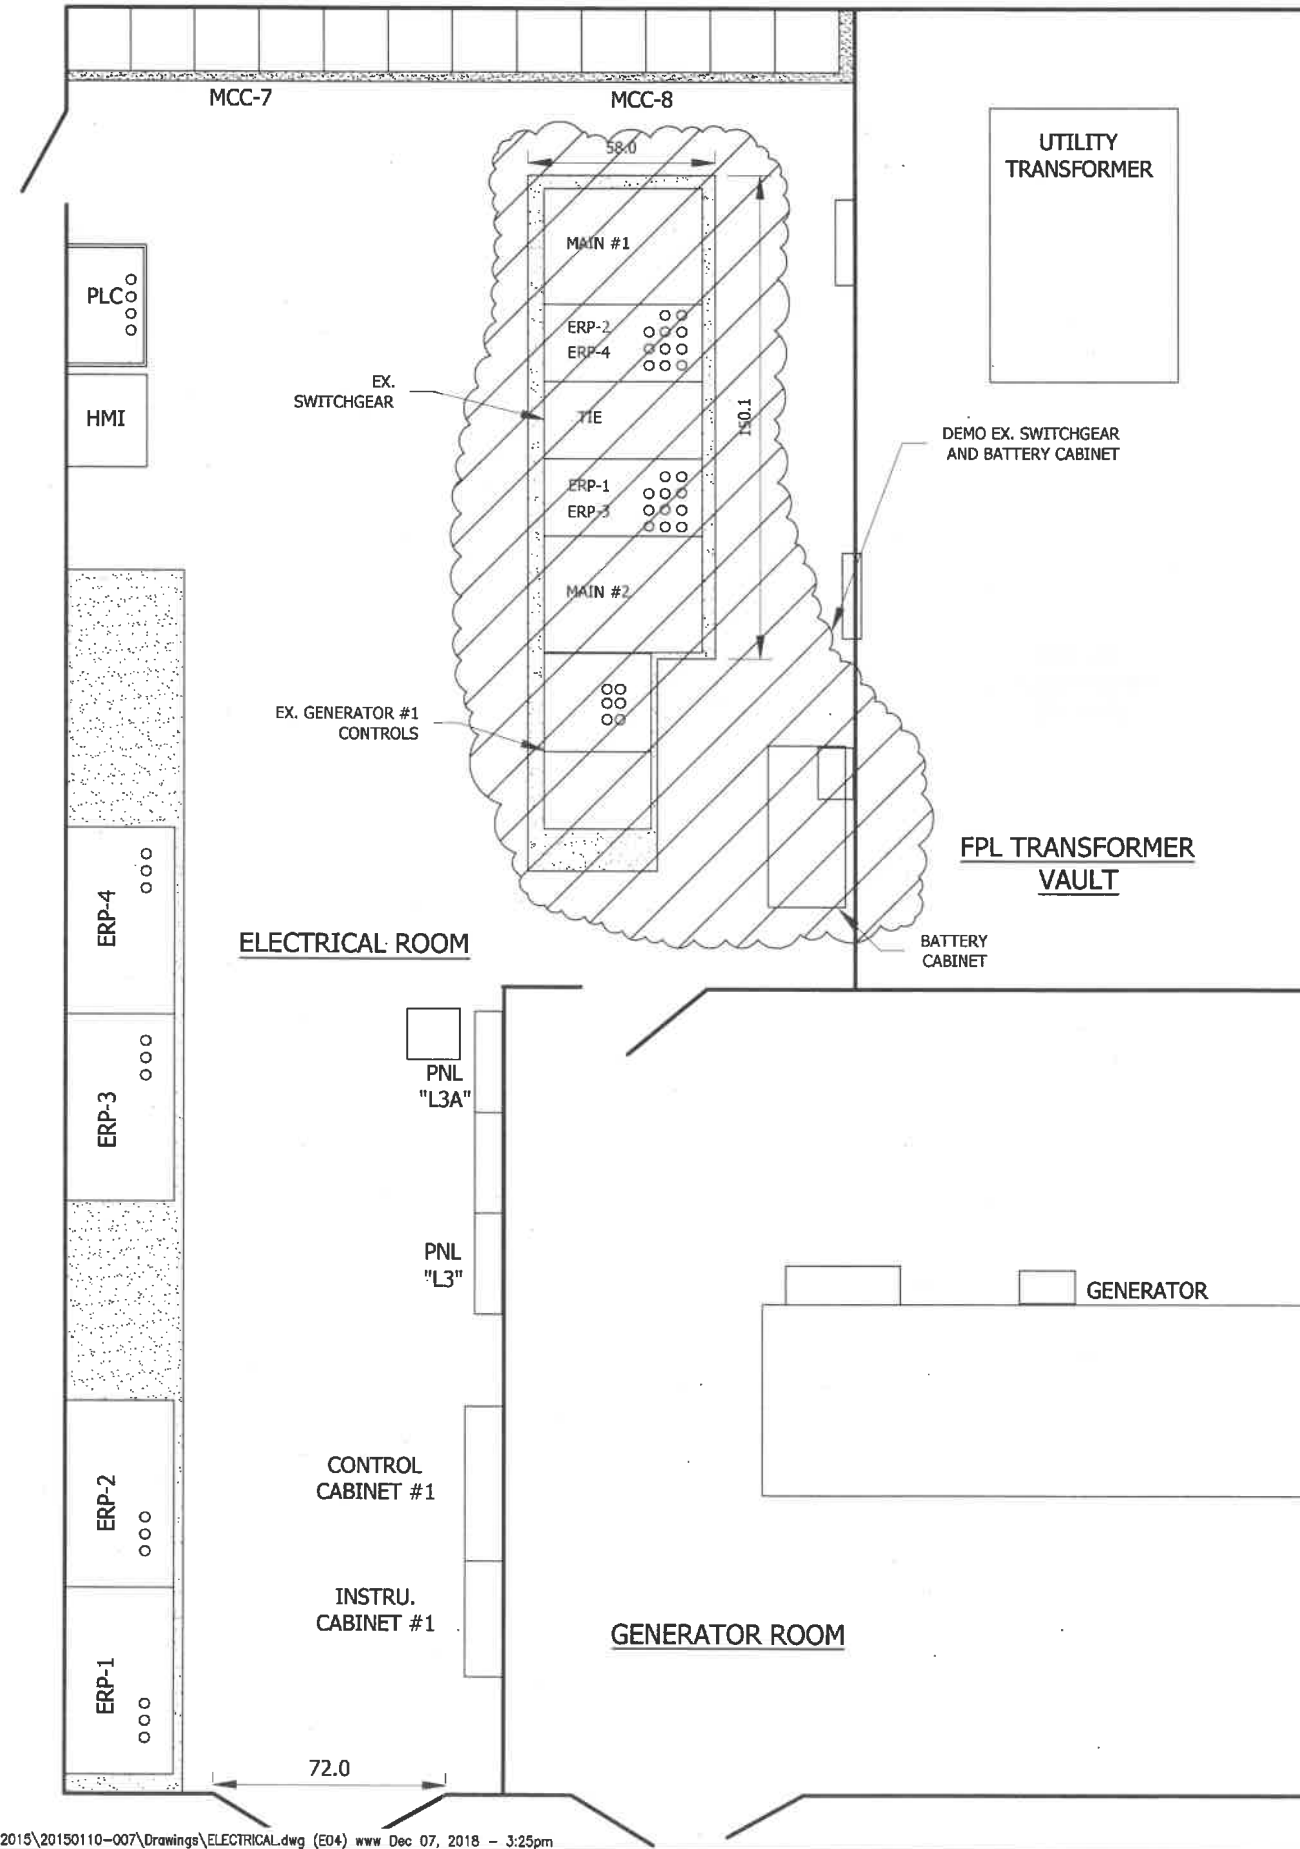
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**SWGR-1 PROPOSED SINGLE LINE DIAGRAM**

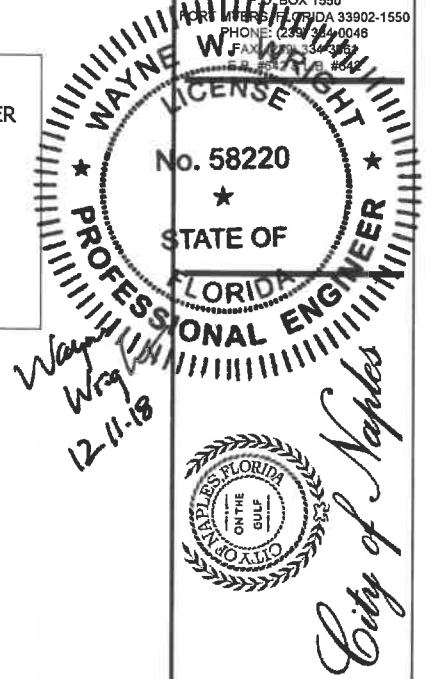
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**E03**

**EXISTING SWITCHGEAR ARRANGEMENT**

**PROPOSED SWITCHGEAR ARRANGEMENT**



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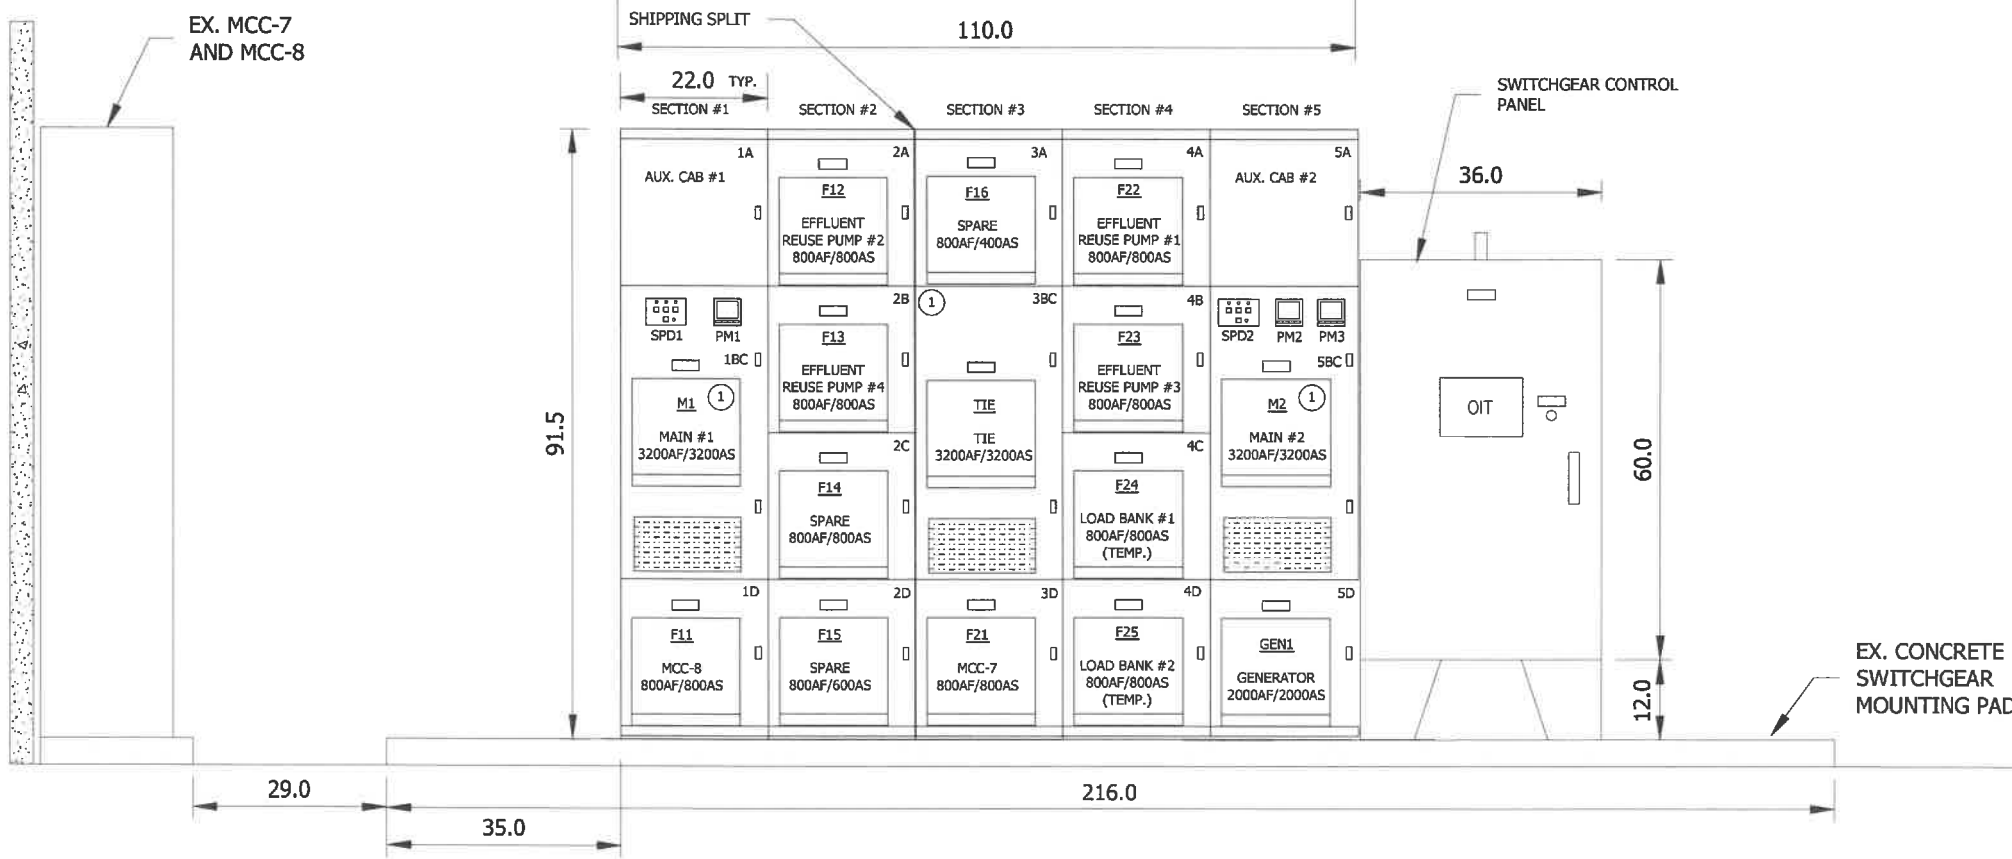
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 SCALE: 1" = 60'

SWGR-1 SITE PLAN

SHEET NUMBER  
**E04**



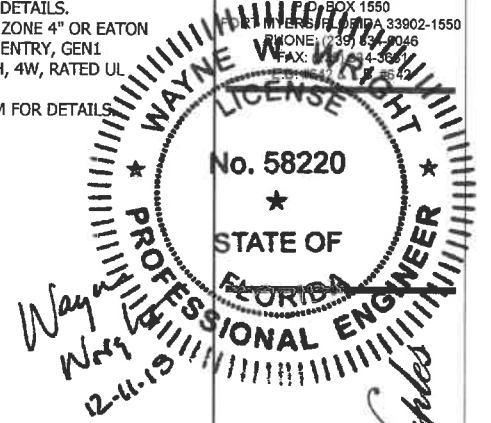
PROPOSED SWITCHGEAR ELEVATION

NOTES: #

1. REMOTE RACKING DEVICE TO BE SUPPLIED FOR DESIGNATED BREAKERS.
2. SEE SHOP DRAWINGS FOR ACTUAL CONSTRUCTION DETAILS.
3. SWITCHGEAR TO BE SCHNEIDER ELECTRIC "POWER ZONE 4" OR EATON "MAGNUM DS" DRAWOUT LOW VOLTAGE, M1 AND M2 TOP ENTRY, GEN1 BOTTOM ENTRY, SERVICE ENTRANCE RATED, 480VAC, 3PH, 4W, RATED UL 1066. CIRCUIT BREAKERS TO BE THROUGH-DOOR TYPE.
4. SEE SINGLE LINE DIAGRAM AND NETWORK DIAGRAM FOR DETAILS.
5. SWITCHGEAR DEPTH = 60".

| SWGR1 - NAMEPLATES |                    |                   |                             |
|--------------------|--------------------|-------------------|-----------------------------|
| POSITION           | PLATE COLOR / SIZE | TEXT COLOR / SIZE | ENGRAVING (L1   L2   L3)    |
| 1A                 | BLK / 1.5"H x 4"W  | WHT / .25"        | AUXILIARY CABINET #1        |
| 1BC                | BLK / 1.5"H x 4"W  | WHT / .25"        | MAIN C/B M1                 |
| 1D                 | BLK / 1.5"H x 4"W  | WHT / .25"        | MCC-8 FEEDER C/B F11        |
| 2A                 | BLK / 1.5"H x 4"W  | WHT / .25"        | EFFLUENT REUSE PUMP #2 F12  |
| 2B                 | BLK / 1.5"H x 4"W  | WHT / .25"        | EFFLUENT REUSE PUMP #4 F13  |
| 2C                 | BLK / 1.5"H x 4"W  | WHT / .25"        | SPARE FEEDER C/B F14        |
| 2D                 | BLK / 1.5"H x 4"W  | WHT / .25"        | SPARE FEEDER C/B F15        |
| 3A                 | BLK / 1.5"H x 4"W  | WHT / .25"        | SPARE FEEDER C/B F16        |
| 3BC                | BLK / 1.5"H x 4"W  | WHT / .25"        | TIE C/B TIE                 |
| 3D                 | BLK / 1.5"H x 4"W  | WHT / .25"        | MCC-7 FEEDER C/B F21        |
| 4A                 | BLK / 1.5"H x 4"W  | WHT / .25"        | EFFLUENT REUSE PUMP #1 F22  |
| 4B                 | BLK / 1.5"H x 4"W  | WHT / .25"        | EFFLUENT REUSE PUMP #3 F23  |
| 4C                 | BLK / 1.5"H x 4"W  | WHT / .25"        | LOAD BANK #1 FEEDER C/B F24 |
| 4D                 | BLK / 1.5"H x 4"W  | WHT / .25"        | LOAD BANK #2 FEEDER C/B F25 |
| 5A                 | BLK / 1.5"H x 4"W  | WHT / .25"        | AUXILIARY CABINET #2        |
| 5BC                | BLK / 1.5"H x 4"W  | WHT / .25"        | MAIN C/B M2                 |
| 5D                 | BLK / 1.5"H x 4"W  | WHT / .25"        | GENERATOR #1 C/B GEN1       |

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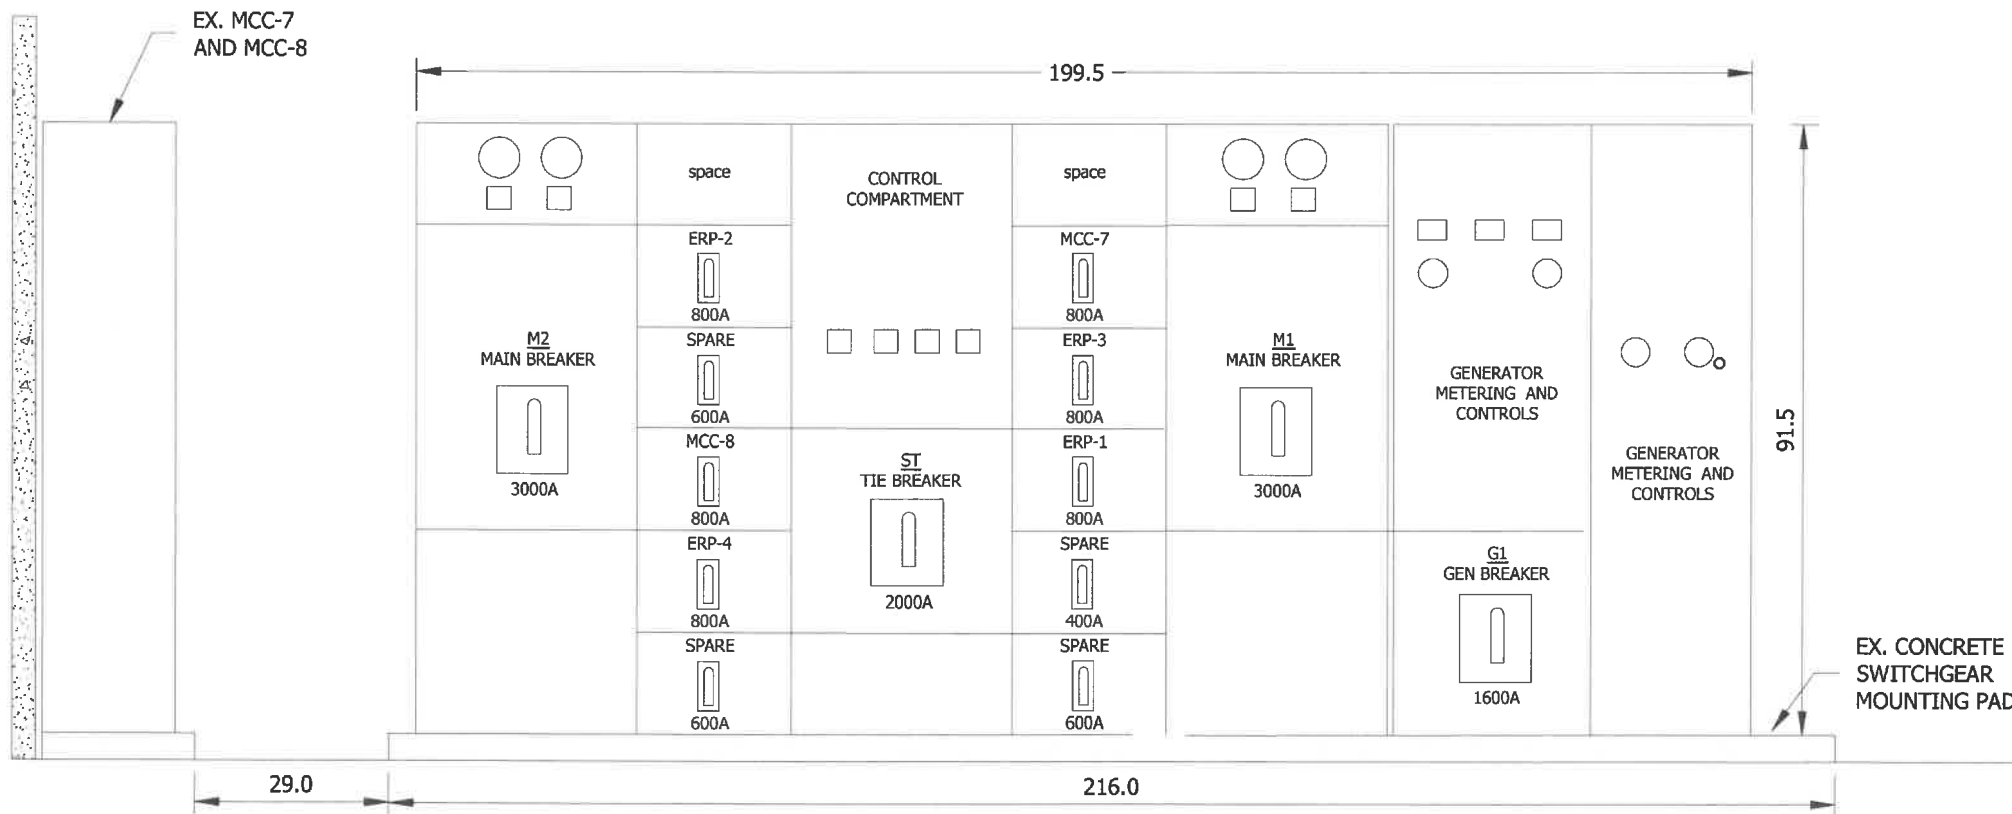
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SWGR-1  
ELEVATION

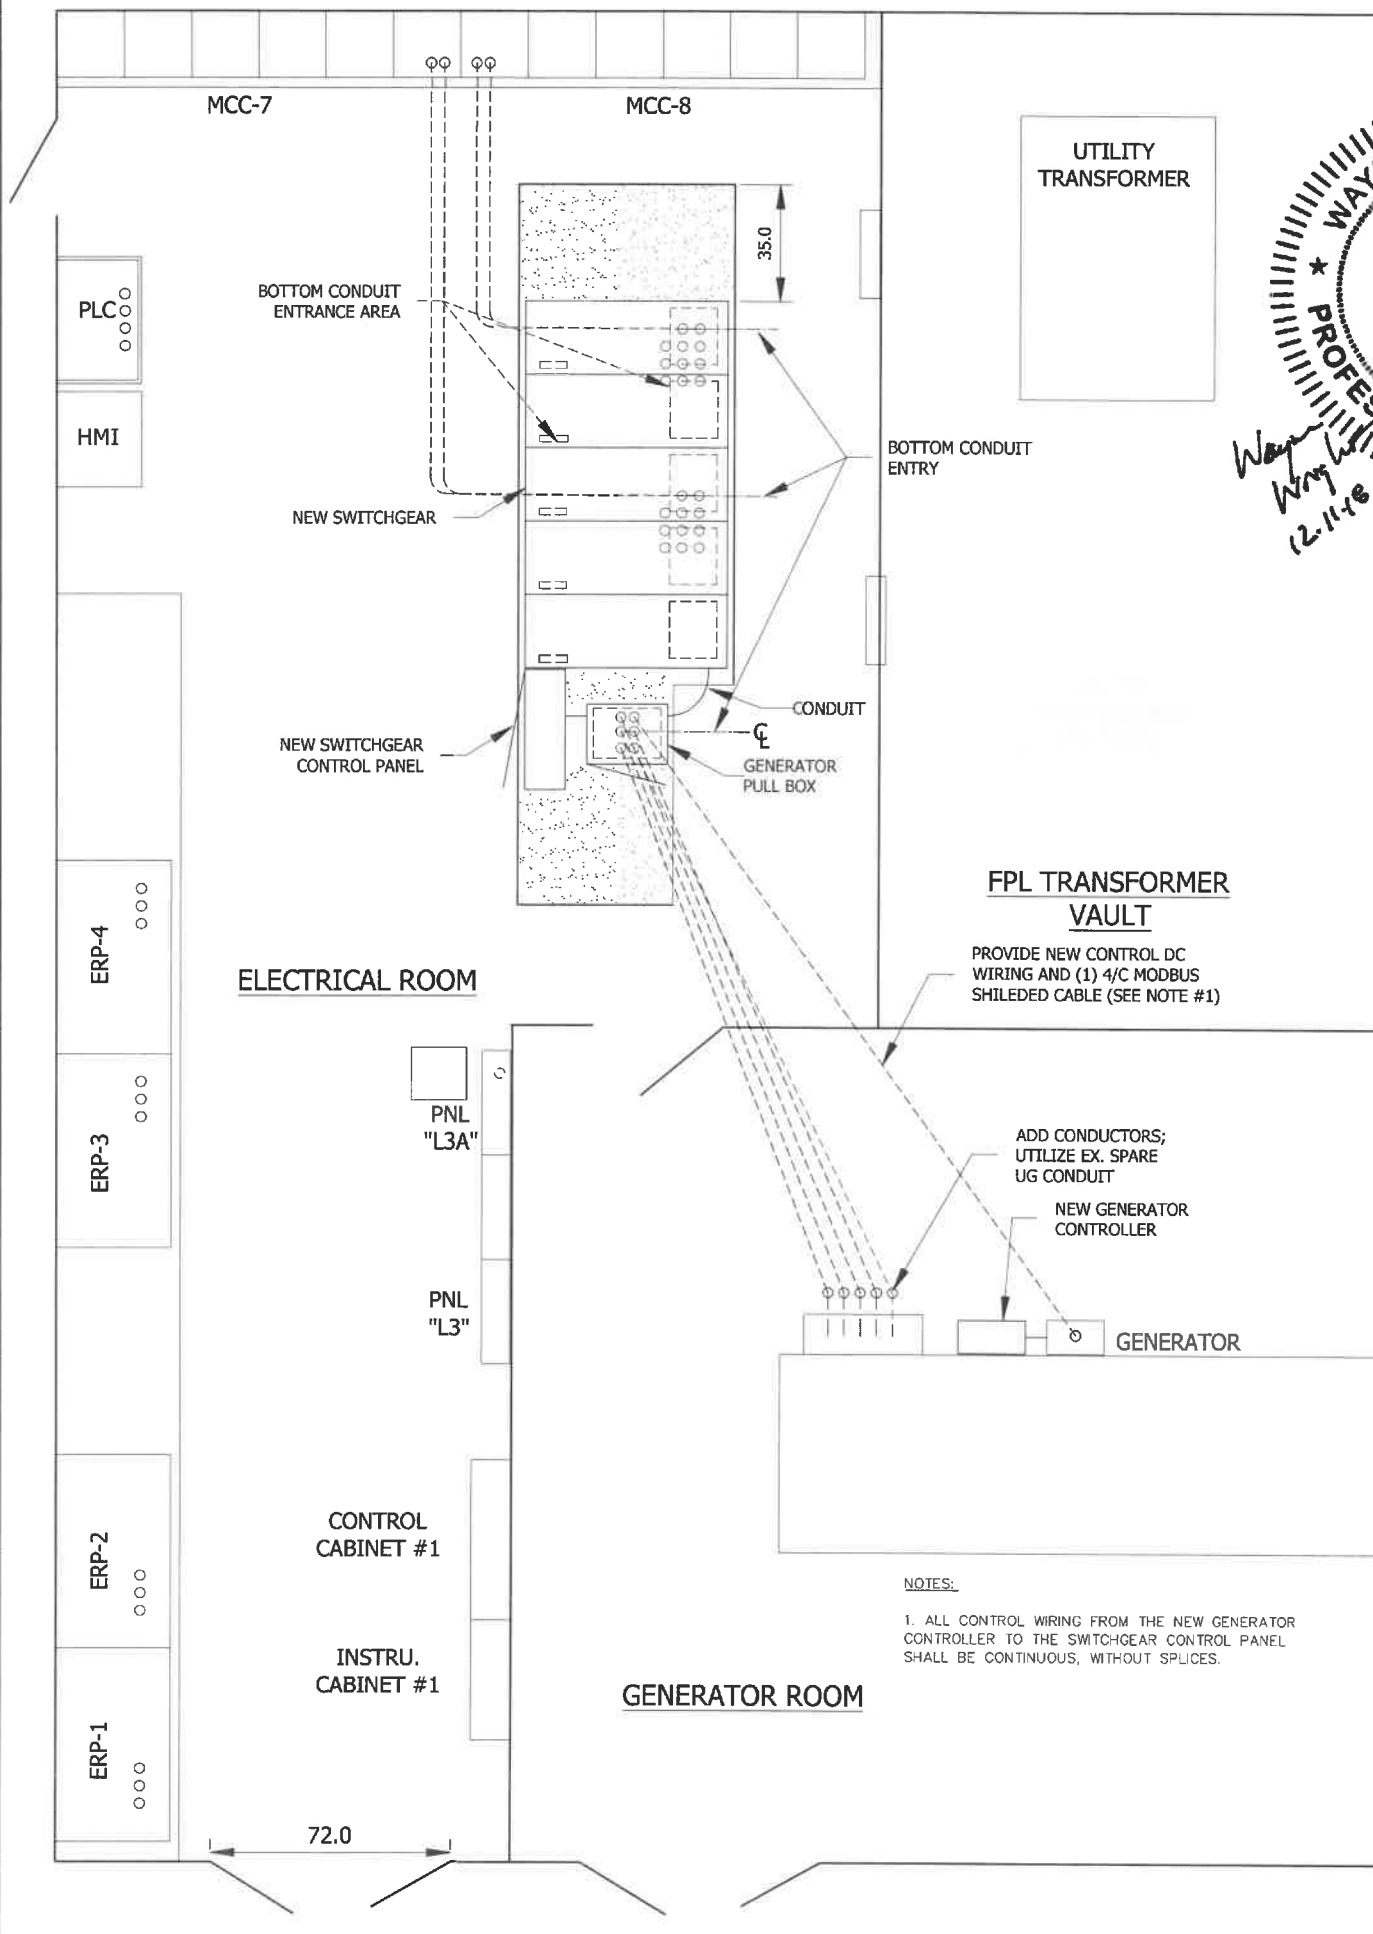
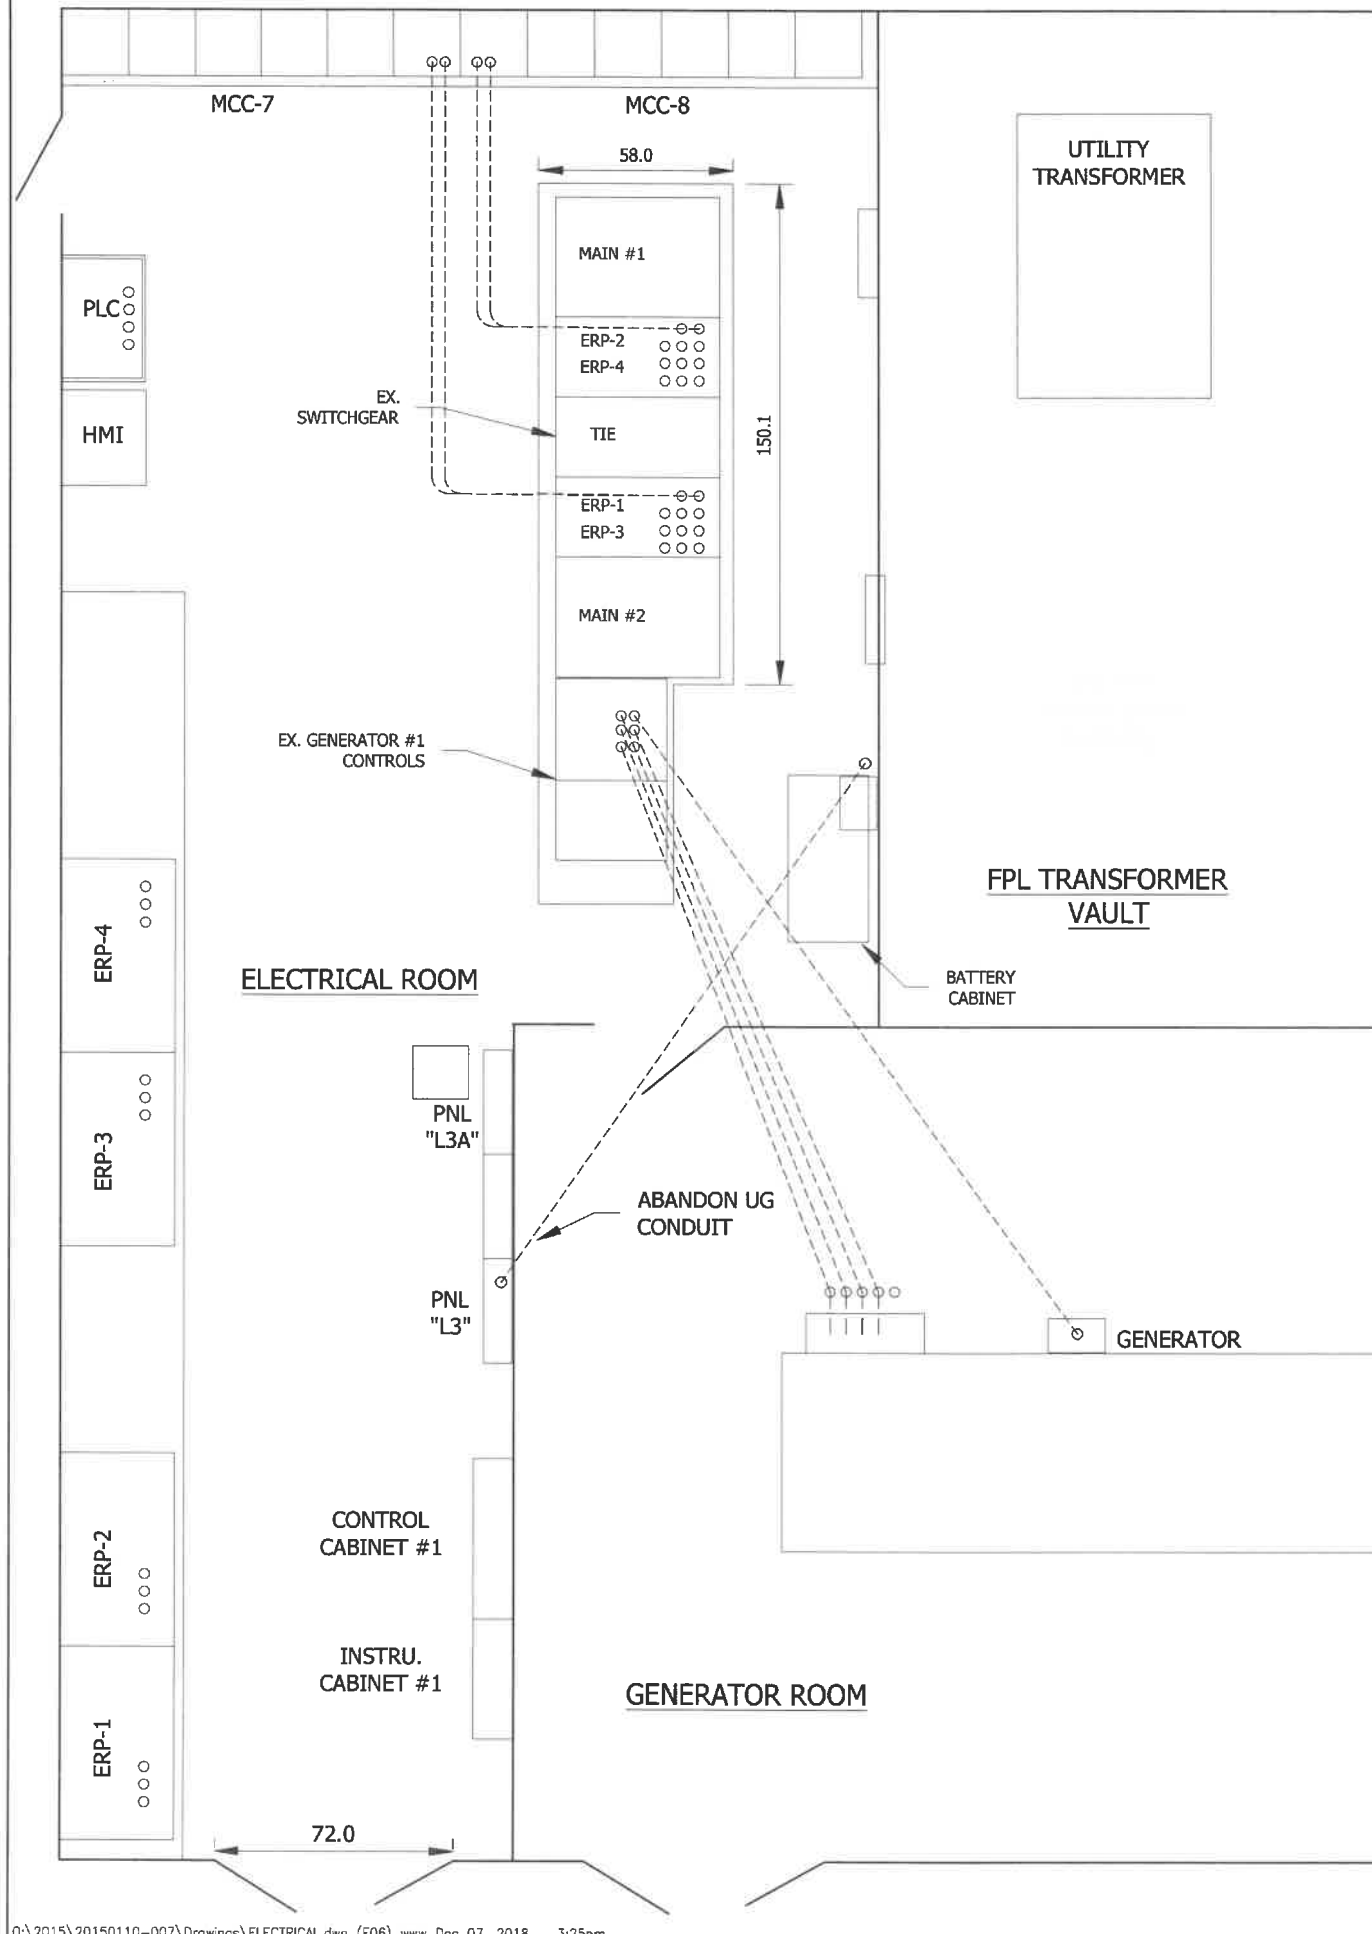
SHEET NUMBER  
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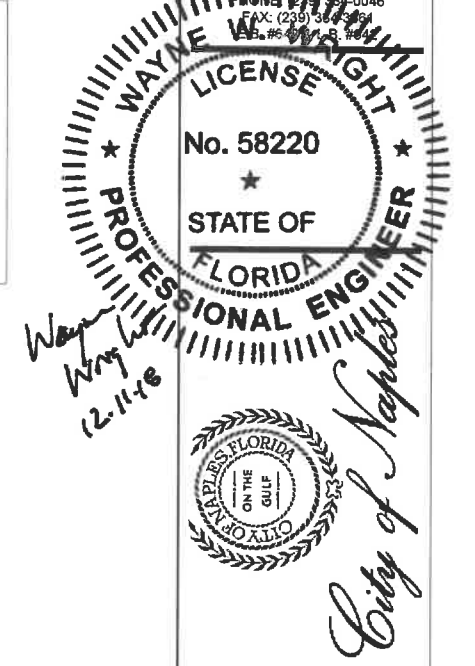
EXISTING SWITCHGEAR ELEVATION

**EXISTING SWITCHGEAR UNDERGROUND CONDUIT**

**PROPOSED SWITCHGEAR UNDERGROUND CONDUIT**



**JOHNSON ENGINEERING**  
 JOHNSON ENGINEERING, INC.  
 2122 JOHNSON STREET  
 P.O. BOX 1550  
 FORT MYERS, FLORIDA 33902-1550  
 TEL: (888) 334-0046  
 FAX: (239) 334-0046  
 REG. # 12,784



CITY OF NAPLES WWTP  
 SWITCHGEAR REPLACEMENT  
 CONSTRUCTION PLANS  
 CITY OF NAPLES  
 NAPLES, FL

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DATE: DEC. 2018  
 PROJECT NO. 20150110-007  
 FILE NO. 03-50-25  
 SCALE: 1" = 60'

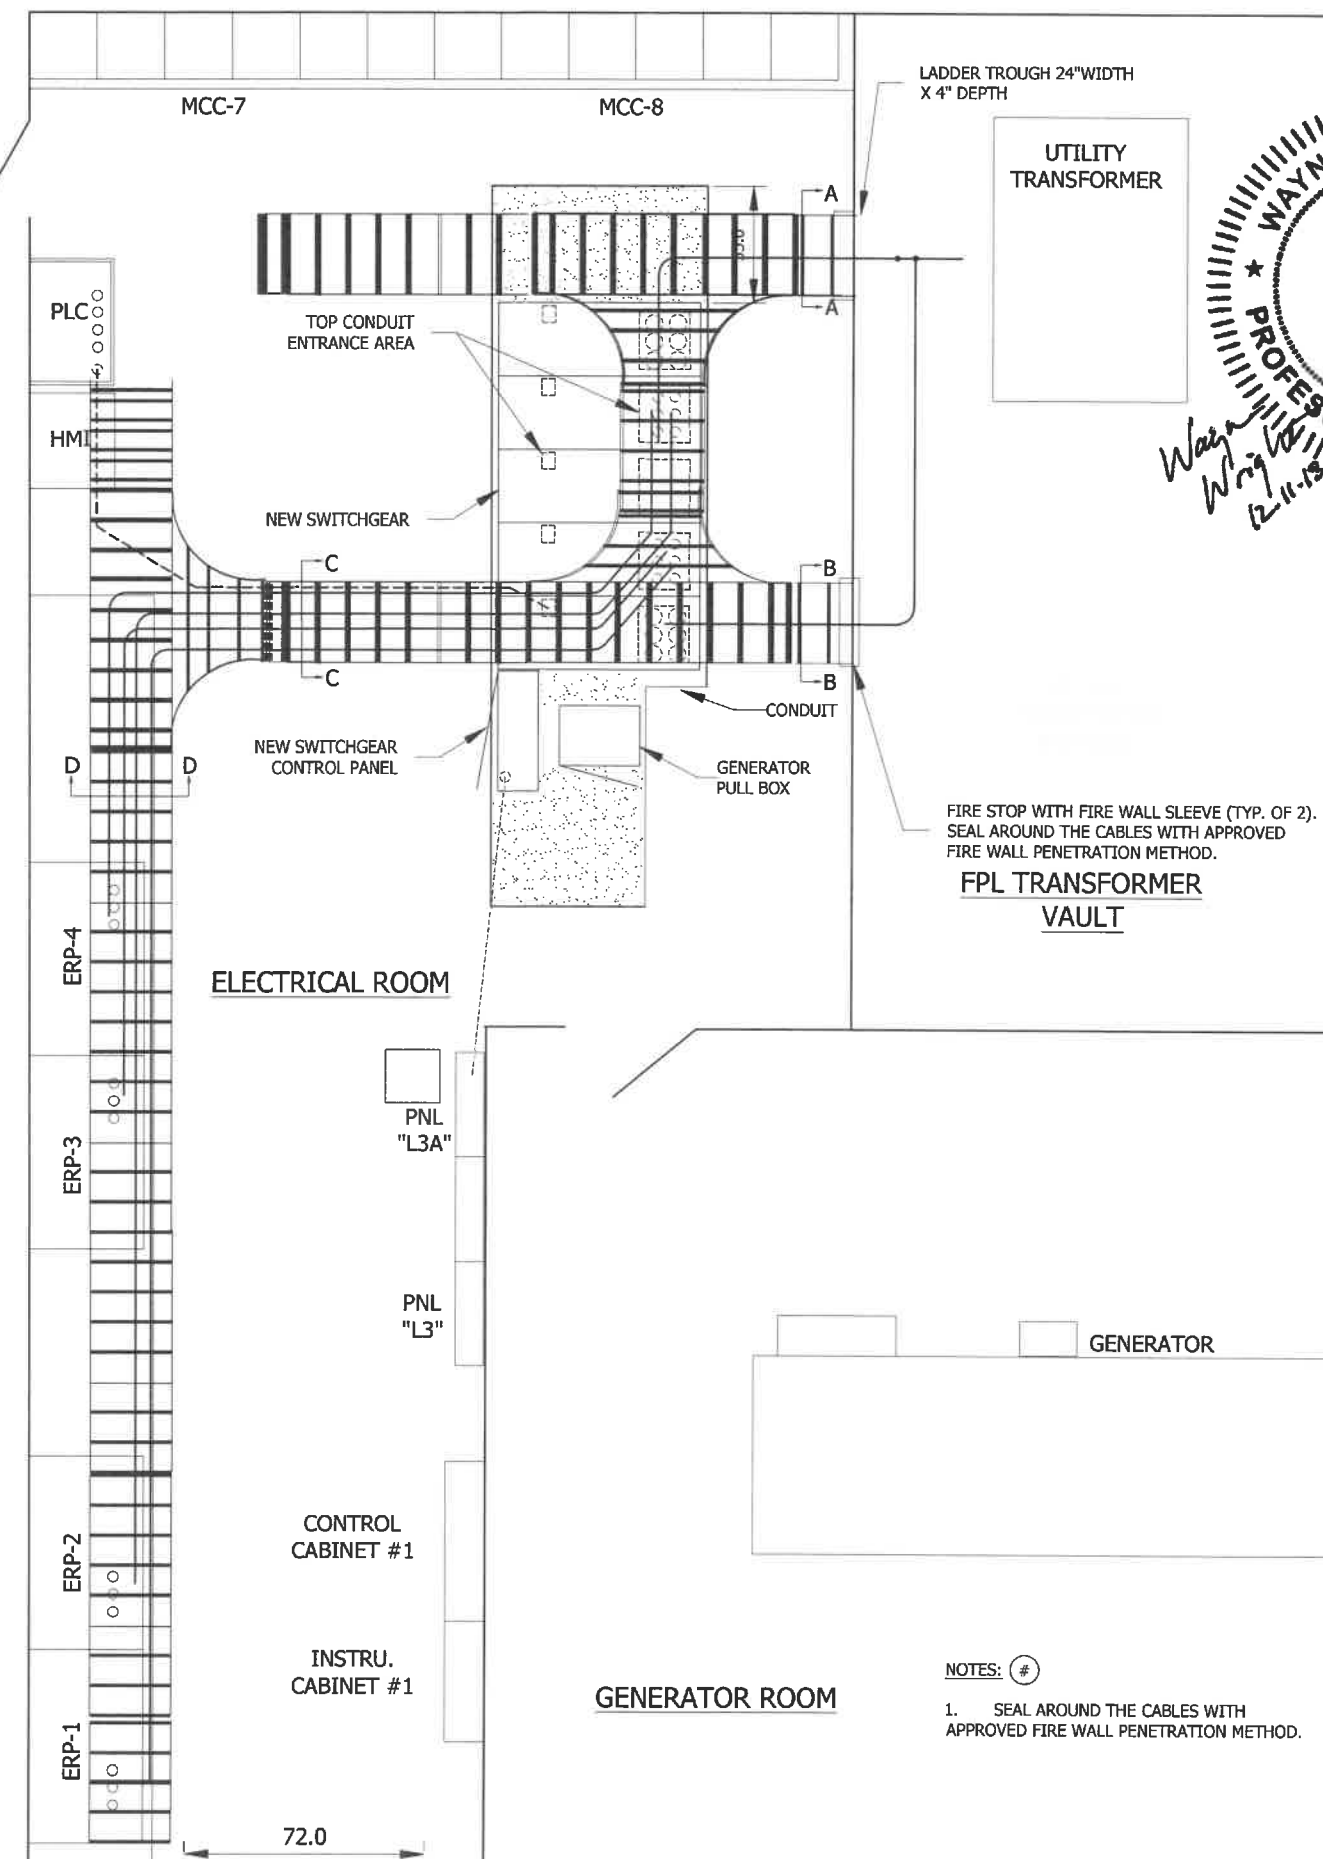
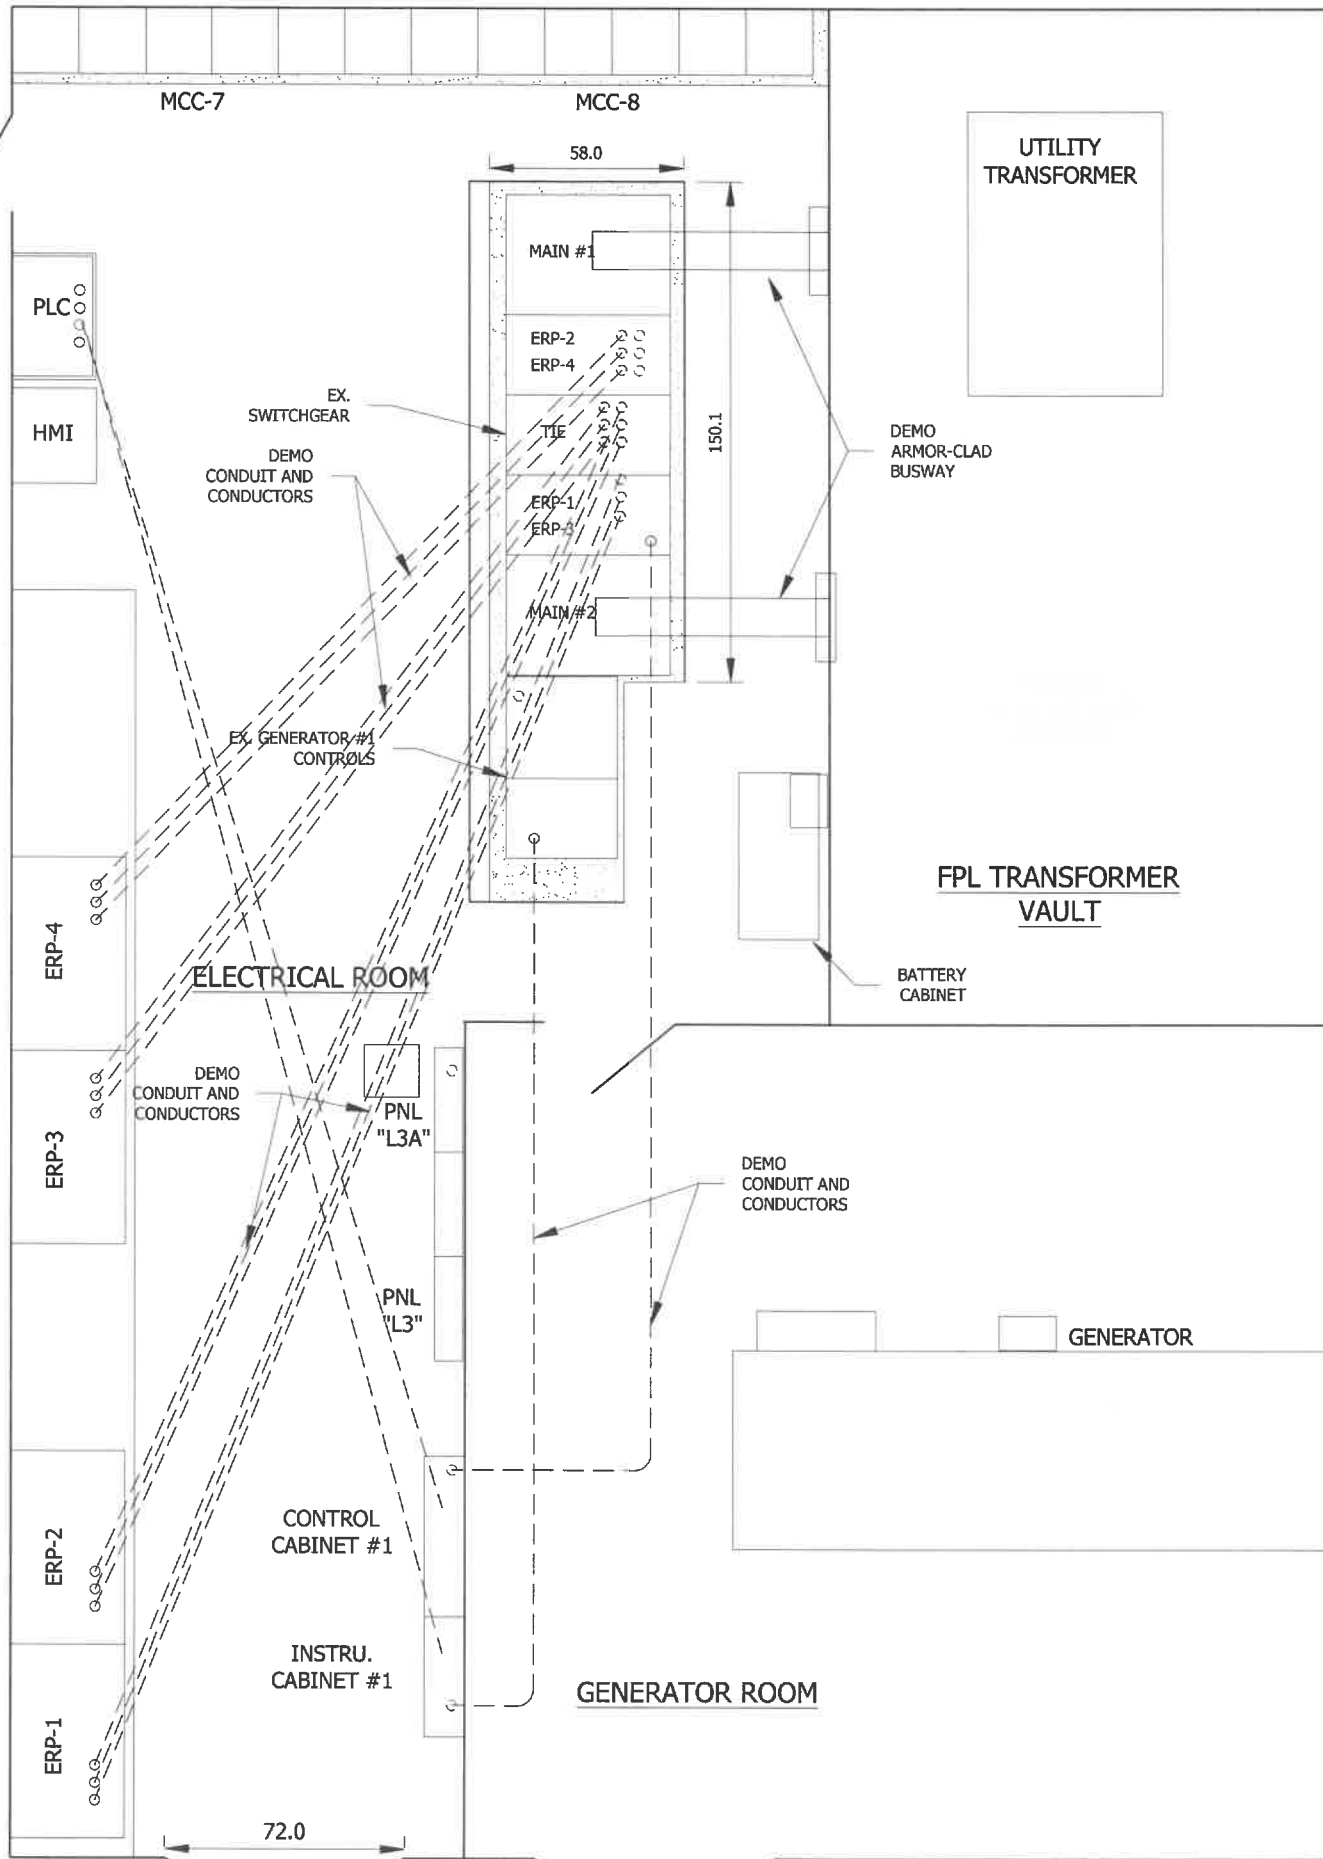
**NOTES:**  
 1. ALL CONTROL WIRING FROM THE NEW GENERATOR CONTROLLER TO THE SWITCHGEAR CONTROL PANEL SHALL BE CONTINUOUS, WITHOUT SPLICES.

**SWGR-1 U.G. CONDUIT PLAN**

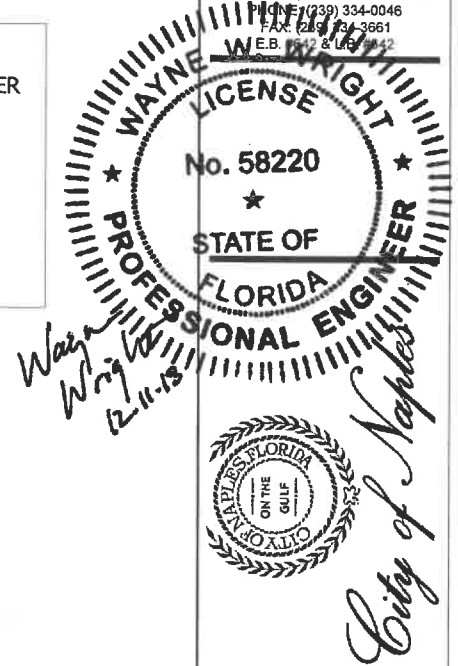
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**E06**

EXISTING SWITCHGEAR ABOVE GROUND CONDUIT

PROPOSED SWITCHGEAR WITH TWO LEVEL LADDER TROUGH



**JOHNSON ENGINEERING**  
 JOHNSON ENGINEERING, INC.  
 2122 JOHNSON STREET  
 P.O. BOX 1550  
 FORT MYERS, FLORIDA 33902-1550  
 TEL: (888) 334-0046  
 FAX: (239) 334-3661  
 WEB: www.jeh.com



CITY OF NAPLES WWTP  
 SWITCHGEAR REPLACEMENT  
 CONSTRUCTION PLANS  
 CITY OF NAPLES  
 NAPLES, FL

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DATE: DEC. 2018  
 PROJECT NO. 20150110-007  
 FILE NO. 03-50-25  
 SCALE: 1" = 60'

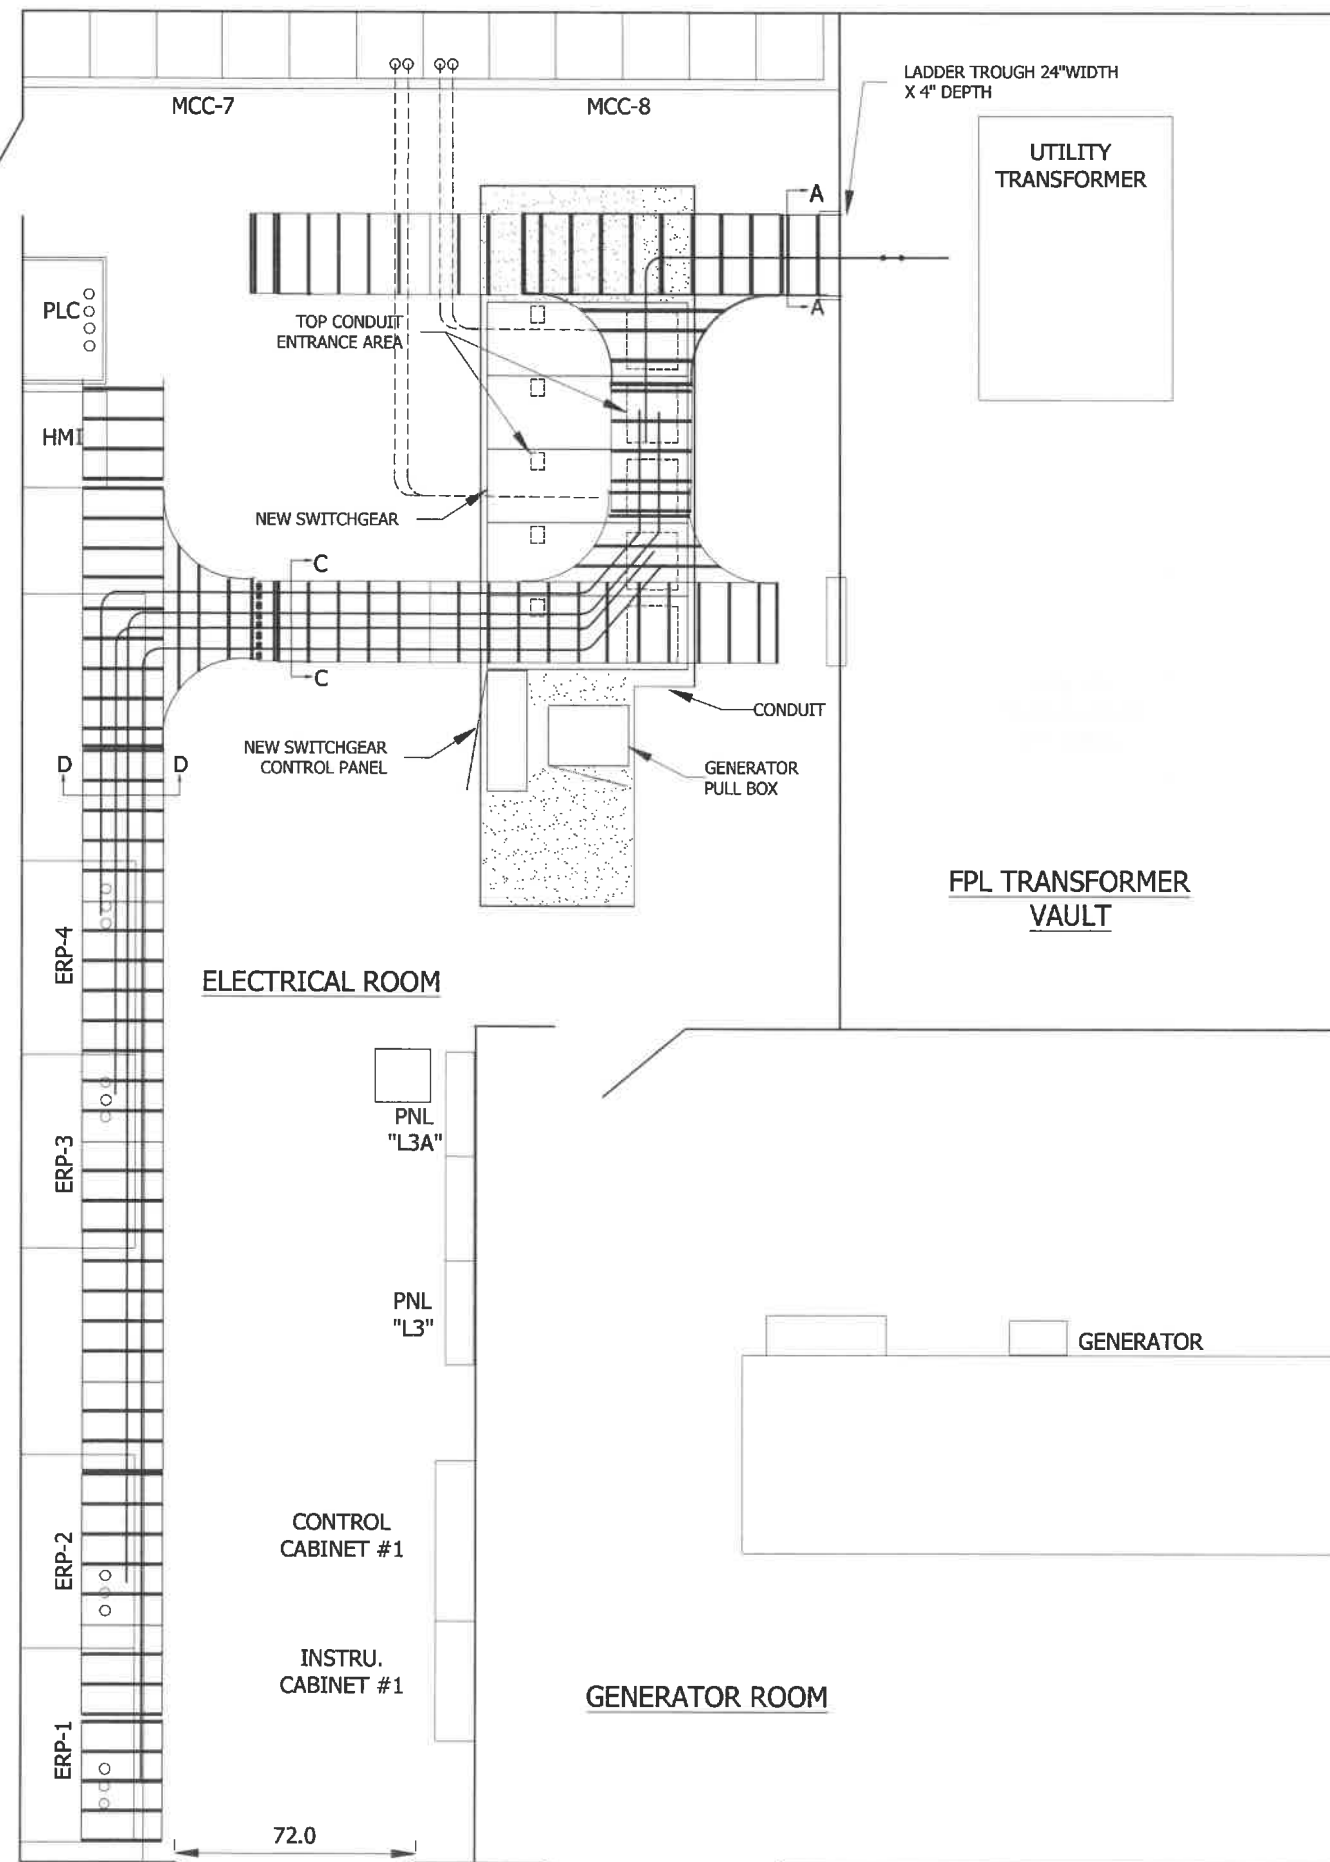
- NOTES: #
- SEAL AROUND THE CABLES WITH APPROVED FIRE WALL PENETRATION METHOD.

SWGR-1 AG  
 CONDUIT AND  
 TROUGH PLAN

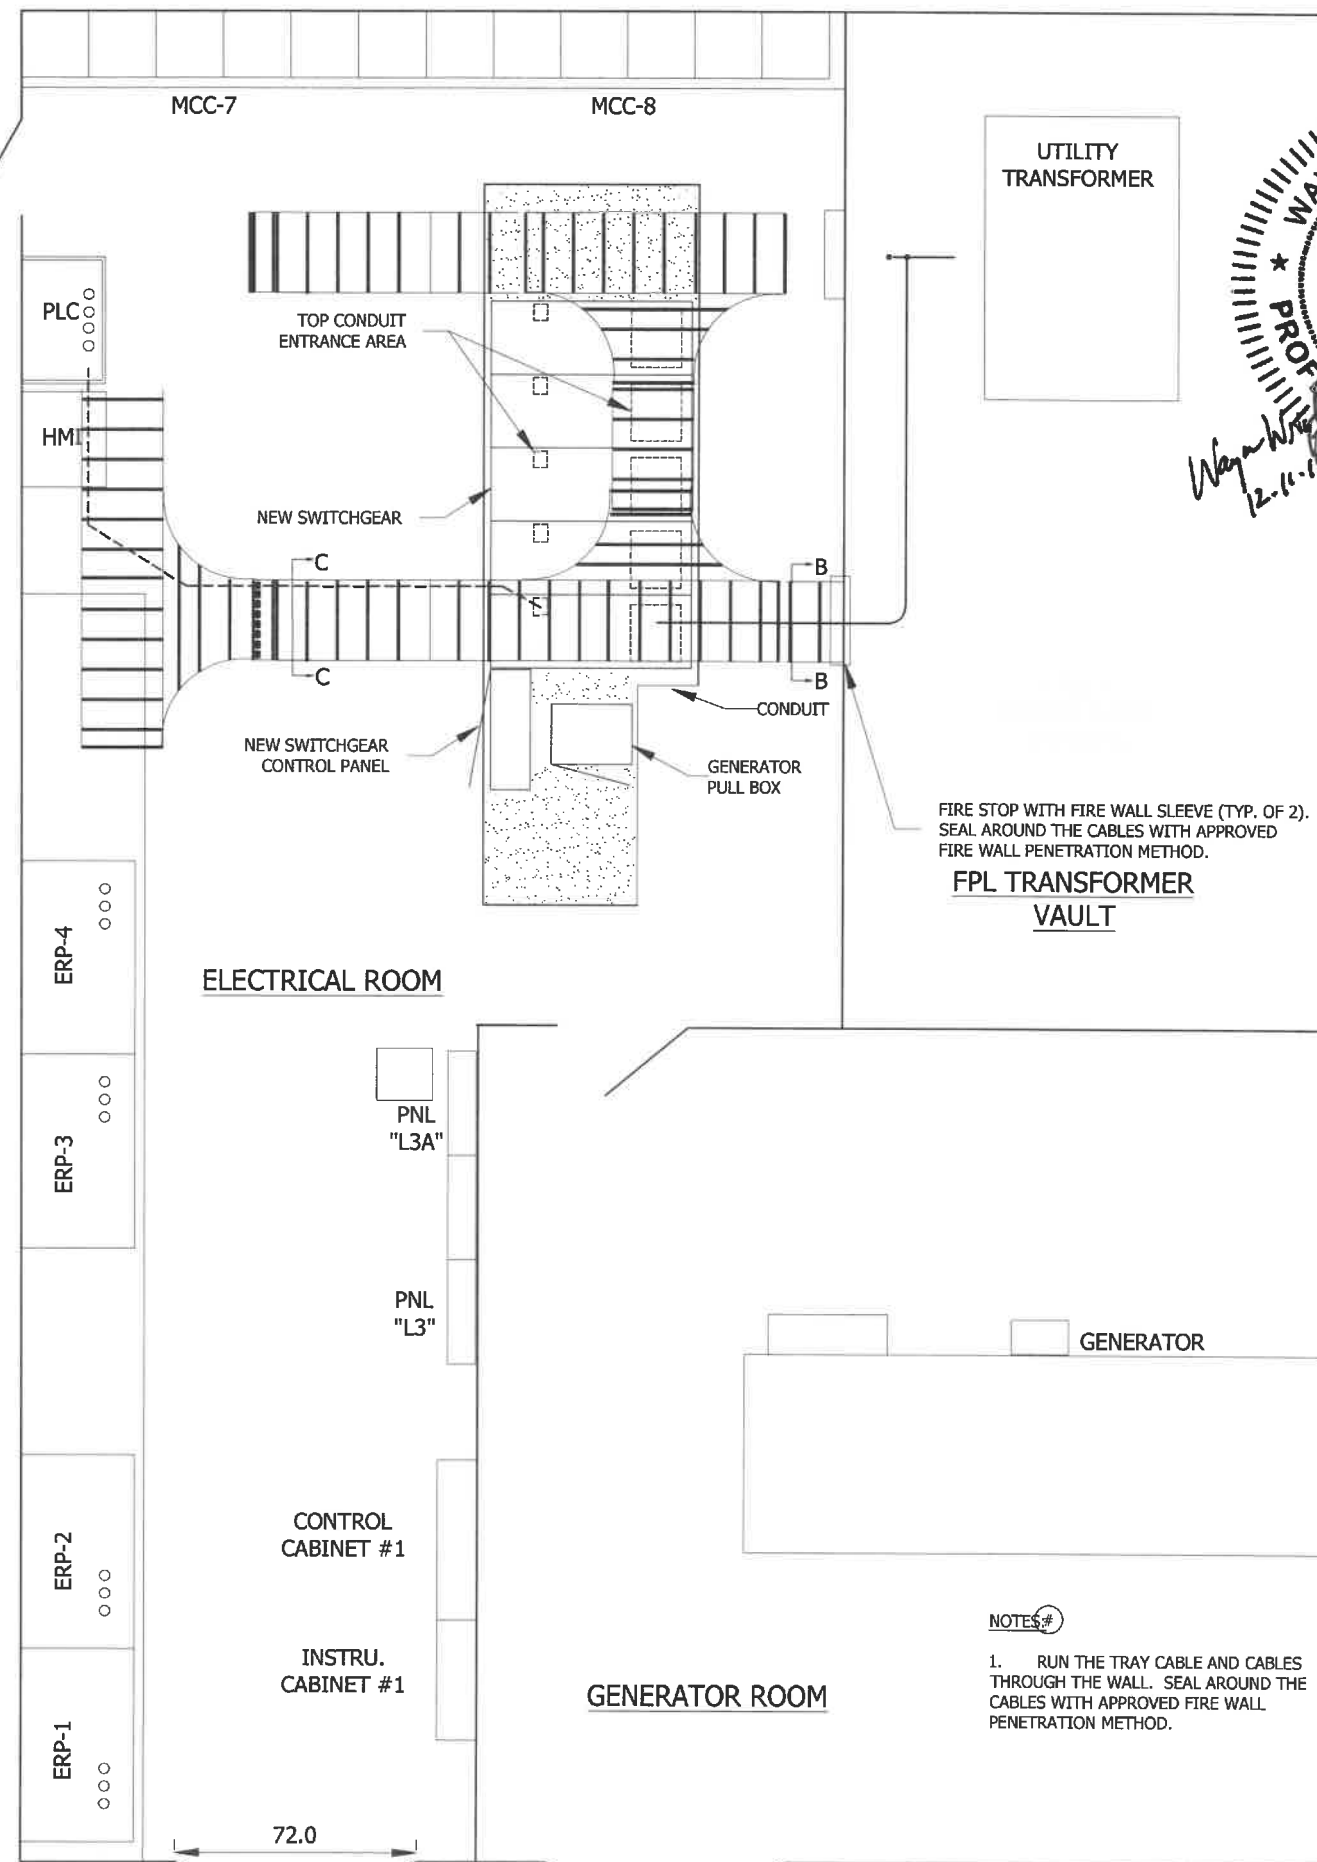
SHEET NUMBER  
**E07**



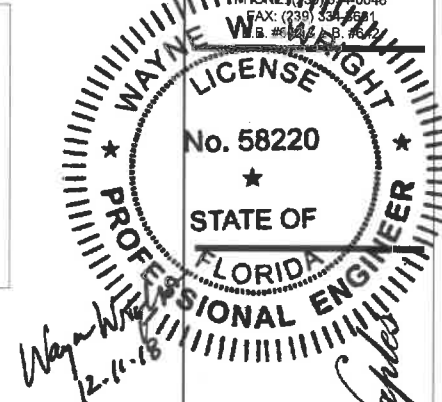
PROPOSED SWITCHGEAR WITH UPPER LEVEL LADDER TROUGH



PROPOSED SWITCHGEAR WITH LOWER LEVEL LADDER TROUGH



**JOHNSON ENGINEERING**  
 JOHNSON ENGINEERING, INC.  
 2122 JOHNSON STREET  
 P.O. BOX 1550  
 FORT MYERS, FLORIDA 33902-1550  
 PHONE: (888) 44-0046  
 FAX: (734) 334-1911  
 E-MAIL: J.E. @ JOHNSON-ENG.COM



CITY OF NAPLES WWTP  
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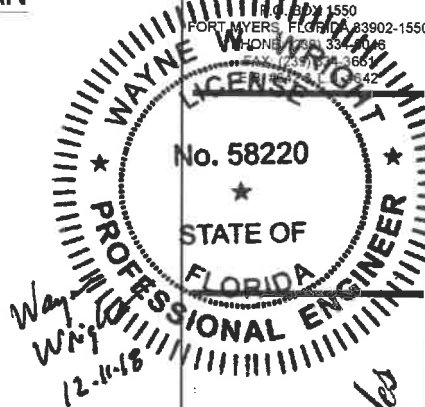
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DATE: DEC. 2018  
 PROJECT NO. 20150110-007  
 FILE NO. 03-50-25  
 SCALE: 1" = 60'

SWGR-1 AG  
 CONDUIT AND  
 TROUGH PLAN  
 SHEET NUMBER  
**E08**

**PROPOSED GENERATOR  
SITE PLAN**

**JOHNSON  
ENGINEERING**  
JOHNSON ENGINEERING, INC.  
2122 JOHNSON STREET  
FORT MYERS, FLORIDA 33902-1550  
PHONE: 888-334-6642  
FAX: 888-334-6642



*City of Naples*

CITY OF NAPLES WWTP  
SWITCHGEAR REPLACEMENT  
CONSTRUCTION PLANS  
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NAPLES, FL

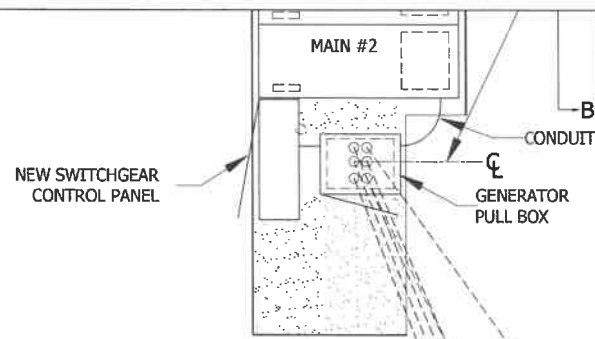
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DATE: DEC. 2018  
PROJECT NO. 20150110-007  
FILE NO. 03-50-25  
SCALE: #####

**GENERATOR #1  
SITE PLAN**

SHEET NUMBER  
**E09**

**ELECTRICAL ROOM**



**FPL TRANSFORMER  
VAULT**

PROVIDE NEW CONTROL DC WIRING AND (1) 4/C MODBUS SHIELED CABLE (SEE NOTE #1)

ADD CONDUCTORS; UTILIZE EX. SPARE UG CONDUIT

NEW GENERATOR CONTROLLER

GENERATOR

DAY TANK

PNL "L3A"

PNL "L3"

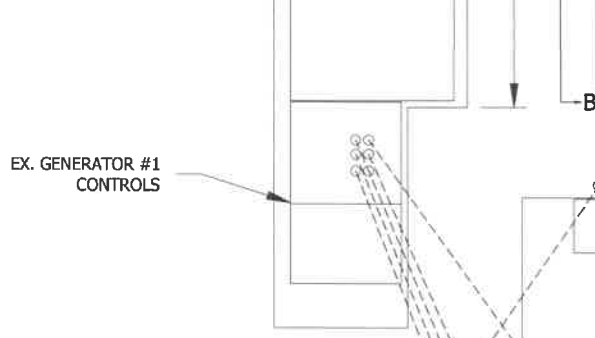
CONTROL CABINET #1

ERP-4

ERP-3

RP-2

**EXISTING GENERATOR  
SITE PLAN**



**FPL TRANSFORMER  
VAULT**

BATTERY CABINET

ABANDON UG CONDUIT

GENERATOR

DAY TANK

PNL "L3A"

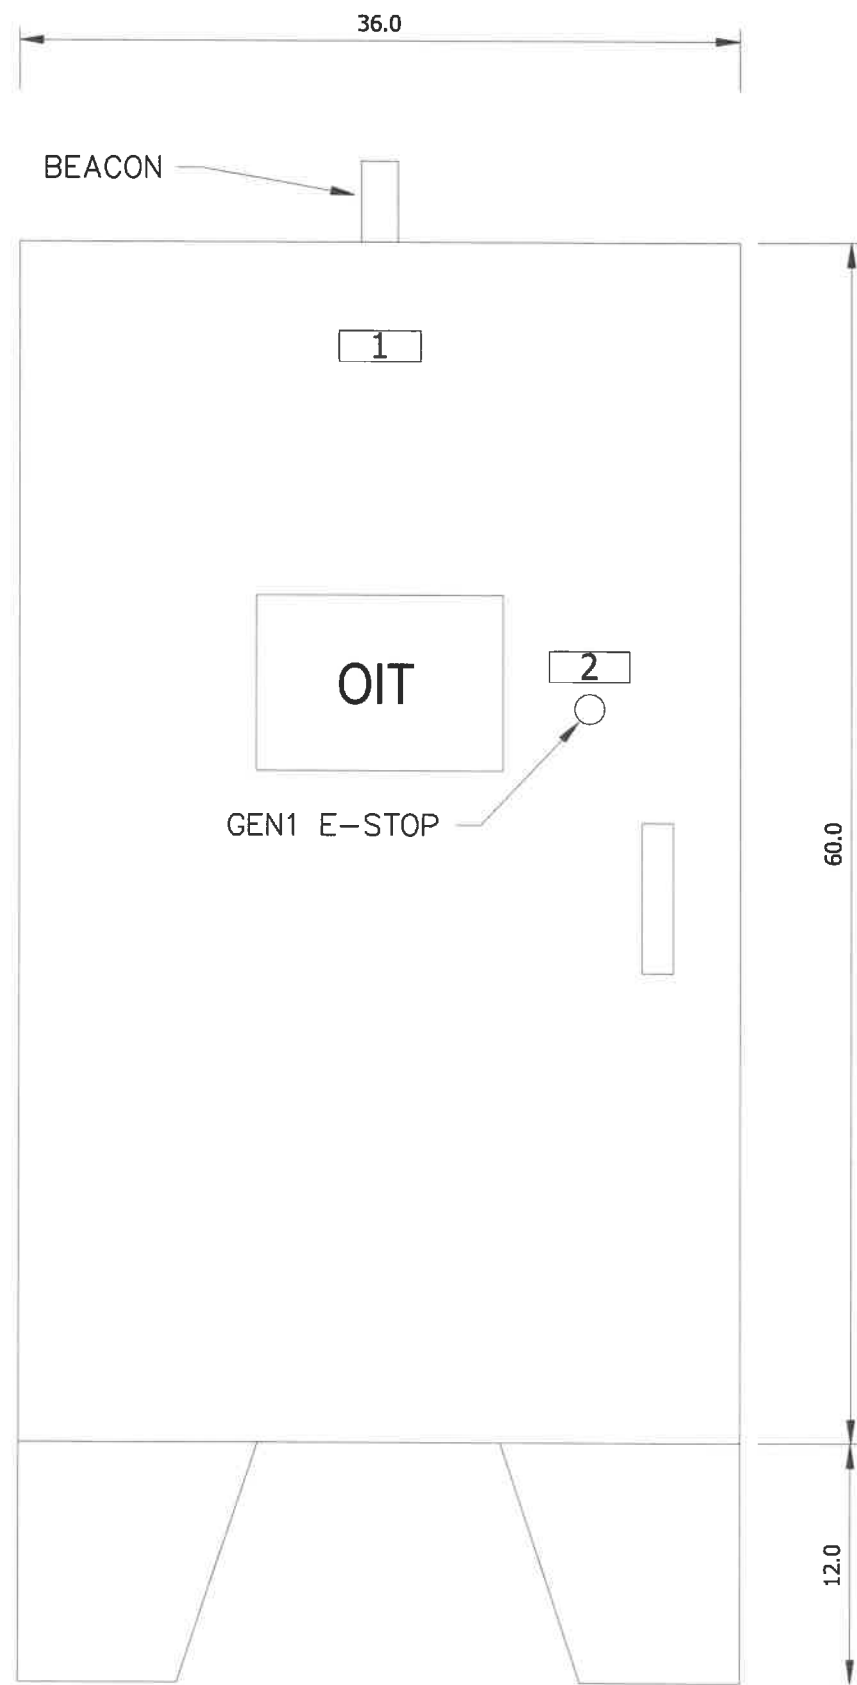
PNL "L3"

CONTROL CABINET #1

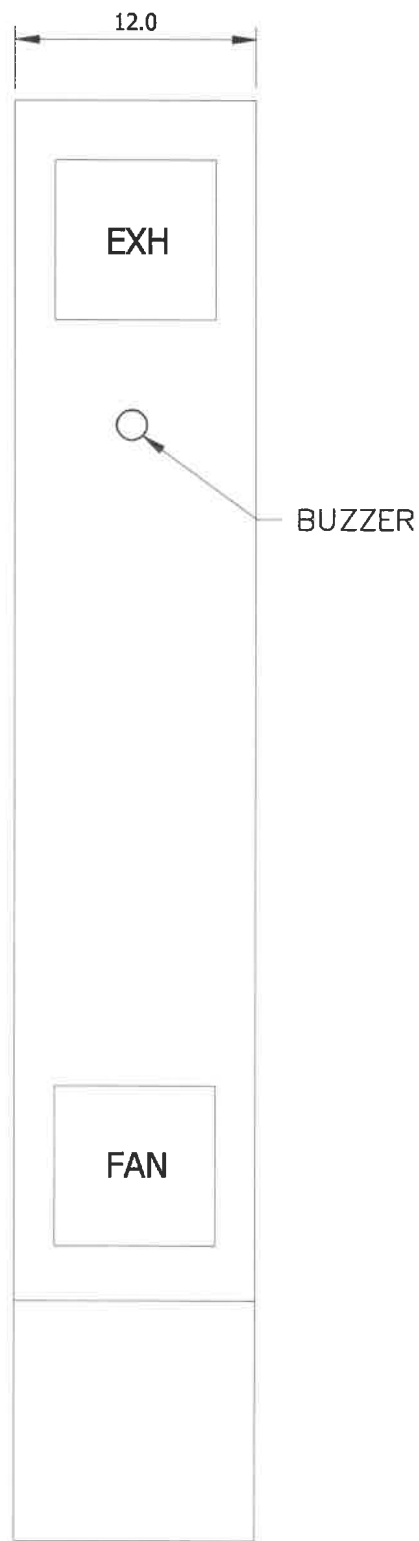
ERP-4

ERP-3

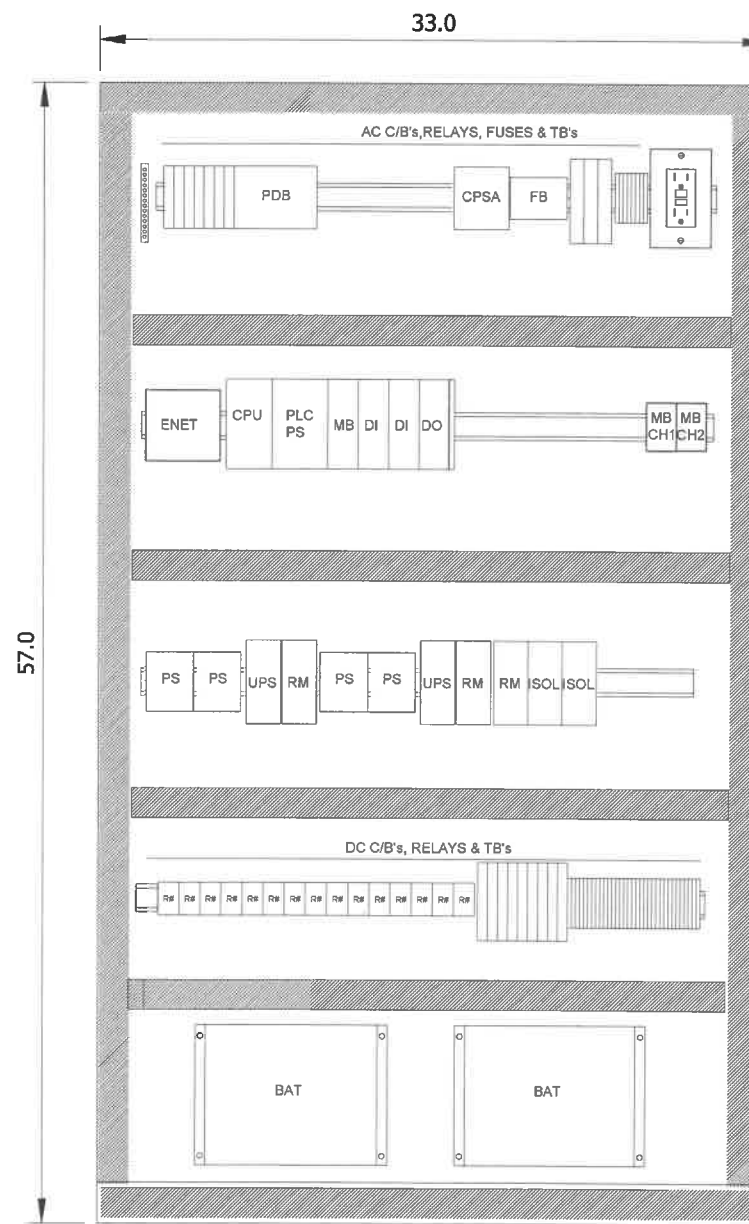
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EXTERIOR VIEW



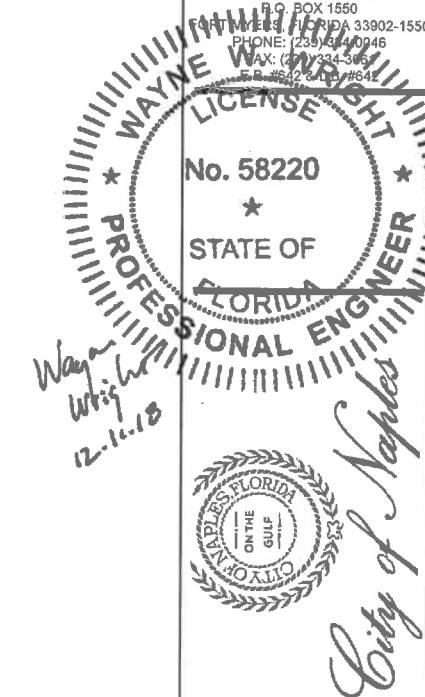
RIGHT SIDE VIEW



INTERIOR VIEW

| CP-SWGR1 - NAMEPLATES |                    |                   |                            |
|-----------------------|--------------------|-------------------|----------------------------|
| POSITION              | PLATE COLOR / SIZE | TEXT COLOR / SIZE | ENGRAVING (L1 L2 L3)       |
| 1                     | BLK / 1.5"H x 4"W  | WHT / .25"        | SWITCHGEAR-1 CONTROL PANEL |
| 2                     | BLK / 1"H x 3"W    | WHT / .25"        | GEN #1 E-STOP              |
|                       |                    |                   |                            |

**JOHNSON**  
ENGINEERING  
JOHNSON ENGINEERING, INC.  
2122 JOHNSON STREET  
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PHONE: (239) 444-0046  
FAX: (239) 434-5065  
E-MAIL: jeh@johnsoneng.com



CITY OF NAPLES WWTP  
SWITCHGEAR REPLACEMENT  
CONSTRUCTION PLANS  
CITY OF NAPLES  
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DATE: DEC. 2018  
PROJECT NO. 20150110-007  
FILE NO. 03-50-25  
SCALE: 1" = 10'

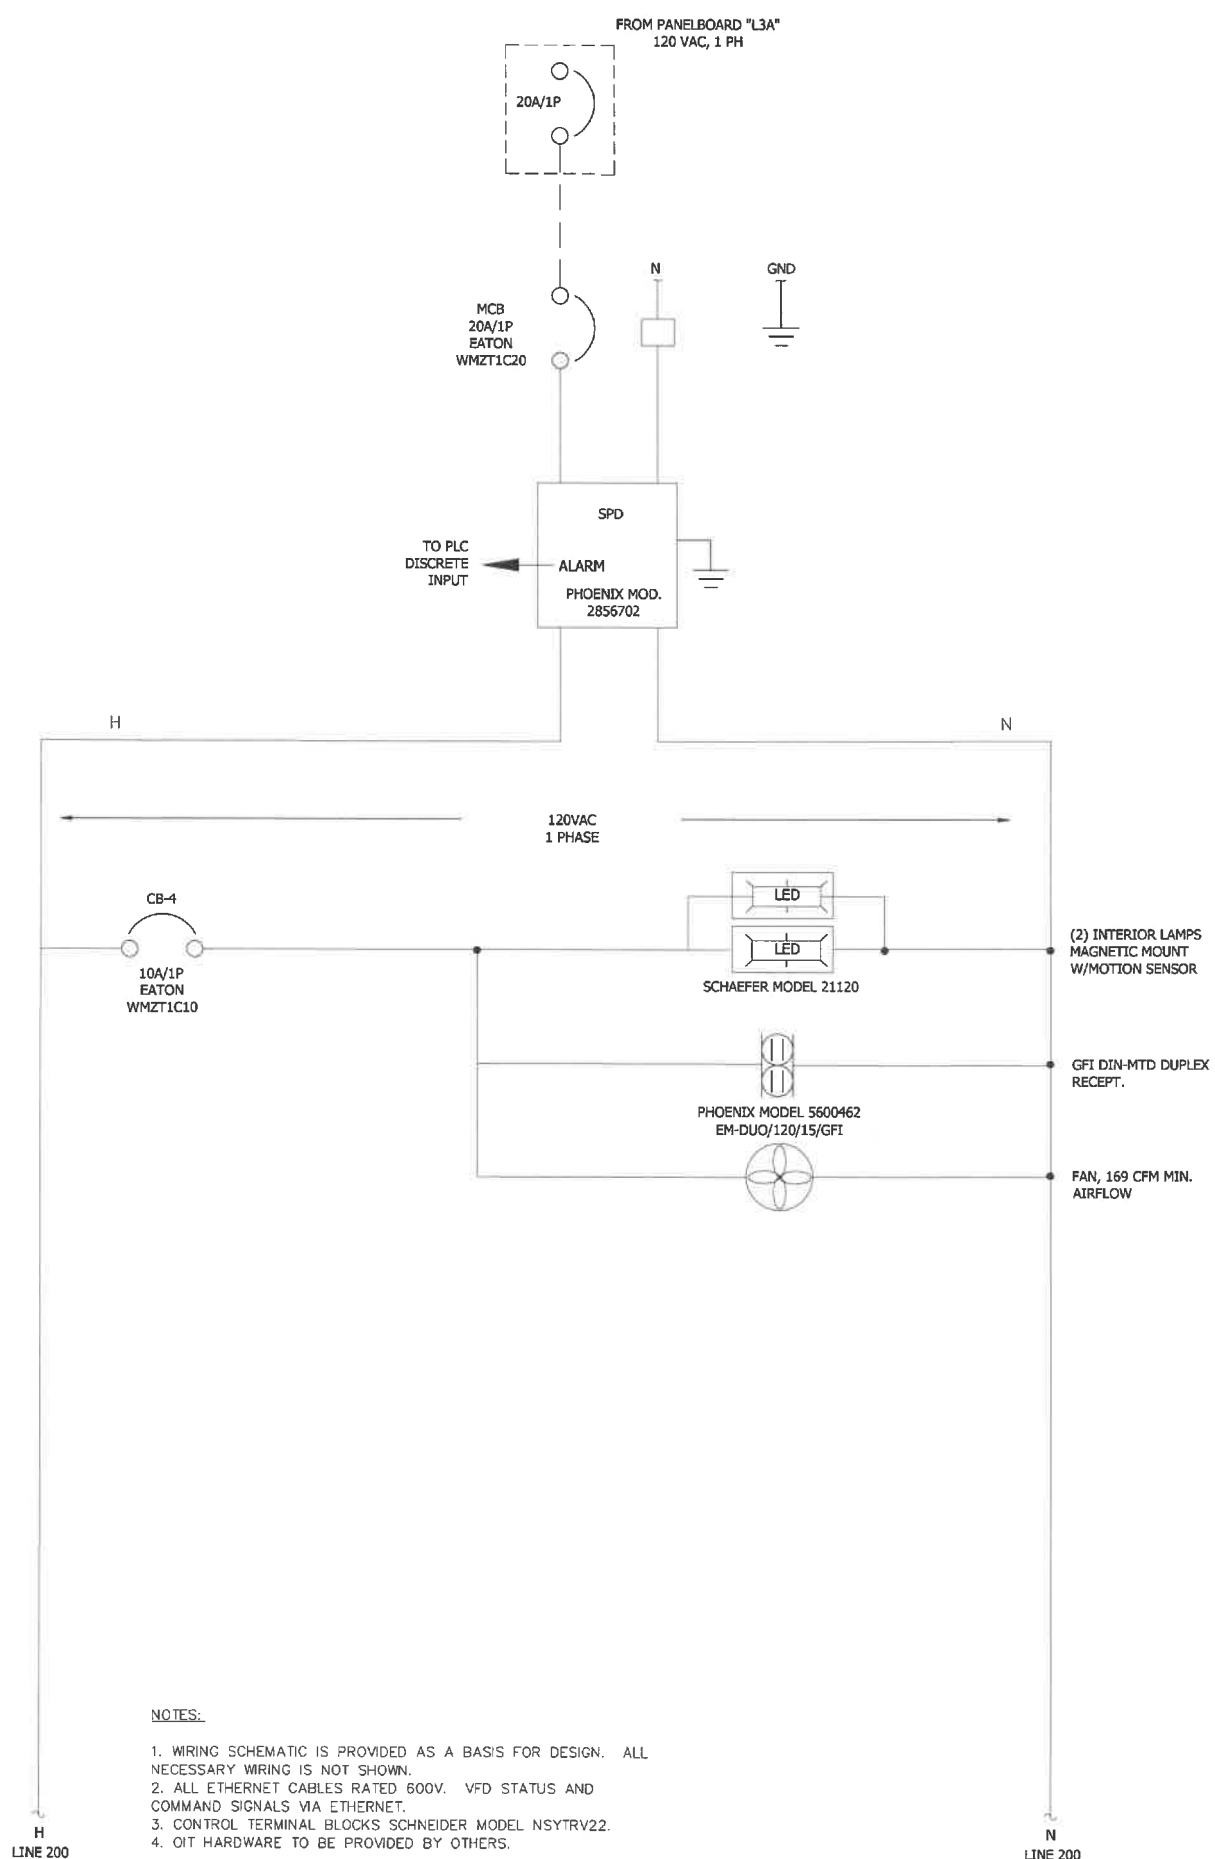
CP-SWGR-1  
CONTROL PANEL  
LAYOUT

SHEET NUMBER

E10



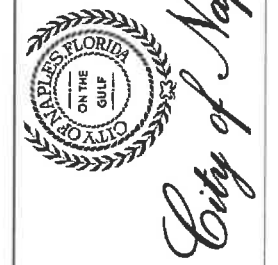
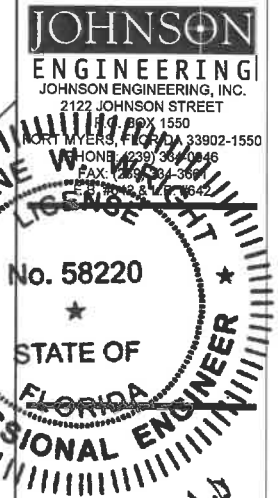
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- NOTES:
1. WIRING SCHEMATIC IS PROVIDED AS A BASIS FOR DESIGN. ALL NECESSARY WIRING IS NOT SHOWN.
  2. ALL ETHERNET CABLES RATED 600V. VFD STATUS AND COMMAND SIGNALS VIA ETHERNET.
  3. CONTROL TERMINAL BLOCKS SCHNEIDER MODEL NSYTRV22.
  4. OIT HARDWARE TO BE PROVIDED BY OTHERS.

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| SWGR1 CP I/O LIST     |                          |                           |          |                  |
|-----------------------|--------------------------|---------------------------|----------|------------------|
|                       | PT                       | DESCRIPTION               | DEVICE   | NOTES            |
| PROSOFT<br>MV169E-MBS | MODBUS MODULE SLOT 1     |                           |          |                  |
|                       | ETH                      |                           |          |                  |
|                       | P1                       | MODBUS #1                 | PLC      | MODBUS 4W RS-485 |
|                       | P2                       | MODBUS #2                 | PLC      | MODBUS 4W RS-485 |
| AB<br>1769-IQ16       | DISCRETE INPUTS SLOT 2   |                           |          |                  |
|                       | 0                        | PANEL SPD ALARM           | SPD      | FAILSAFE WIRING  |
|                       | 1                        | REDUNDANCY OK             | RM-A     | FAILSAFE WIRING  |
|                       | 2                        | REPLACE BATTERY           |          | FAILSAFE WIRING  |
|                       | 3                        | BATTERY BUFFERING         | UPS-A    | FAILSAFE WIRING  |
|                       | 4                        | UPS READY                 |          | FAILSAFE WIRING  |
|                       | 5                        | REDUNDANCY OK             | RM-B     | FAILSAFE WIRING  |
|                       | 6                        | REPLACE BATTERY           |          | FAILSAFE WIRING  |
|                       | 7                        | BATTERY BUFFERING         | UPS-B    | FAILSAFE WIRING  |
|                       | 8                        | UPS READY                 |          | FAILSAFE WIRING  |
|                       | 9                        | REDUNDANCY OK             | RM-C     | FAILSAFE WIRING  |
|                       | 10                       | SERVICE #1 POWER OK       | PM1      | FAILSAFE WIRING  |
|                       | 11                       | SERVICE #2 POWER OK       | PM2      | FAILSAFE WIRING  |
|                       | 12                       | GENERATOR #1 POWER OK     | PM3      | FAILSAFE WIRING  |
|                       | 13                       | spare                     |          |                  |
| 14                    | spare                    |                           |          |                  |
| 15                    | spare                    |                           |          |                  |
| AB<br>1769-IQ16       | DISCRETE INPUTS SLOT 3   |                           |          |                  |
|                       | 0                        | BREAKER M1 STATUS         | M1 C/B   | 1 = CLOSED       |
|                       | 1                        | BREAKER M2 STATUS         | M2 C/B   | 1 = CLOSED       |
|                       | 2                        | BREAKER GEN1 STATUS       | GEN1 C/B | 1 = CLOSED       |
|                       | 3                        | BREAKER TIE STATUS        | TIE C/B  | 1 = CLOSED       |
|                       | 4                        | GEN #1 EMER. STOP PB      | E-STOP   | FAILSAFE WIRING  |
|                       | 5                        | GEN #1 RUNNING            | GEN #1   |                  |
|                       | 6                        | GEN #1 NOT IN AUTO        | GEN #1   |                  |
|                       | 7                        | GEN #1 READY TO LOAD      | GEN #1   |                  |
|                       | 8                        | GEN #1 COMMON WARNING     | GEN #1   |                  |
|                       | 9                        | GEN #1 COMMON ALARM       | GEN #1   |                  |
|                       | 10                       | GEN #1 COMMON SHUTDOWN    | GEN #1   |                  |
|                       | 11                       | spare                     |          |                  |
|                       | 12                       | spare                     |          |                  |
|                       | 13                       | spare                     |          |                  |
| 14                    | spare                    |                           |          |                  |
| 15                    | spare                    |                           |          |                  |
| AB<br>1769-OB16       | DISCRETE OUTPUTS SLOT #4 |                           |          |                  |
|                       | 0                        | BREAKER M1 SHUNT TRIP     | M1 C/B   | RELAY            |
|                       | 1                        | BREAKER M2 SHUNT TRIP     | M2 C/B   | RELAY            |
|                       | 2                        | BREAKER GEN1 SHUNT TRIP   | GEN1 C/B | RELAY            |
|                       | 3                        | BREAKER TIE SHUNT TRIP    | TIE C/B  | RELAY            |
|                       | 4                        | GEN #1 START/STOP COMMAND | GEN #1   | RELAY            |
|                       | 5                        | spare                     |          | RELAY            |
|                       | 6                        | spare                     |          | RELAY            |
|                       | 7                        | spare                     |          | RELAY            |
|                       | 8                        | spare                     |          | RELAY            |
|                       | 9                        | spare                     |          | RELAY            |
|                       | 10                       | spare                     |          | RELAY            |
|                       | 11                       | spare                     |          | RELAY            |
|                       | 12                       | spare                     |          | RELAY            |
|                       | 13                       | spare                     |          | RELAY            |
| 14                    | BUZZER                   | HORN                      |          |                  |
| 15                    | BEACON                   | BEACON                    |          |                  |



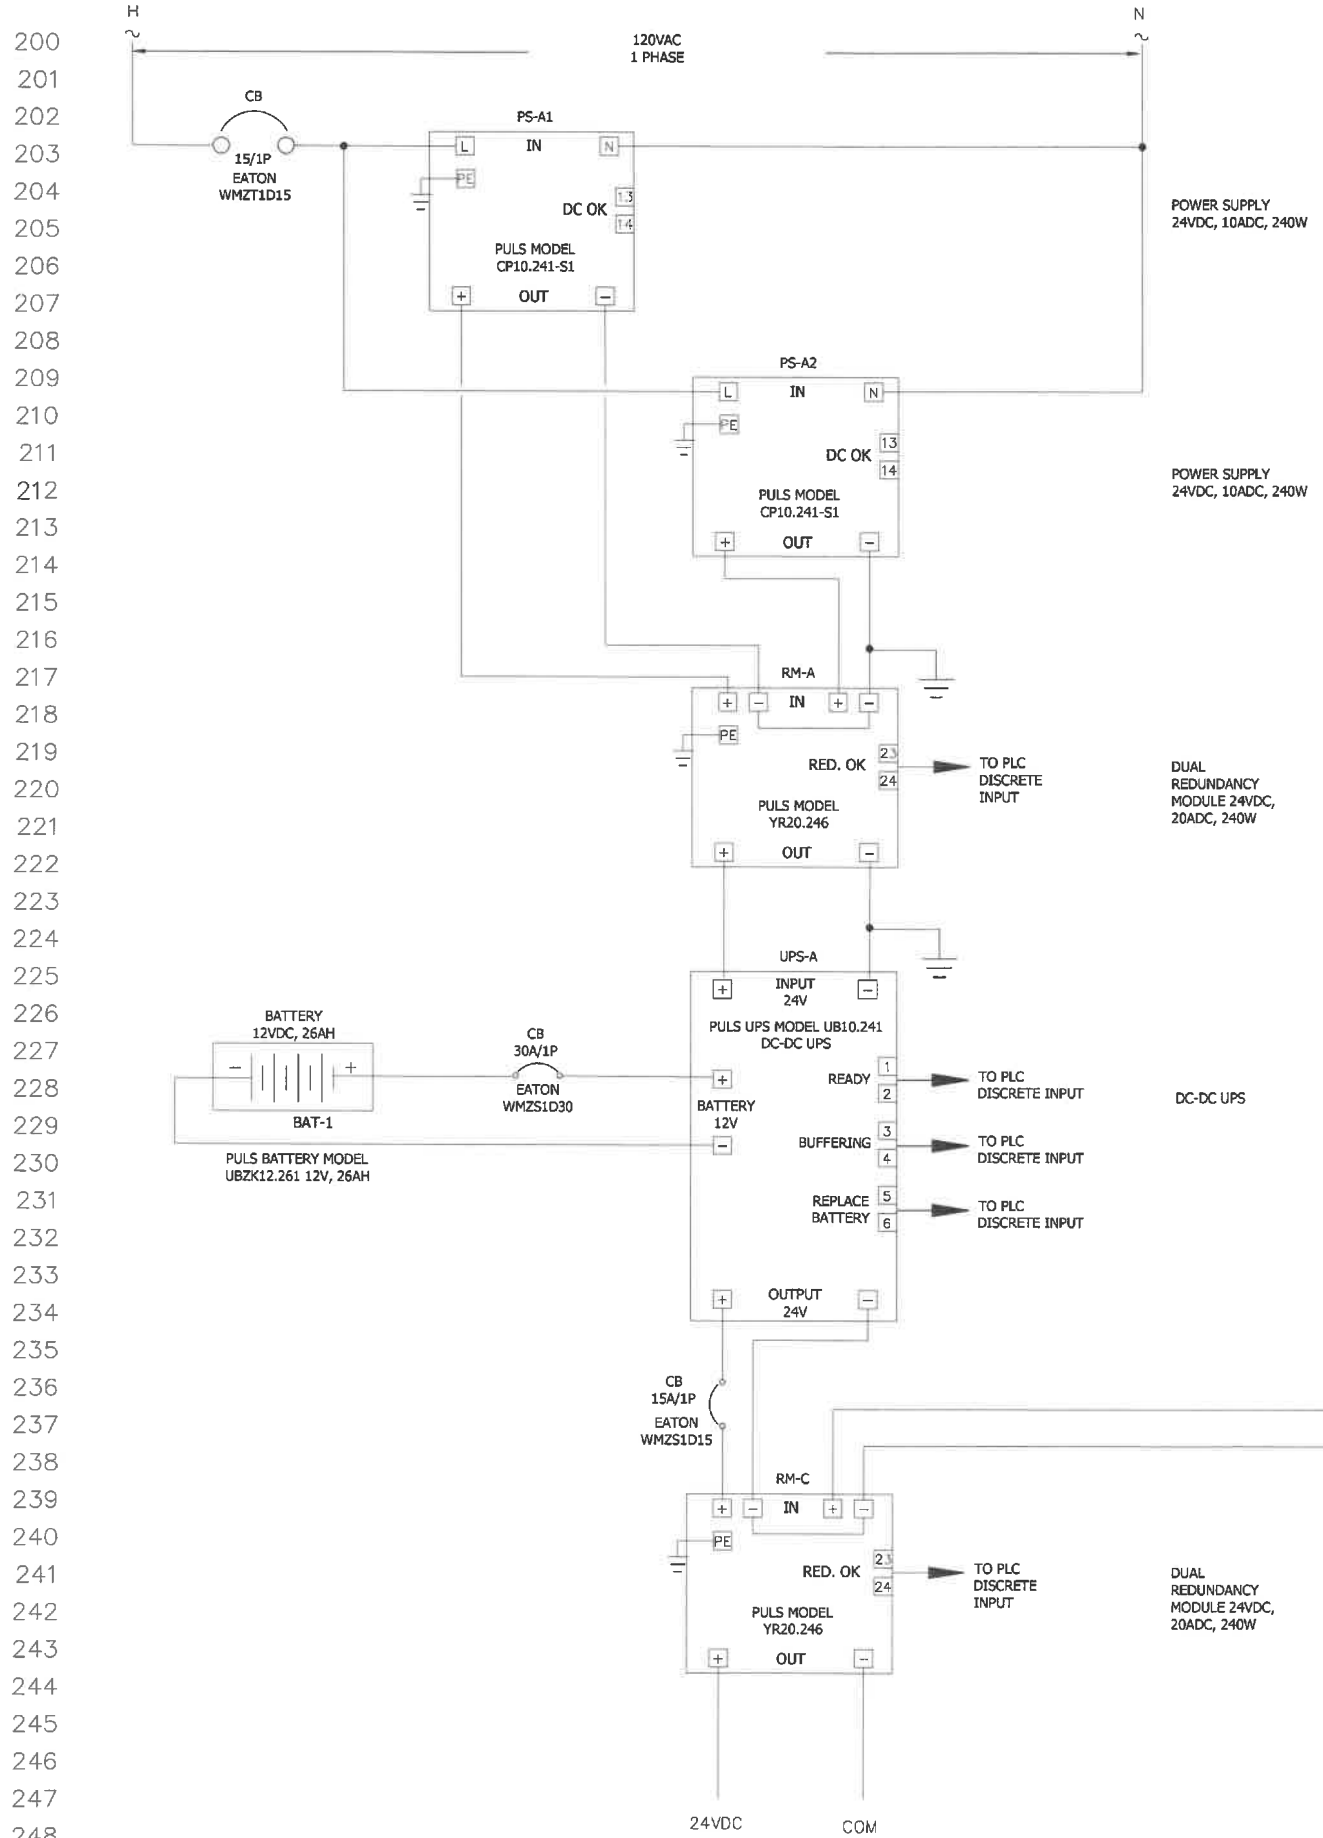
CITY OF NAPLES WWTP  
SWITCHGEAR REPLACEMENT  
CONSTRUCTION PLANS  
CITY OF NAPLES  
NAPLES, FL

| NO. | REVISIONS DESCRIPTION | DATE |
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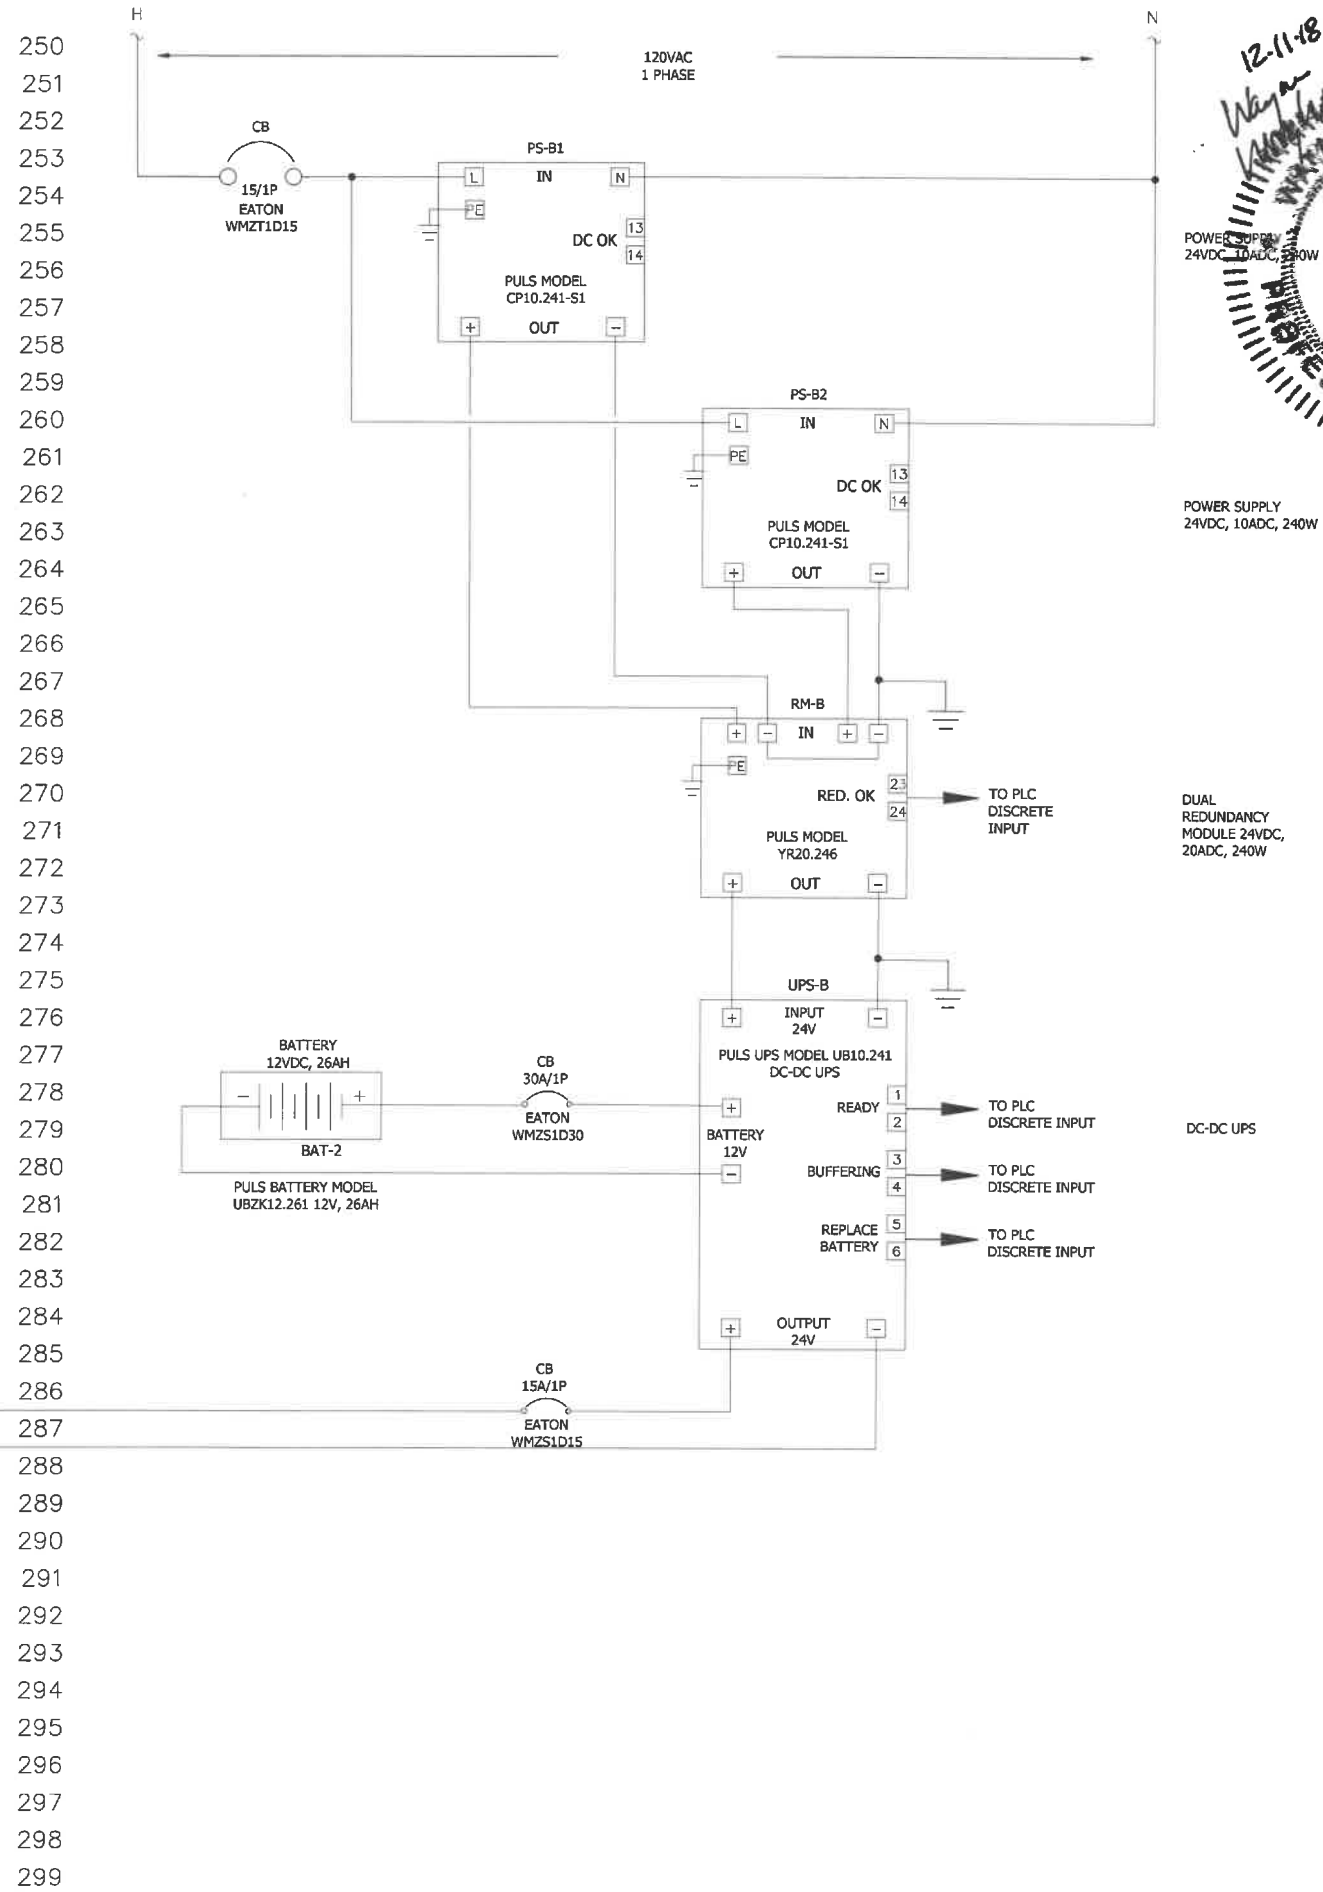
DATE: DEC. 2018  
PROJECT NO. 20150110-007  
FILE NO. 03-50-25  
SCALE: NONE

CP-SWGR-1 PANEL  
SWGR1  
ELECTRICAL  
SCHEMATICS

SHEET NUMBER  
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JOHNSON ENGINEERING  
JOHNSON ENGINEERING, INC.  
11111 JOHNSON STREET  
PORT MYERS, FLORIDA 33902-1550  
PHONE 888-438-4347  
FAX 888-438-4348

No. 18220

STATE OF FLORIDA  
PROFESSIONAL ENGINEER

City of Naples

POWER SUPPLY  
24VDC, 10ADC, 240W

POWER SUPPLY  
24VDC, 10ADC, 240W

DUAL REDUNDANCY MODULE 24VDC, 20ADC, 240W

DUAL REDUNDANCY MODULE 24VDC, 20ADC, 240W

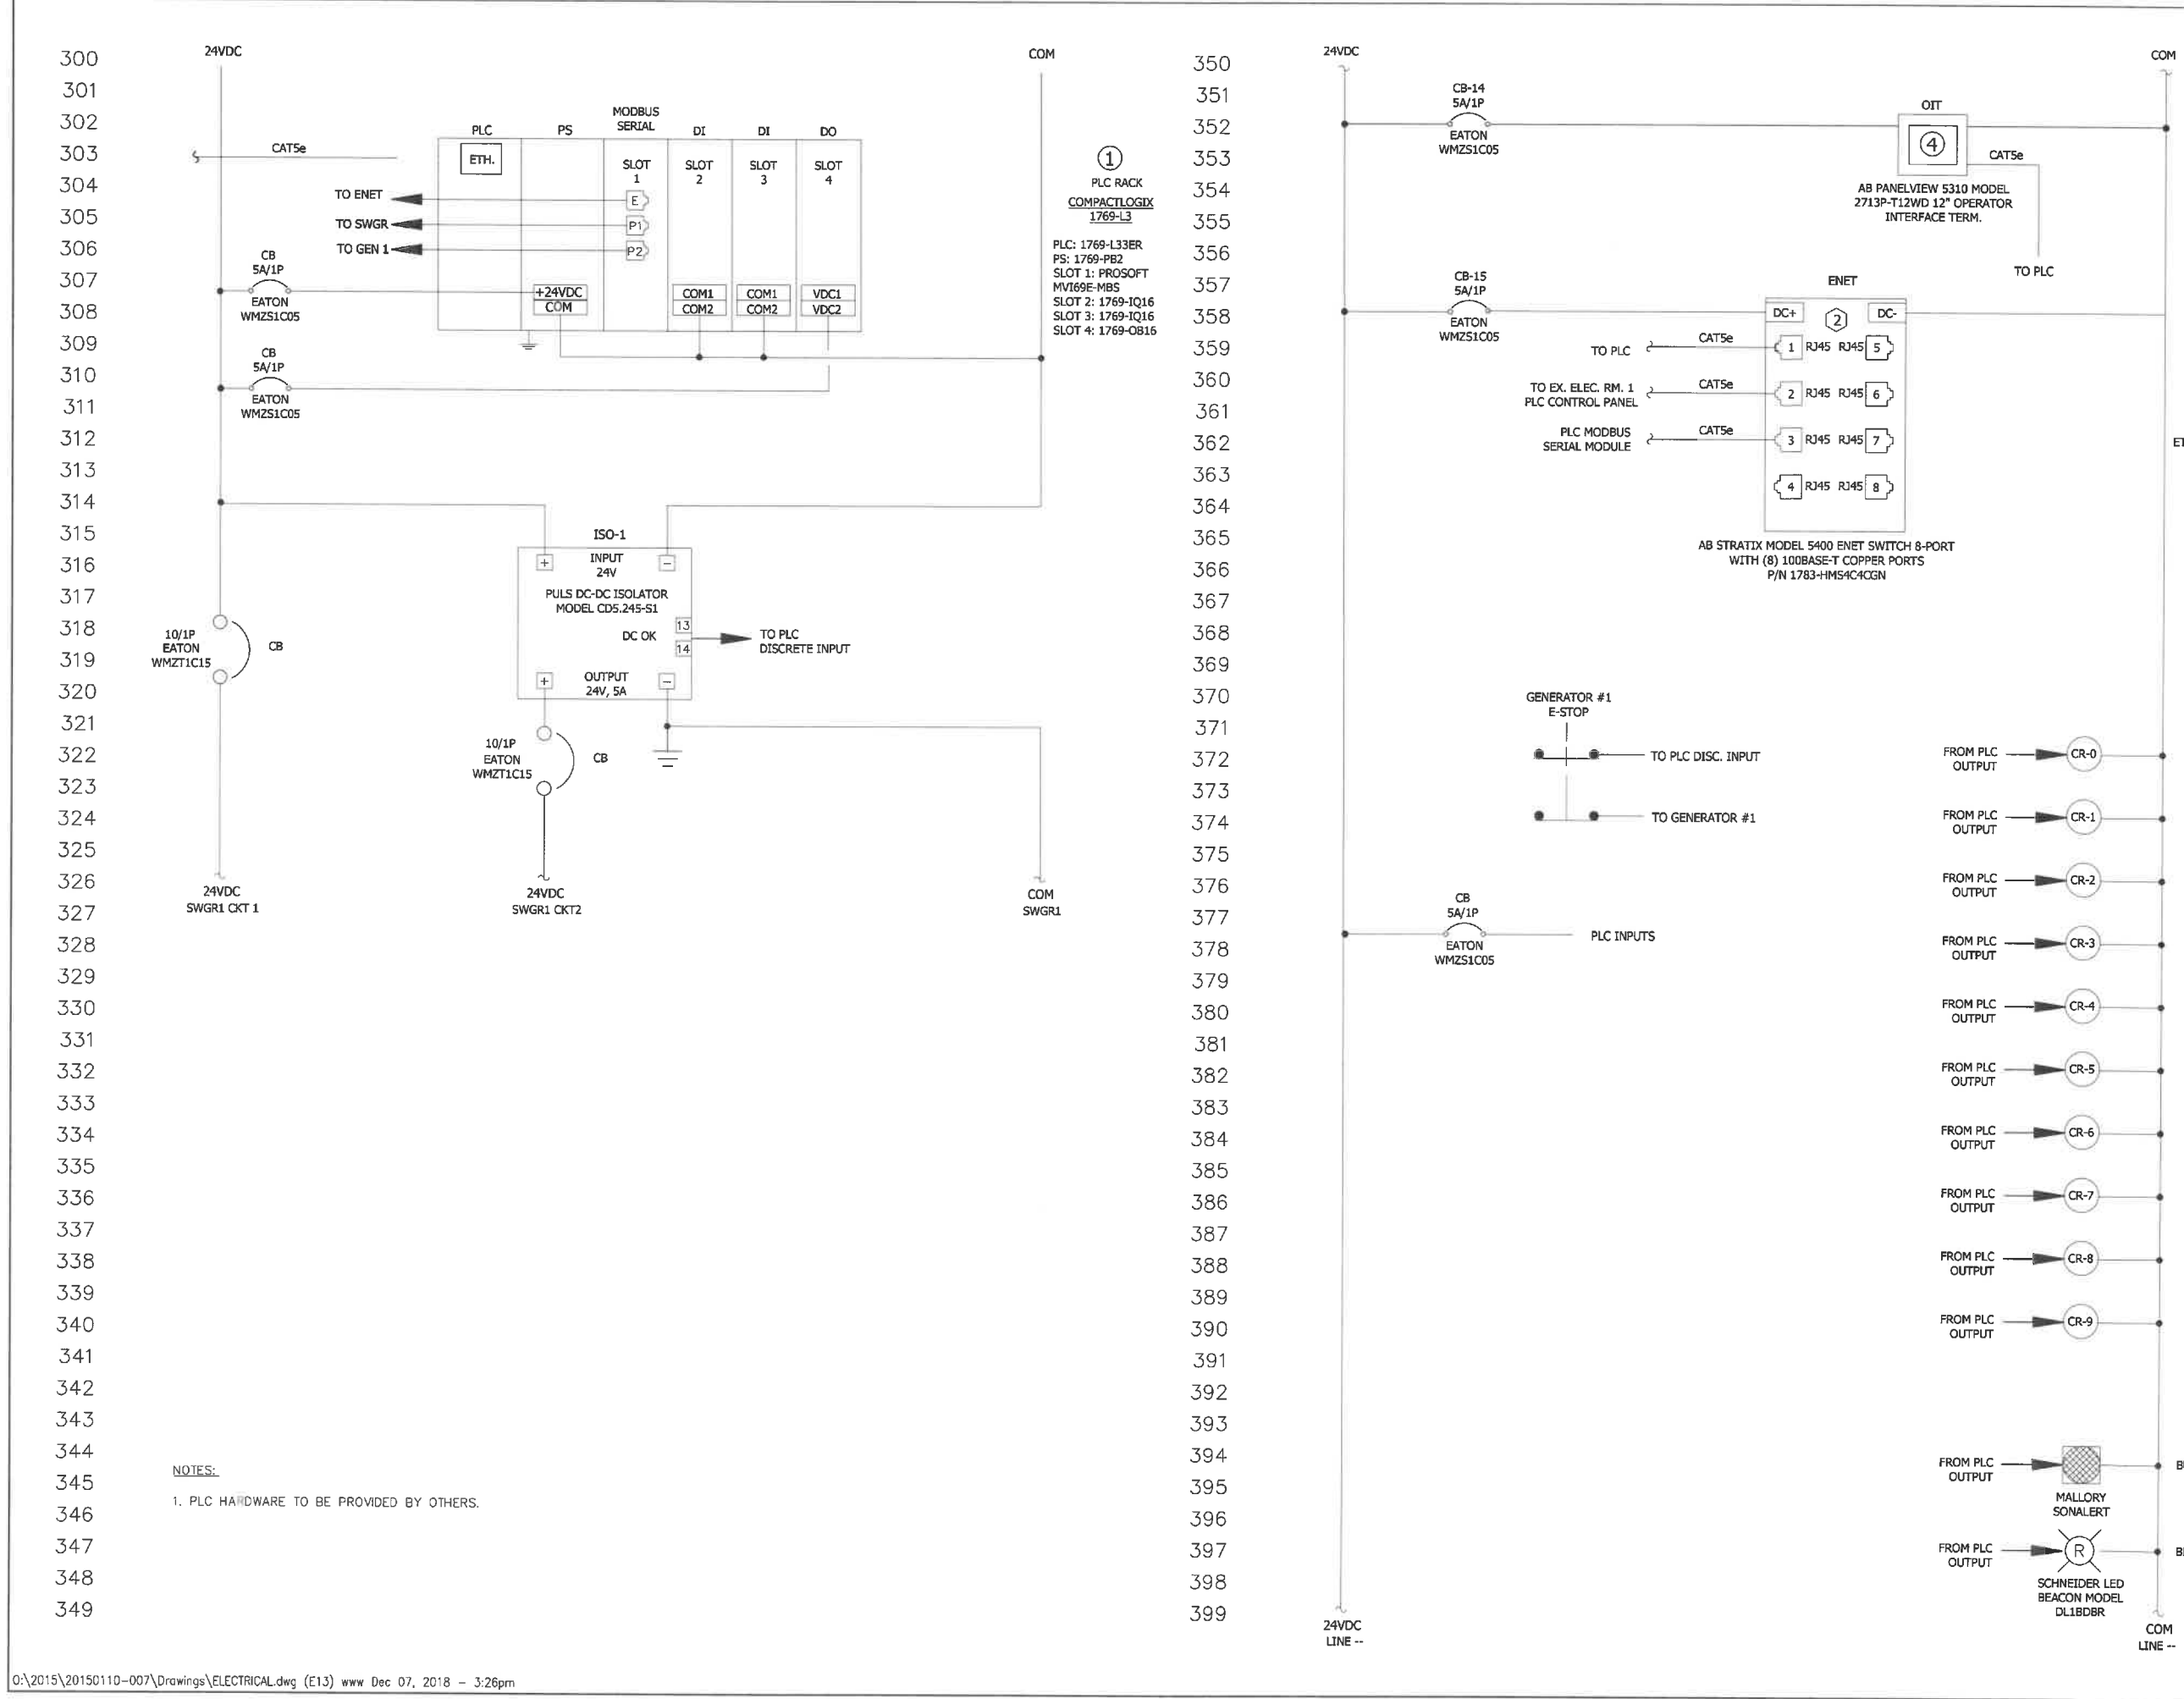
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SCALE: NONE

CP-SWGR-1 PANEL  
SWGR1  
ELECTRICAL  
SCHEMATICS

SHEET NUMBER  
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NOTES:  
1. PLC HARDWARE TO BE PROVIDED BY OTHERS.

**JOHNSON ENGINEERING, INC.**  
JOHNSON ENGINEERING, INC.  
2122 JOHNSON STREET  
NAPLES, FL 34109  
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FAX: (239) 334-0066

**WAYNE WRIGHT**  
PROFESSIONAL ENGINEER  
No. 58220  
STATE OF FLORIDA

*City of Naples*

CITY OF NAPLES WWTP  
SWITCHGEAR REPLACEMENT  
CONSTRUCTION PLANS  
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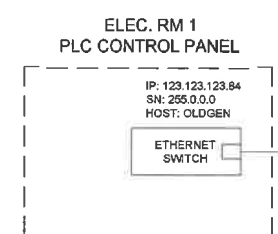
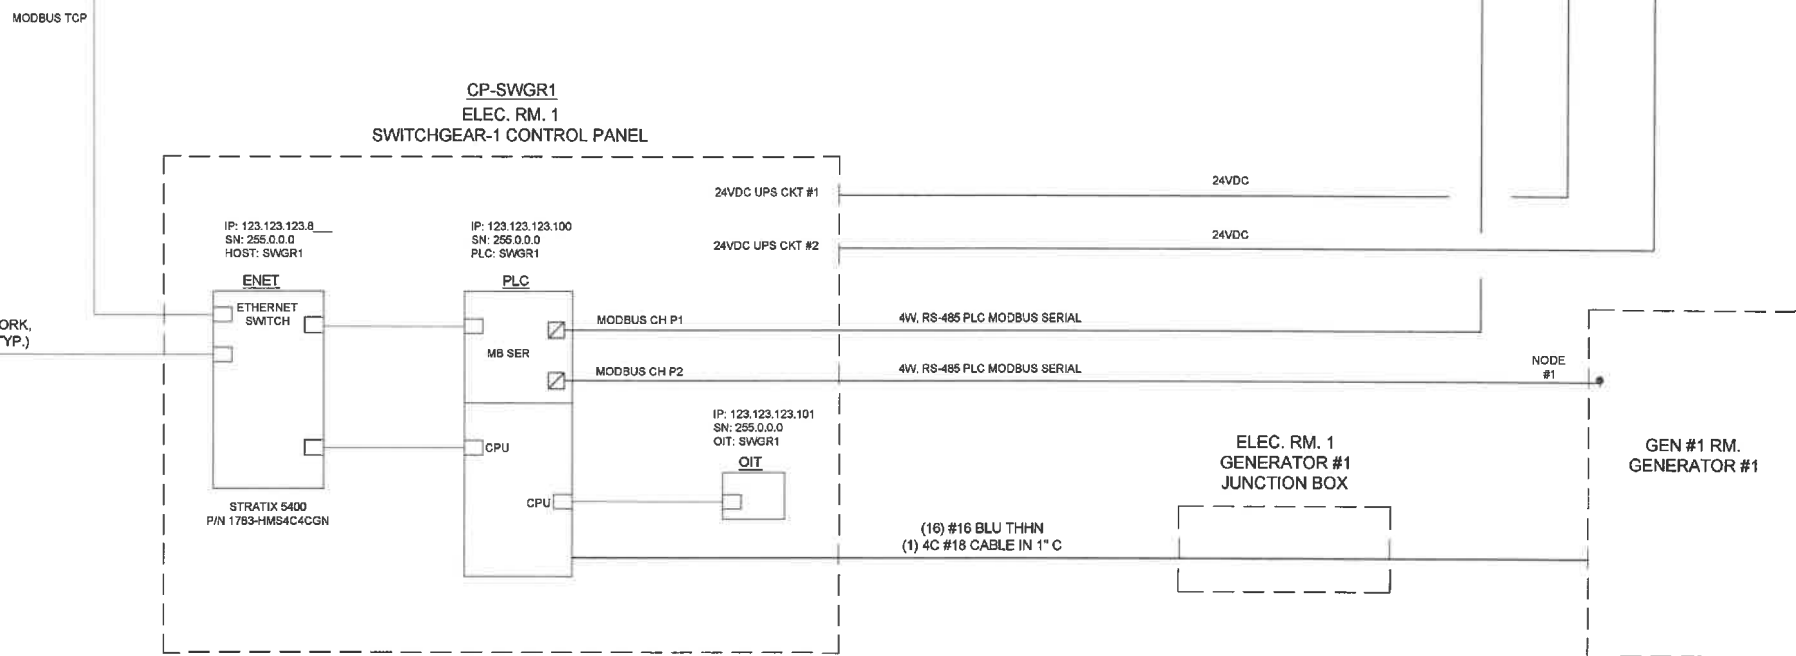
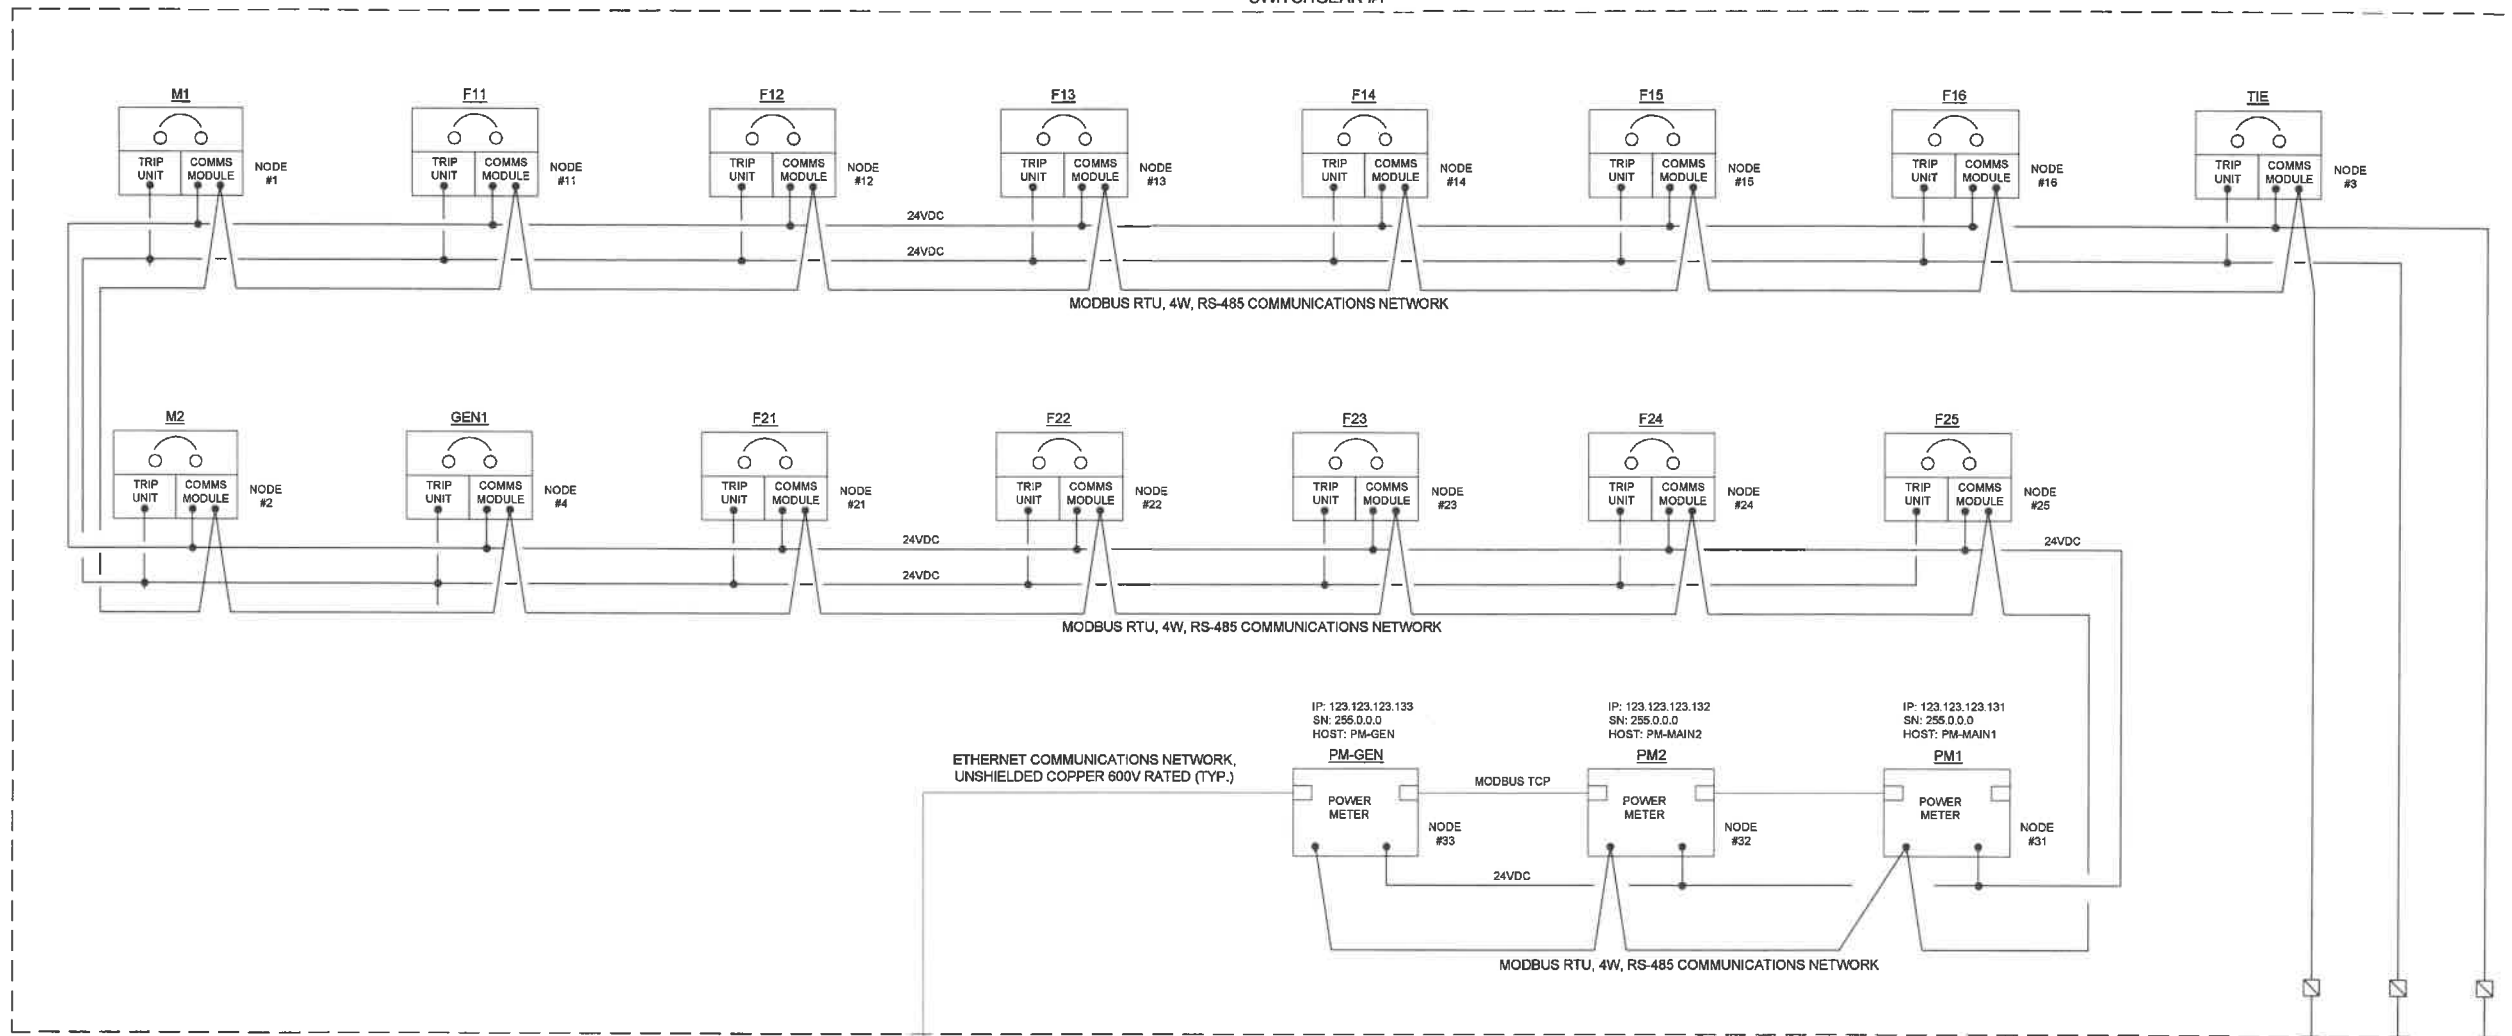
**CP-SWGR-1 PANEL  
SWGR1 ELECTRICAL  
SCHEMATICS**

SHEET NUMBER  
**E13**



- NOTES: (#)
- ETHERNET CABLES TO BE 600V RATED, CAT 5e, 24AWG, SHIELDED TWISTED BONDED PAIRS, BELDEN #7958A, OR EQ.
  - MODBUS CABLE 4C #18 SHIELDED. ALL MODBUS DEVICES TO BE CONFIGURED AS SLAVES.

SWGR1  
ELEC. RM. 1  
SWITCHGEAR #1



**JOHNSON ENGINEERING**  
JOHNSON ENGINEERING, INC.  
2122 JOHNSON STREET  
MYERS, FLORIDA 33902-1550  
PHONE: (239) 934-0000  
FAX: (239) 934-0001

*Wayne*  
*Wayne*  
12-11-18

WAYNE LISERISE  
No. 58220  
STATE OF FLORIDA  
PROFESSIONAL ENGINEER

City of Naples

CITY OF NAPLES WWTP  
SWITCHGEAR REPLACEMENT  
CONSTRUCTION PLANS  
CITY OF NAPLES  
NAPLES, FL

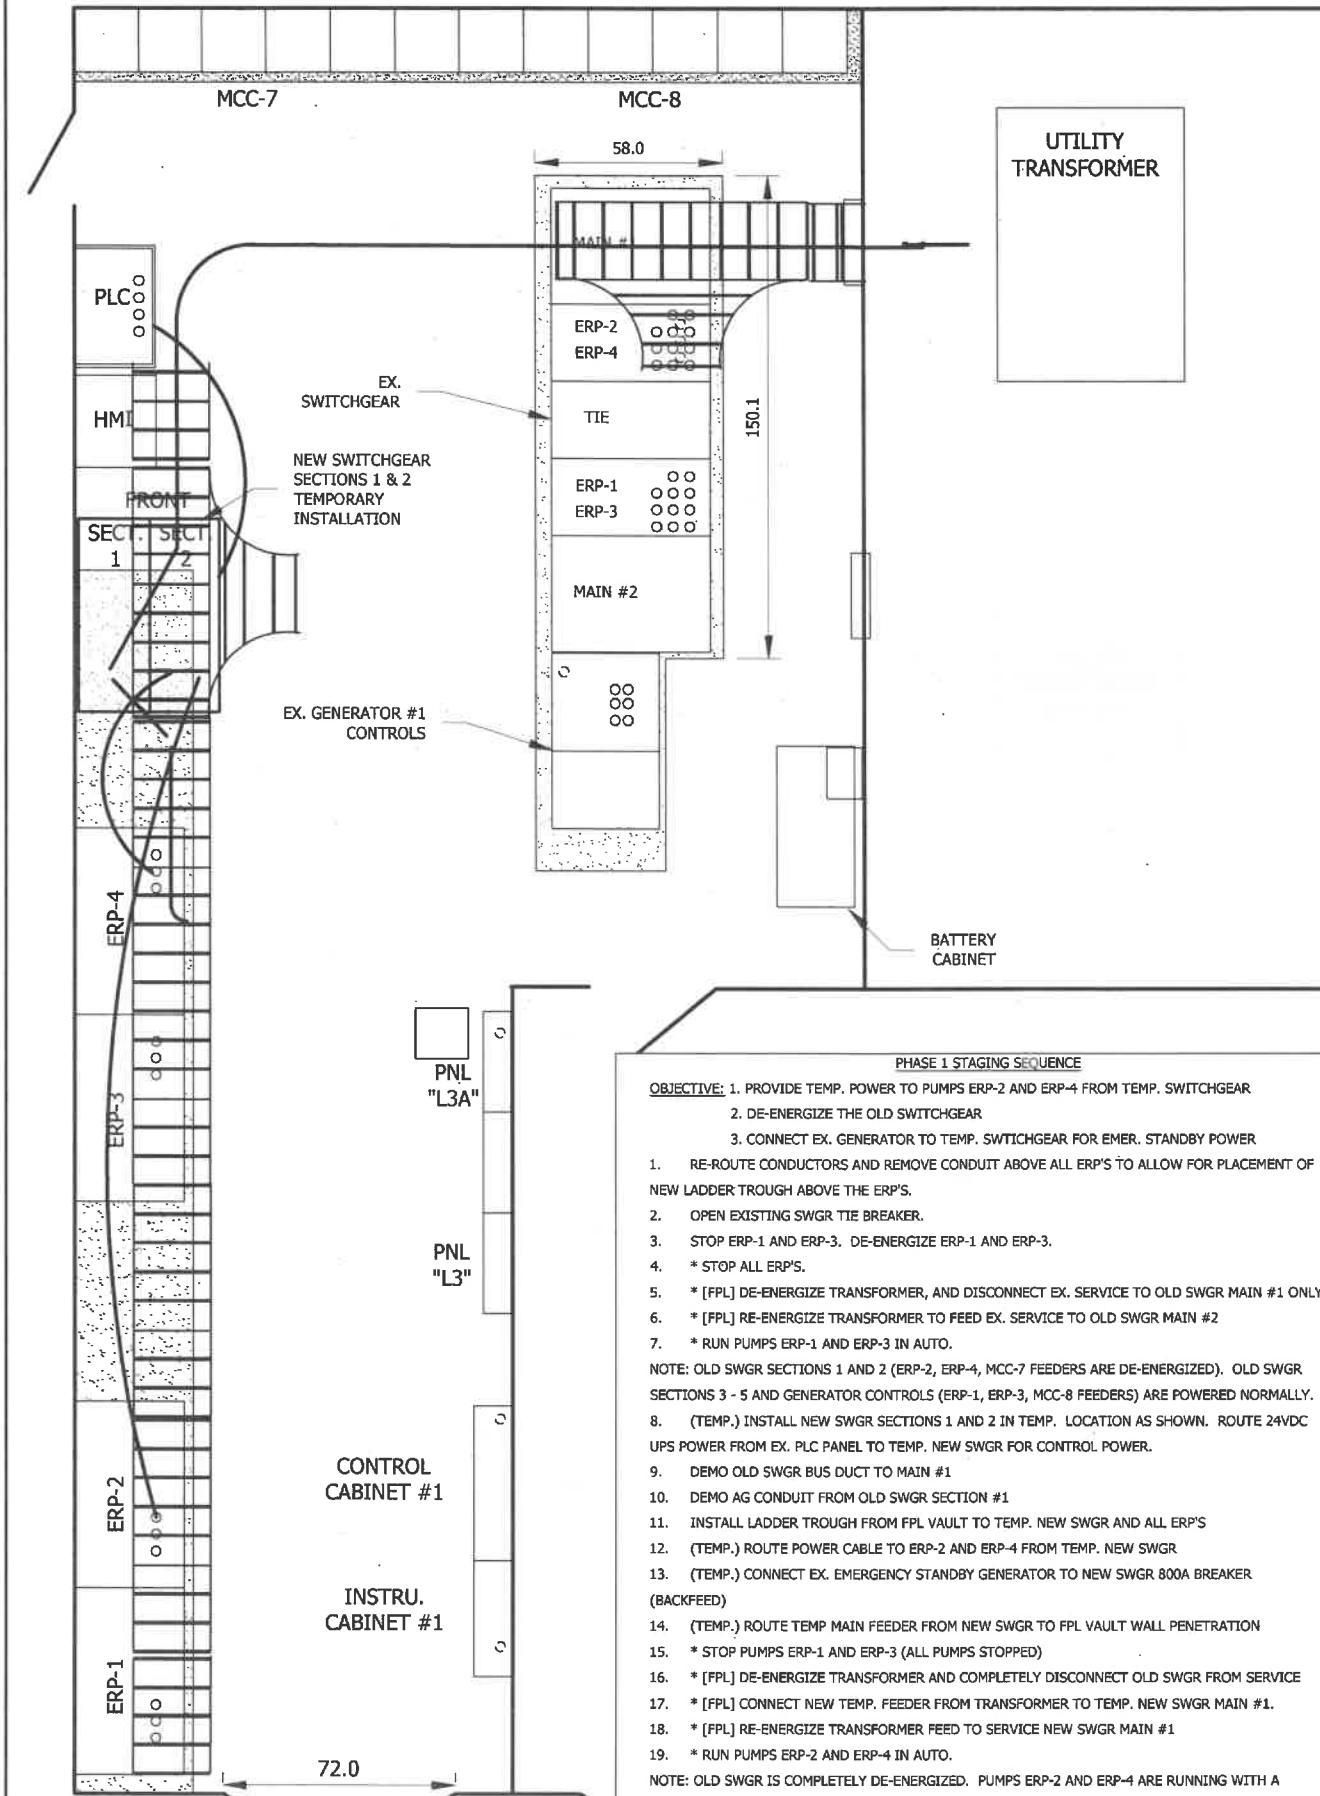
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DATE: DEC. 2018  
PROJECT NO. 20150110-007  
FILE NO. 03-50-25  
SCALE: NONE

SWGR-1 NETWORK  
AND  
INTERCONNECTION  
DIAGRAM

SHEET NUMBER  
E14

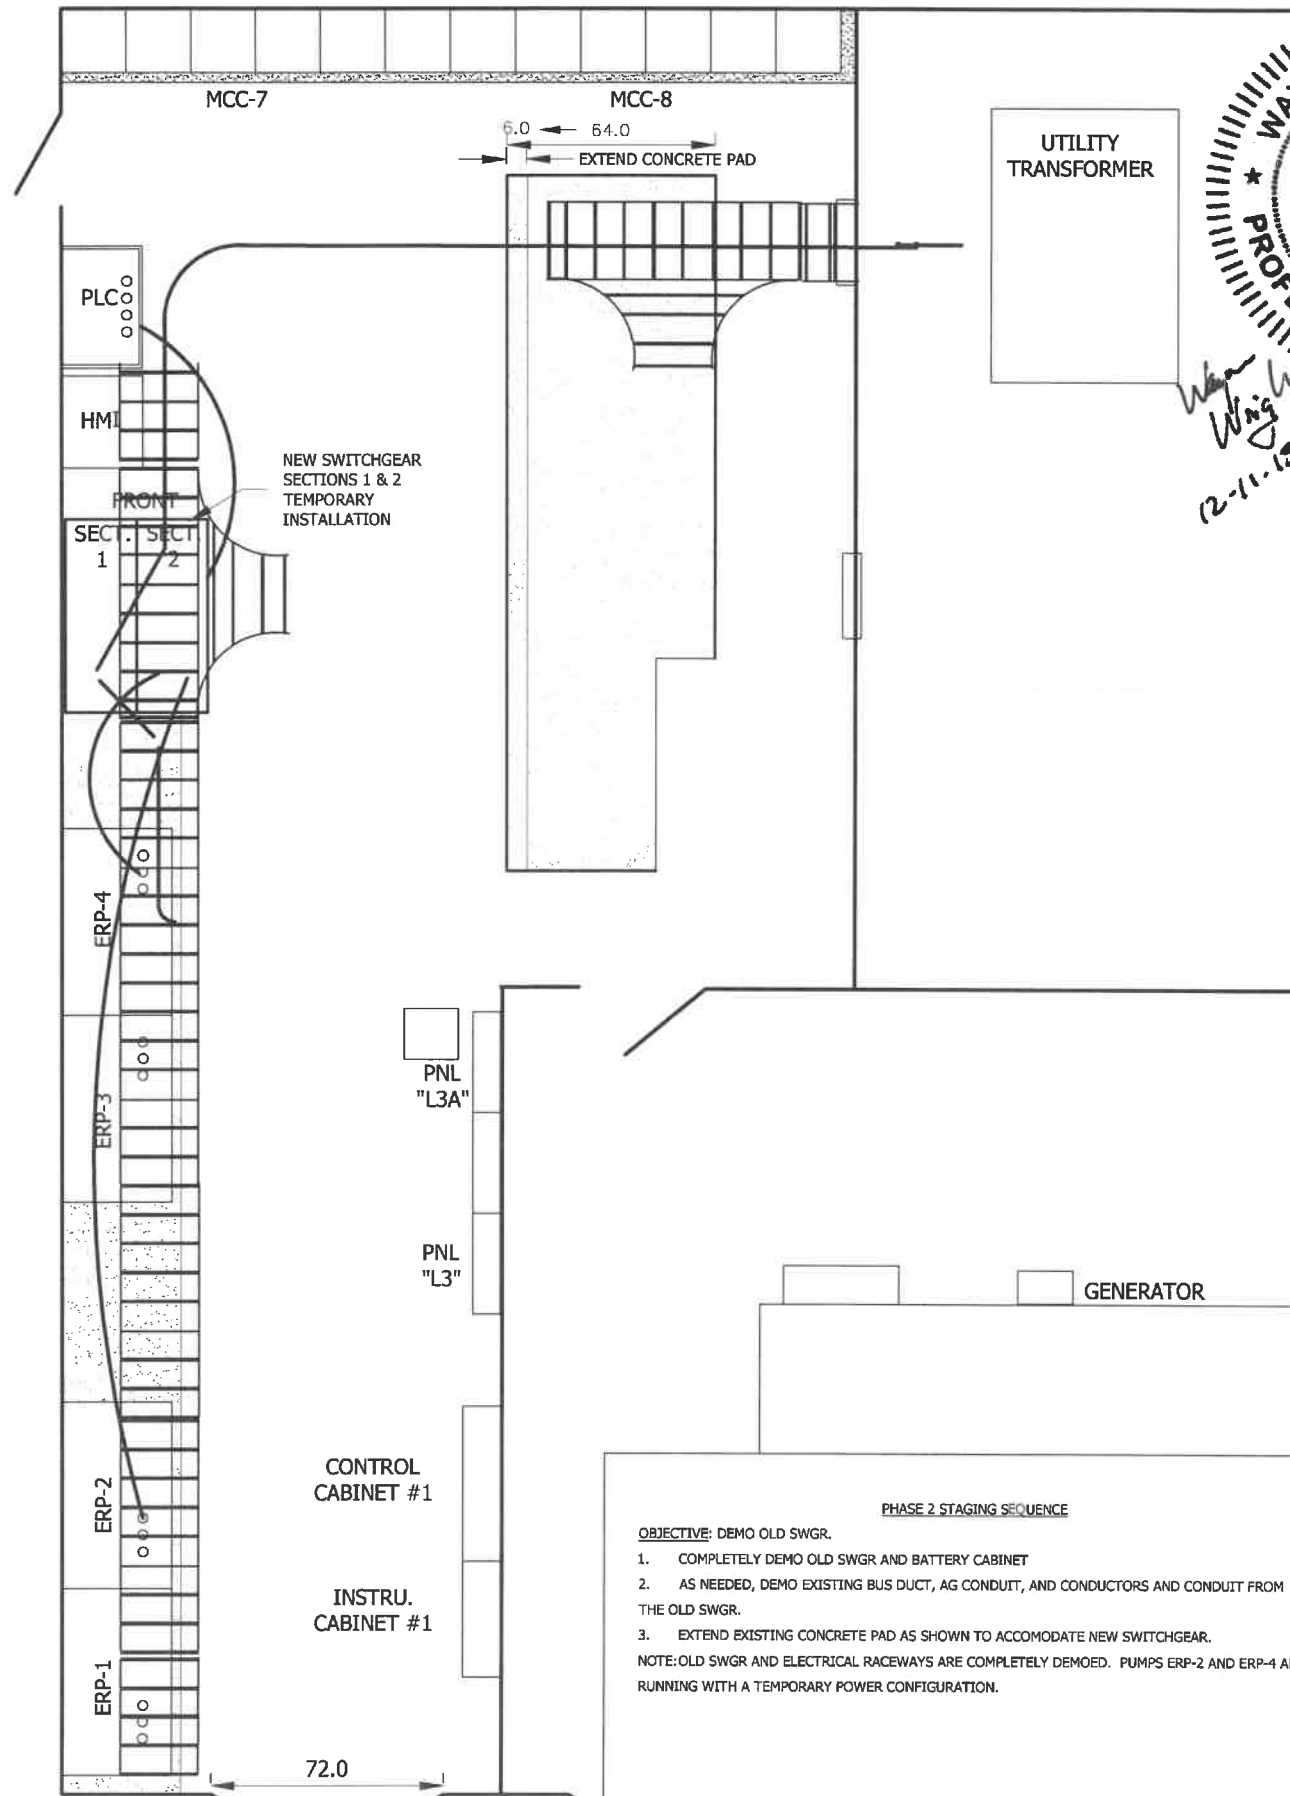
**SWITCHGEAR CONSTRUCTION STAGING PLAN - PHASE 1**



**PHASE 1 STAGING SEQUENCE**

- OBJECTIVE:** 1. PROVIDE TEMP. POWER TO PUMPS ERP-2 AND ERP-4 FROM TEMP. SWITCHGEAR  
 2. DE-ENERGIZE THE OLD SWITCHGEAR  
 3. CONNECT EX. GENERATOR TO TEMP. SWITCHGEAR FOR EMER. STANDBY POWER
- RE-ROUTE CONDUCTORS AND REMOVE CONDUIT ABOVE ALL ERP'S TO ALLOW FOR PLACEMENT OF NEW LADDER TROUGH ABOVE THE ERP'S.
  - OPEN EXISTING SWGR TIE BREAKER.
  - STOP ERP-1 AND ERP-3. DE-ENERGIZE ERP-1 AND ERP-3.
  - \* STOP ALL ERP'S.
  - \* [FPL] DE-ENERGIZE TRANSFORMER, AND DISCONNECT EX. SERVICE TO OLD SWGR MAIN #1 ONLY
  - \* [FPL] RE-ENERGIZE TRANSFORMER TO FEED EX. SERVICE TO OLD SWGR MAIN #2
  - \* RUN PUMPS ERP-1 AND ERP-3 IN AUTO.
- NOTE: OLD SWGR SECTIONS 1 AND 2 (ERP-2, ERP-4, MCC-7 FEEDERS ARE DE-ENERGIZED). OLD SWGR SECTIONS 3 - 5 AND GENERATOR CONTROLS (ERP-1, ERP-3, MCC-8 FEEDERS) ARE POWERED NORMALLY.
- (TEMP.) INSTALL NEW SWGR SECTIONS 1 AND 2 IN TEMP. LOCATION AS SHOWN. ROUTE 24VDC UPS POWER FROM EX. PLC PANEL TO TEMP. NEW SWGR FOR CONTROL POWER.
  - DEMO OLD SWGR BUS DUCT TO MAIN #1
  - DEMO AG CONDUIT FROM OLD SWGR SECTION #1
  - INSTALL LADDER TROUGH FROM FPL VAULT TO TEMP. NEW SWGR AND ALL ERP'S
  - (TEMP.) ROUTE POWER CABLE TO ERP-2 AND ERP-4 FROM TEMP. NEW SWGR
  - (TEMP.) CONNECT EX. EMERGENCY STANDBY GENERATOR TO NEW SWGR 800A BREAKER (BACKFEED)
  - (TEMP.) ROUTE TEMP MAIN FEEDER FROM NEW SWGR TO FPL VAULT WALL PENETRATION
  - \* STOP PUMPS ERP-1 AND ERP-3 (ALL PUMPS STOPPED)
  - \* [FPL] DE-ENERGIZE TRANSFORMER AND COMPLETELY DISCONNECT OLD SWGR FROM SERVICE
  - \* [FPL] CONNECT NEW TEMP. FEEDER FROM TRANSFORMER TO TEMP. NEW SWGR MAIN #1.
  - \* [FPL] RE-ENERGIZE TRANSFORMER FEED TO SERVICE NEW SWGR MAIN #1
  - \* RUN PUMPS ERP-2 AND ERP-4 IN AUTO.
- NOTE: OLD SWGR IS COMPLETELY DE-ENERGIZED. PUMPS ERP-2 AND ERP-4 ARE RUNNING WITH A TEMPORARY POWER CONFIGURATION.  
 \* LIMITED EQUIPMENT OUTAGE PERIOD

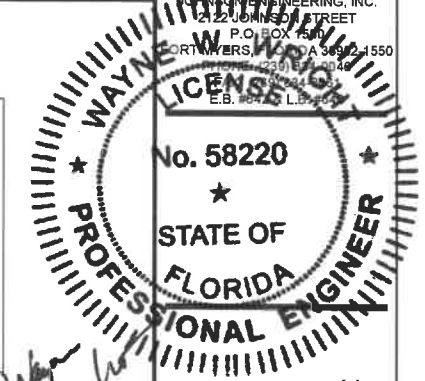
**SWITCHGEAR CONSTRUCTION STAGING PLAN - PHASE 2**



**PHASE 2 STAGING SEQUENCE**

- OBJECTIVE:** DEMO OLD SWGR.
- COMPLETELY DEMO OLD SWGR AND BATTERY CABINET
  - AS NEEDED, DEMO EXISTING BUS DUCT, AG CONDUIT, AND CONDUCTORS AND CONDUIT FROM THE OLD SWGR.
  - EXTEND EXISTING CONCRETE PAD AS SHOWN TO ACCOMMODATE NEW SWITCHGEAR.
- NOTE: OLD SWGR AND ELECTRICAL RACEWAYS ARE COMPLETELY DEMOED. PUMPS ERP-2 AND ERP-4 ARE RUNNING WITH A TEMPORARY POWER CONFIGURATION.

**JOHNSON ENGINEERING**  
 JOHNSON ENGINEERING, INC.  
 2122 US HIGHWAY 1 STREET  
 P.O. BOX 151  
 PORT WORTH, FLORIDA 33952-1550  
 E.B. #0001 L.E.#0001



CITY OF NAPLES WWTP  
 SWITCHGEAR REPLACEMENT  
 CONSTRUCTION PLANS  
 CITY OF NAPLES  
 NAPLES, FL

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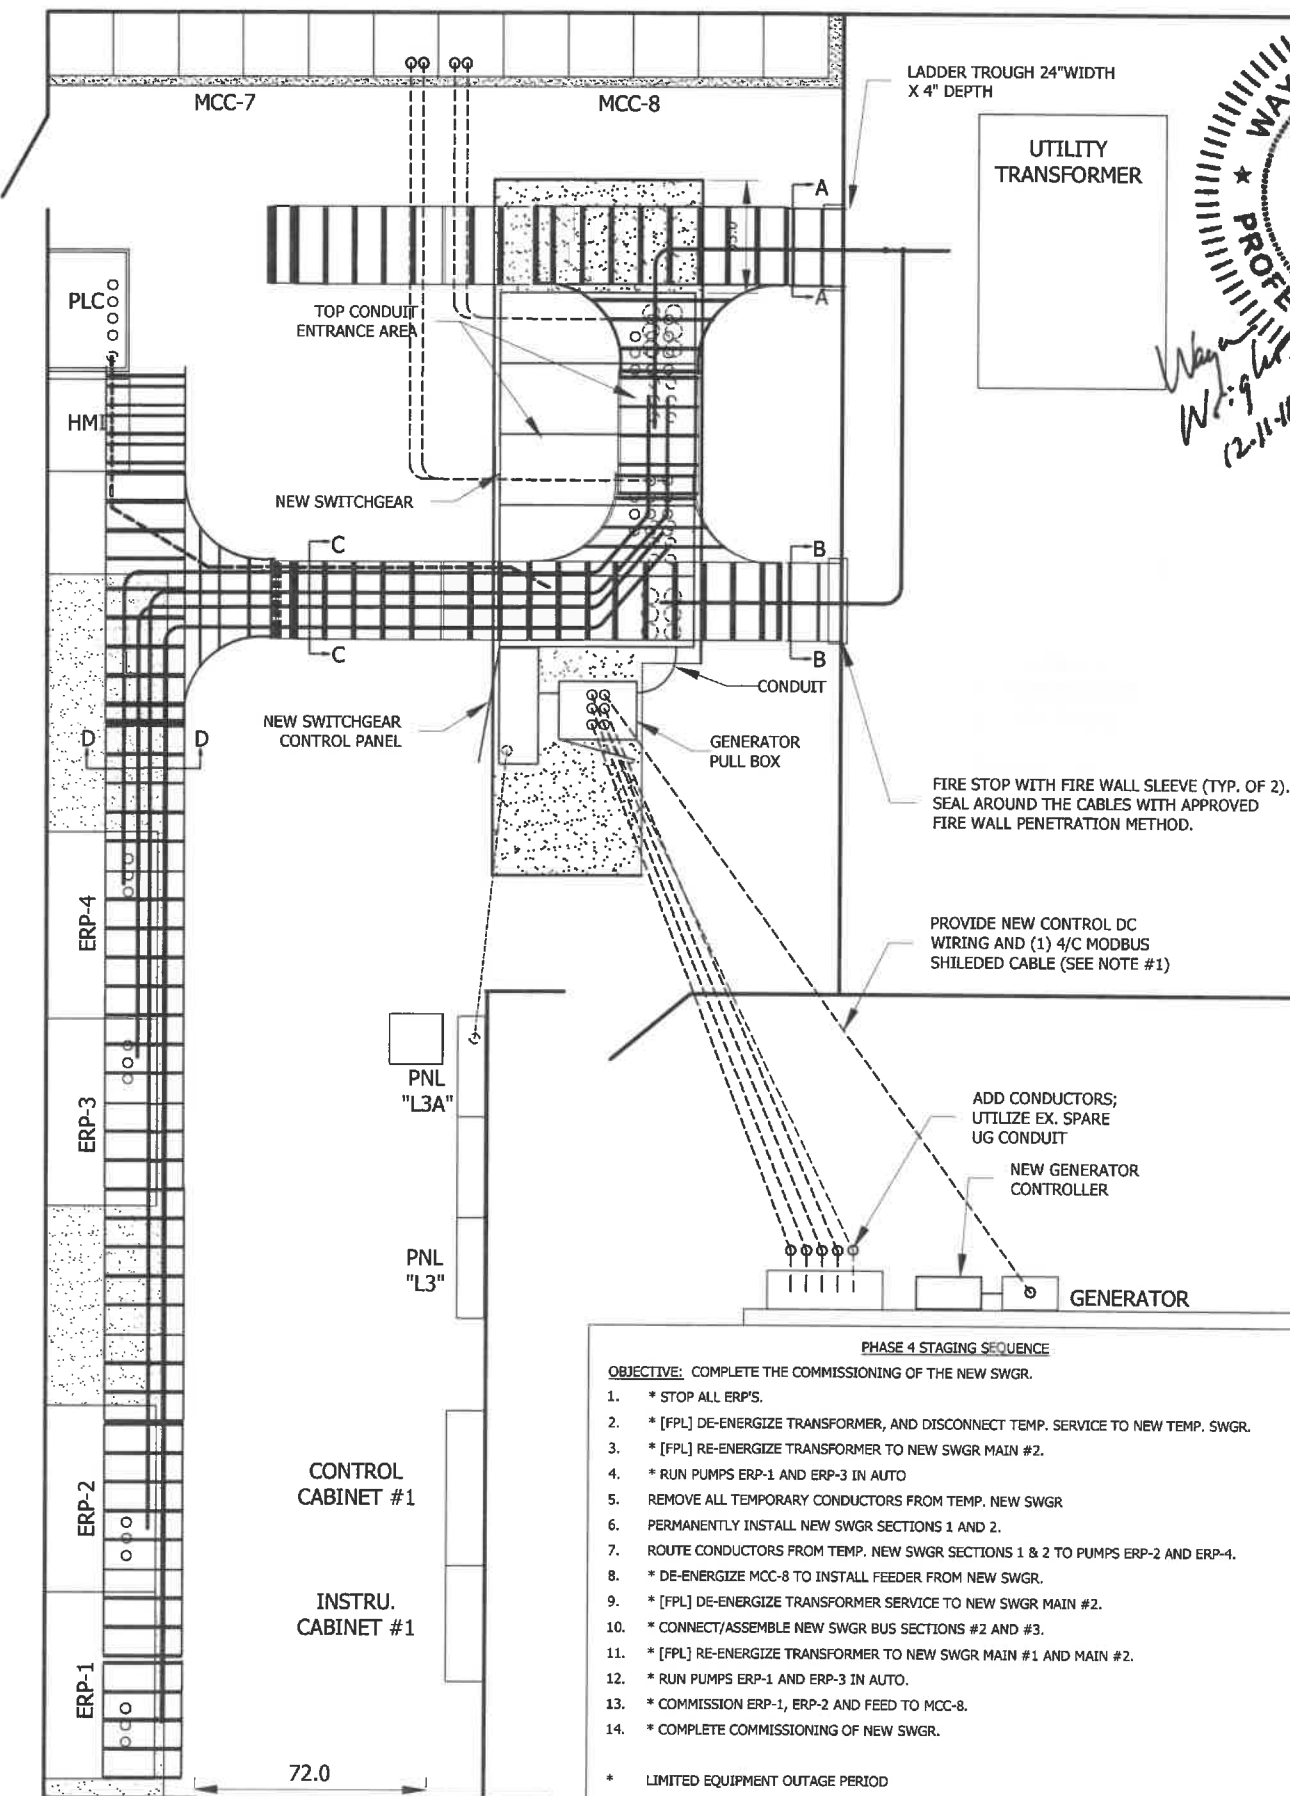
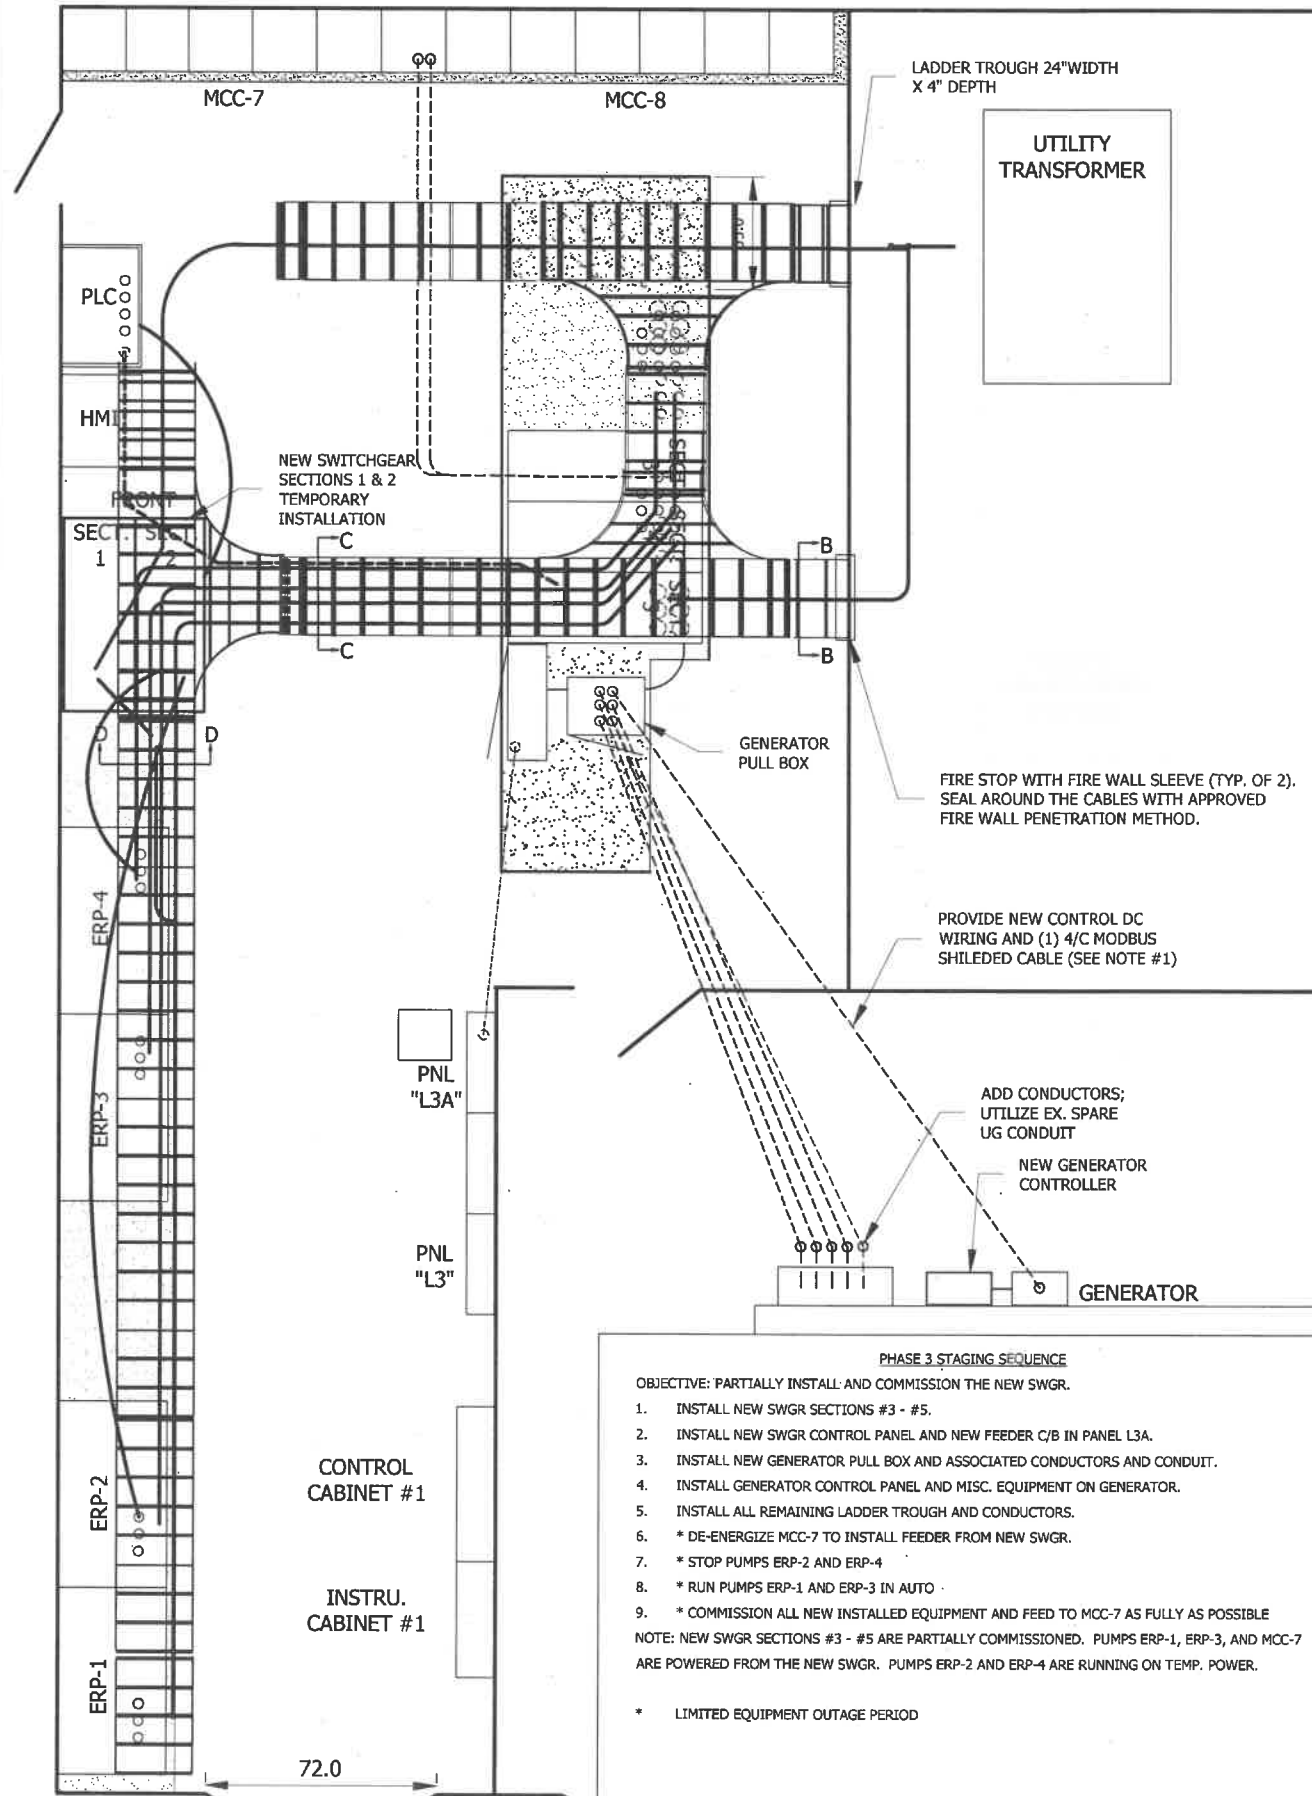
DATE: DEC. 2018  
 PROJECT NO. 20150110-007  
 FILE NO. 03-50-25  
 SCALE: #####

**SWGR-1  
 CONSTRUCTION  
 STAGING PLAN  
 PH 1-2**

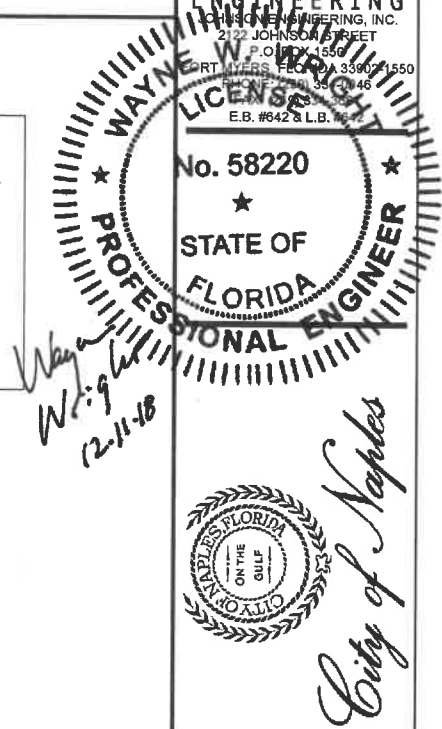
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SWITCHGEAR CONSTRUCTION STAGING PLAN - PHASE 3

SWITCHGEAR CONSTRUCTION STAGING PLAN - PHASE 4



**JOHNSON**  
ENGINEERING  
ELECTRICAL ENGINEERING, INC.  
2122 JOHNSON STREET  
PORT CHARLOTTE, FL 33901-1550  
P.O. #555  
E.B. #642 & L.B.



City of Naples

CITY OF NAPLES WWTP  
SWITCHGEAR REPLACEMENT  
CONSTRUCTION PLANS  
CITY OF NAPLES  
NAPLES, FL

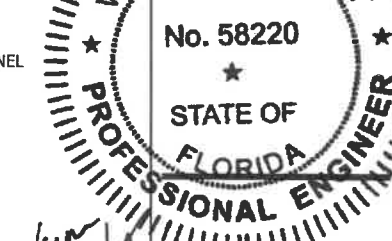
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PROJECT NO. 20150110-007  
FILE NO. 03-50-25  
SCALE: #####

SWGR-1  
CONSTRUCTION  
STAGING PLAN  
PH 3-4

SHEET NUMBER  
E16





*Wayne Wright*  
12-11-18  
*City of Naples*

CITY OF NAPLES WWTP  
SWITCHGEAR REPLACEMENT  
CONSTRUCTION PLANS  
CITY OF NAPLES  
NAPLES, FL

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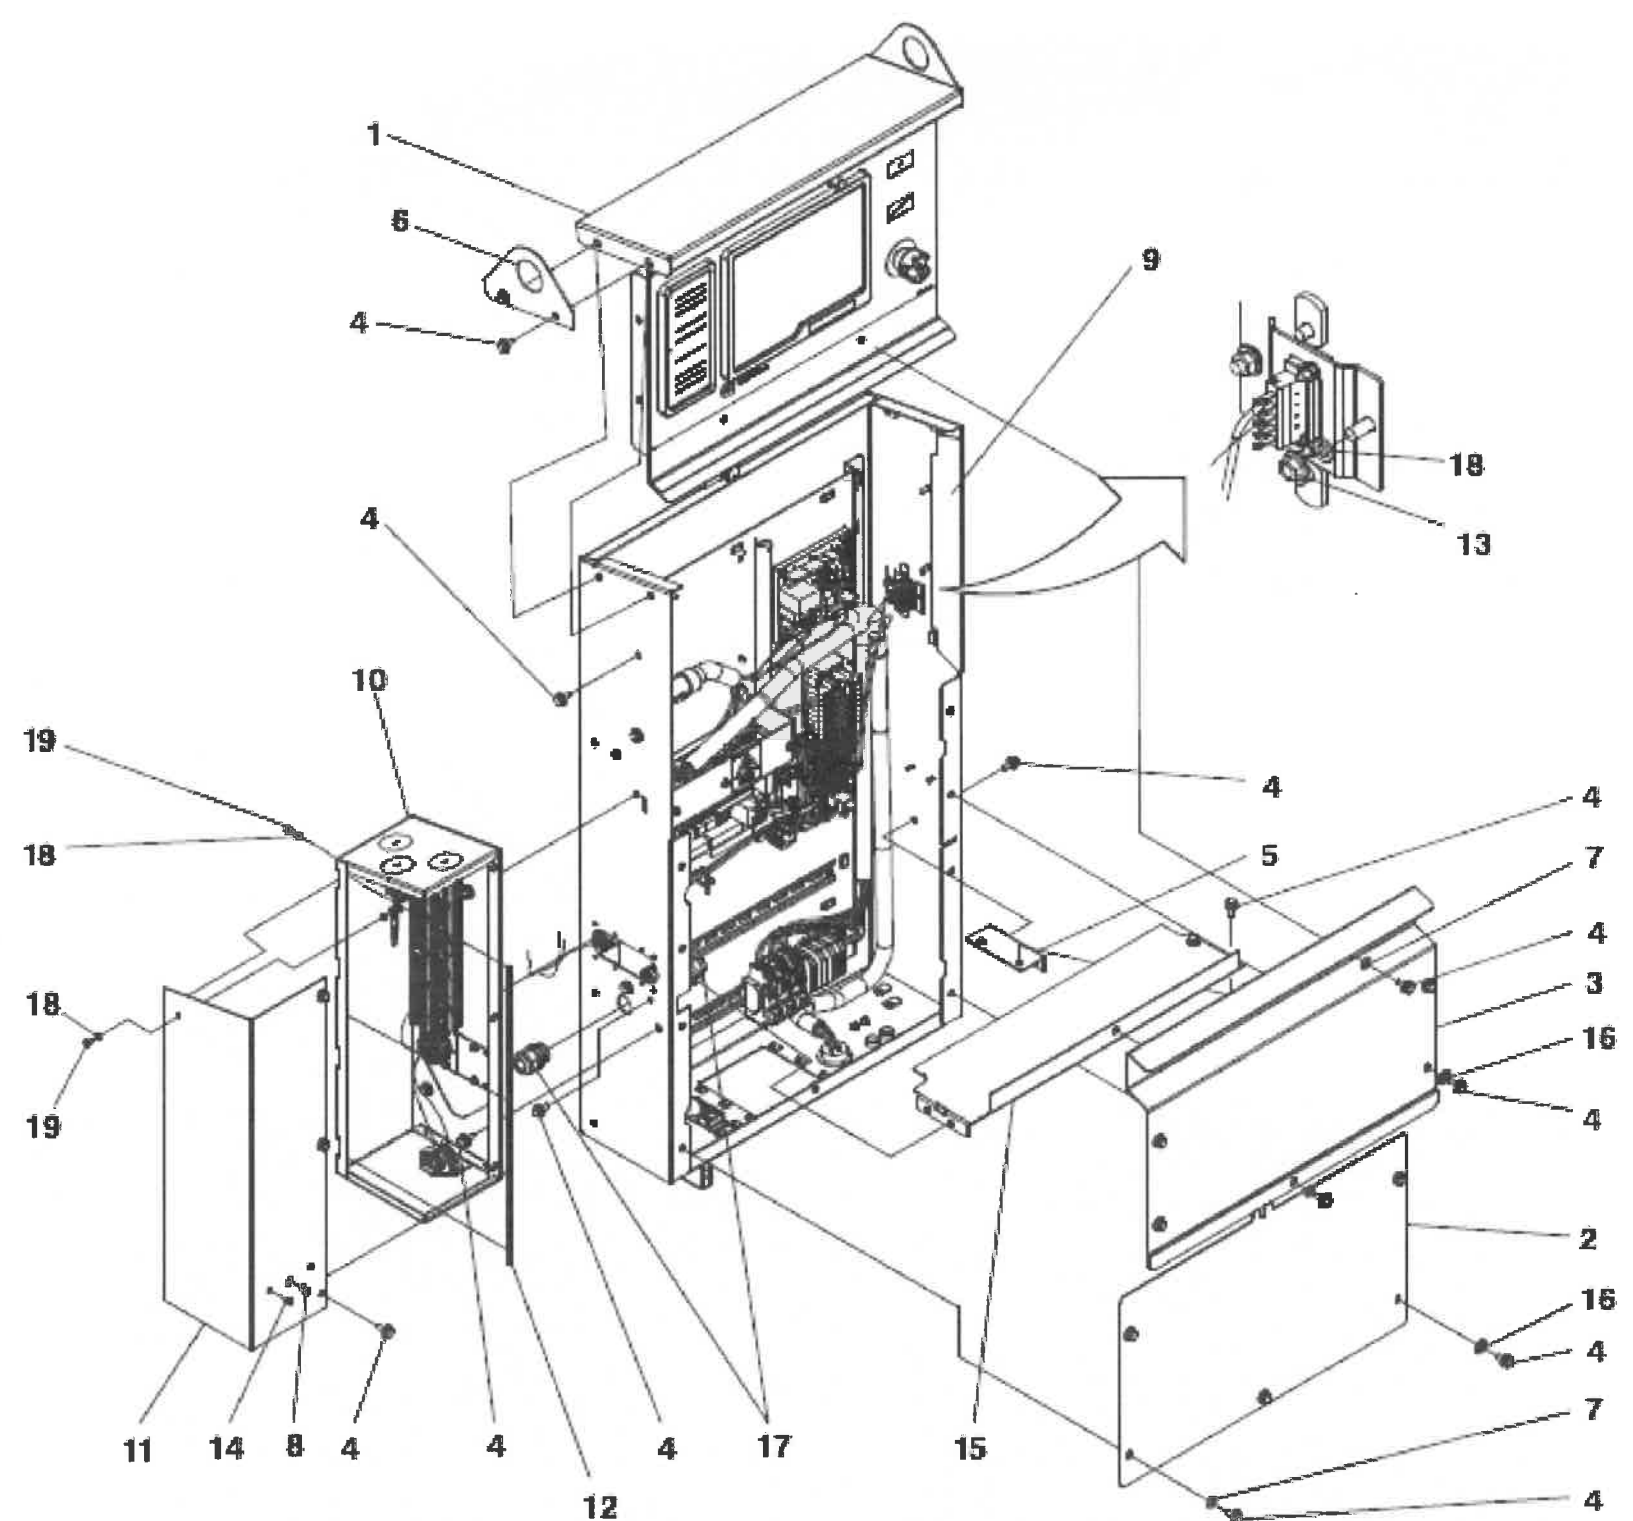
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FILE NO. 03-50-25  
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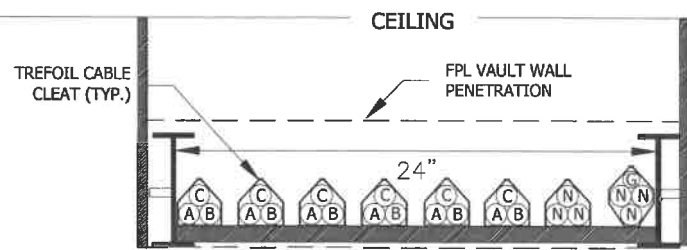
**GEN-1 GENERATOR  
#1 CONTROL PANEL**

SHEET NUMBER  
**E17**

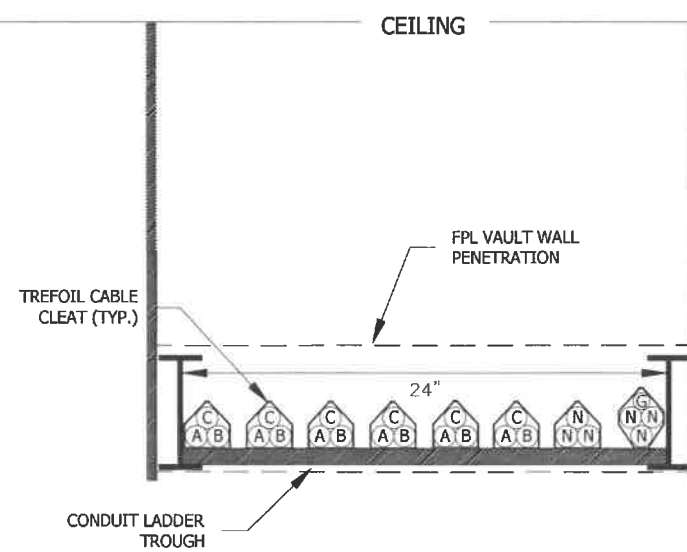
**NOTES: #**

1. PROVIDE GENERATOR CONTROLLER CUMMINS PCC3300 CONTROL ASSEMBLY KIT. EXISTING GENSET BATTERY OPERATION IS 24 VDC.
2. PROVIDE CUMMINS MODEL 0541-1291 AUX101 BASE AND MODEL 0541-0772 AUX102 EXPANSION I/O MODULES.
3. GENSET CONTROLLER HARD-WIRED INPUTS FROM SWITCHGEAR CONTROL PANEL (AUX101):
  - REMOTE EMERGENCY STOP
  - REMOTE START/STOP
5. GENSET CONTROLLER HARD-WIRED OUTPUTS TO SWITCHGEAR CONTROL PANEL (AUX101):
  - GENSET RUNNING
  - NOT IN AUTO
  - READY TO LOAD
  - COMMON WARNING
  - COMMON ALARM
  - COMMON SHUTDOWN
6. CONTRACTOR IS RESPONSIBLE FOR CUMMINS TECH SUPPORT, RELATED INSTRUMENTATION, INSTALLATION AND SUPPLIER COMMISSIONING.
7. GENSET MODBUS RS485 TO BE CONNECTED TO SWITCHGEAR CONTROL PANEL FOR MISC. SIGNALS.

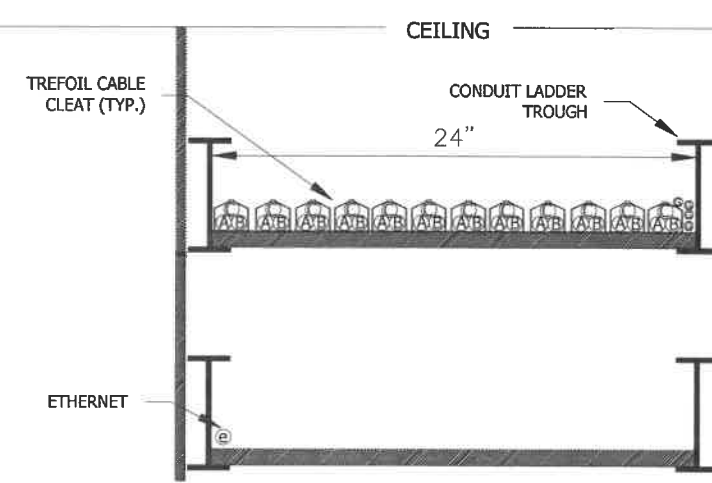




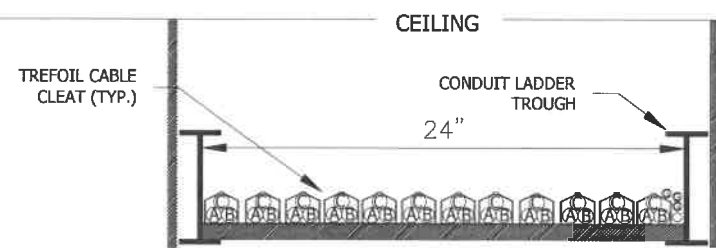
UPPER LADDER RACEWAY TROUGH  
CABLE INSTALLATION ARRANGEMENT  
SECTION A-A  
NTS



LOWER LADDER RACEWAY TROUGH  
CABLE INSTALLATION ARRANGEMENT  
SECTION B-B  
NTS



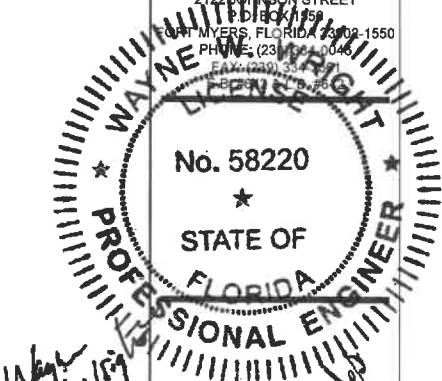
UPPER LADDER RACEWAY TROUGH  
CABLE INSTALLATION ARRANGEMENT  
SECTION C-C  
NTS



UPPER LADDER RACEWAY TROUGH  
CABLE INSTALLATION ARRANGEMENT  
SECTION D-D  
NTS

- NOTES:  
 1. LADDER TROUGH:  
 INSIDE WIDTH: 24"  
 MATERIAL: ALUMINUM  
 RUNG SPACING: 9"  
 TROUGH TYPE: LADDER  
 LOADING DEPTH: 4"  
 SIDE RAIL HEIGHT: 5"  
 WORKING LOAD: 75 LBS/FT. MIN.  
 MFR: EATON B-LINE SERIES 25

**JOHNSON ENGINEERING**  
 JOHNSON ENGINEERING, INC.  
 2122 JOHNSON STREET  
 NAPLES, FLORIDA 34109-1550  
 PHONE (239) 435-0045



*Wayne Wright*  
 12-11-18



*City of Naples*

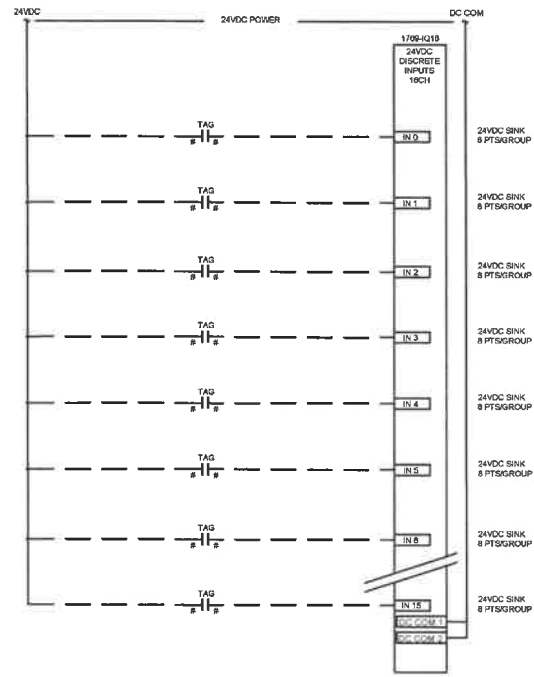
CITY OF NAPLES WWTP  
 SWITCHGEAR REPLACEMENT  
 CONSTRUCTION PLANS  
 CITY OF NAPLES  
 NAPLES, FL

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DATE: DEC. 2018  
 PROJECT NO. 20150110-007  
 FILE NO. 03-50-25  
 SCALE: NONE

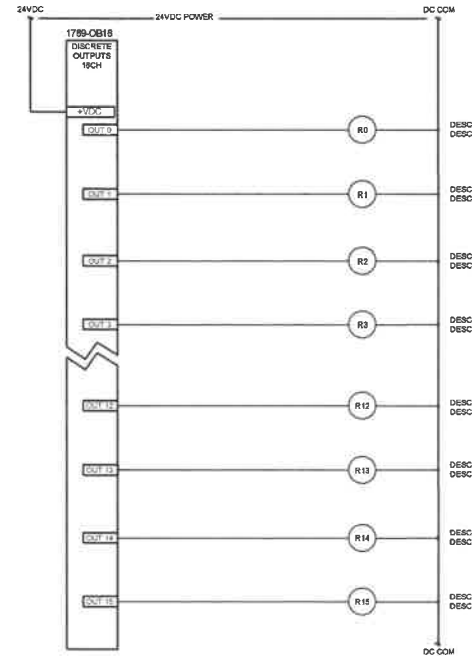
**ELECTRICAL  
 DETAILS**

SHEET NUMBER  
**ED01**

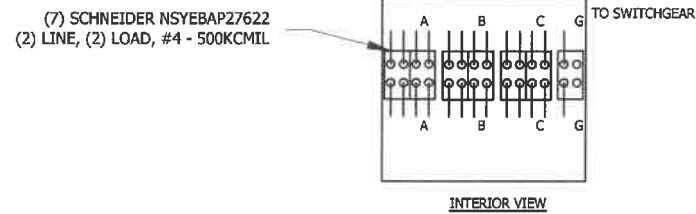
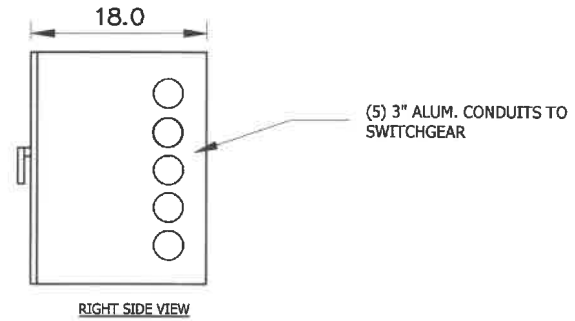
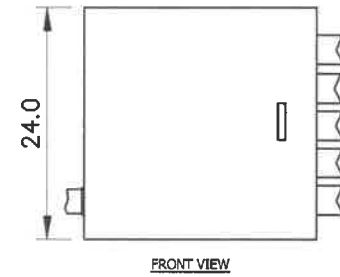
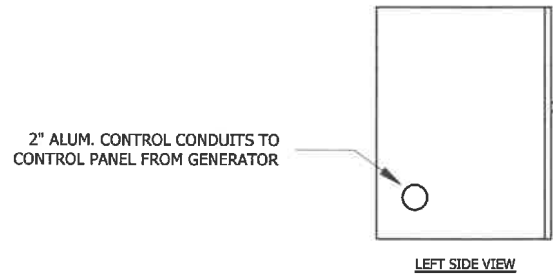
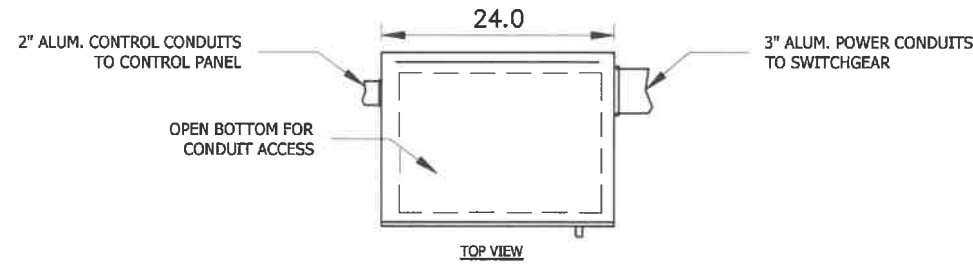


**NOTES:**  
 1. SURGE ARRESTORS INSTALLED ON ALL EXTERNAL CIRCUITS.  
 PHOENIX PT 2X1-24DC-ST 2-PT PLUG P/N 2856387 WITH P/N 2856138 BASE  
 PHOENIX PT 4X1-24DC-ST 4-PT PLUG P/N 2858322 WITH P/N 2839383 BASE  
 2. ALL EXTERNAL SIGNALS PROTECTED BY MINIATURE CIRCUIT BREAKERS, UNLESS NOTED.

**16-CH 24VDC DISCRETE INPUT MODULE (TYP.)**  
 1769-IQ16



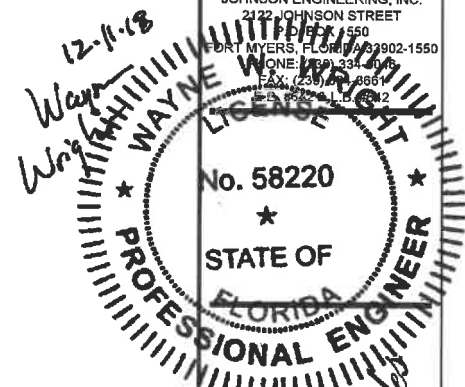
**16-CH DISCRETE OUTPUT MODULE (TYP.)**  
 1769-OB16



**NOTES:**  
 1. GENERATOR PULL BOX DIMENSIONS APPROX. 18" D X 24" W X 22" H.

**GENERATOR PULL BOX**  
 NTS

**JOHNSON ENGINEERING**  
 JOHNSON ENGINEERING, INC.  
 2122 JOHNSON STREET  
 SUITE 100  
 ORLANDO, FLORIDA 32802-1550  
 PHONE: (407) 331-1550  
 FAX: (407) 331-8862



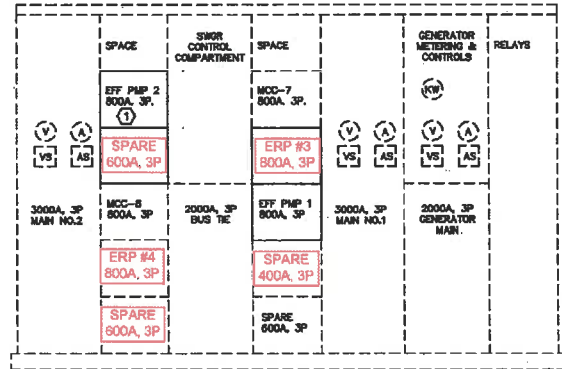
CITY OF NAPLES WWTP  
 SWITCHGEAR REPLACEMENT  
 CONSTRUCTION PLANS  
 CITY OF NAPLES  
 NAPLES, FL

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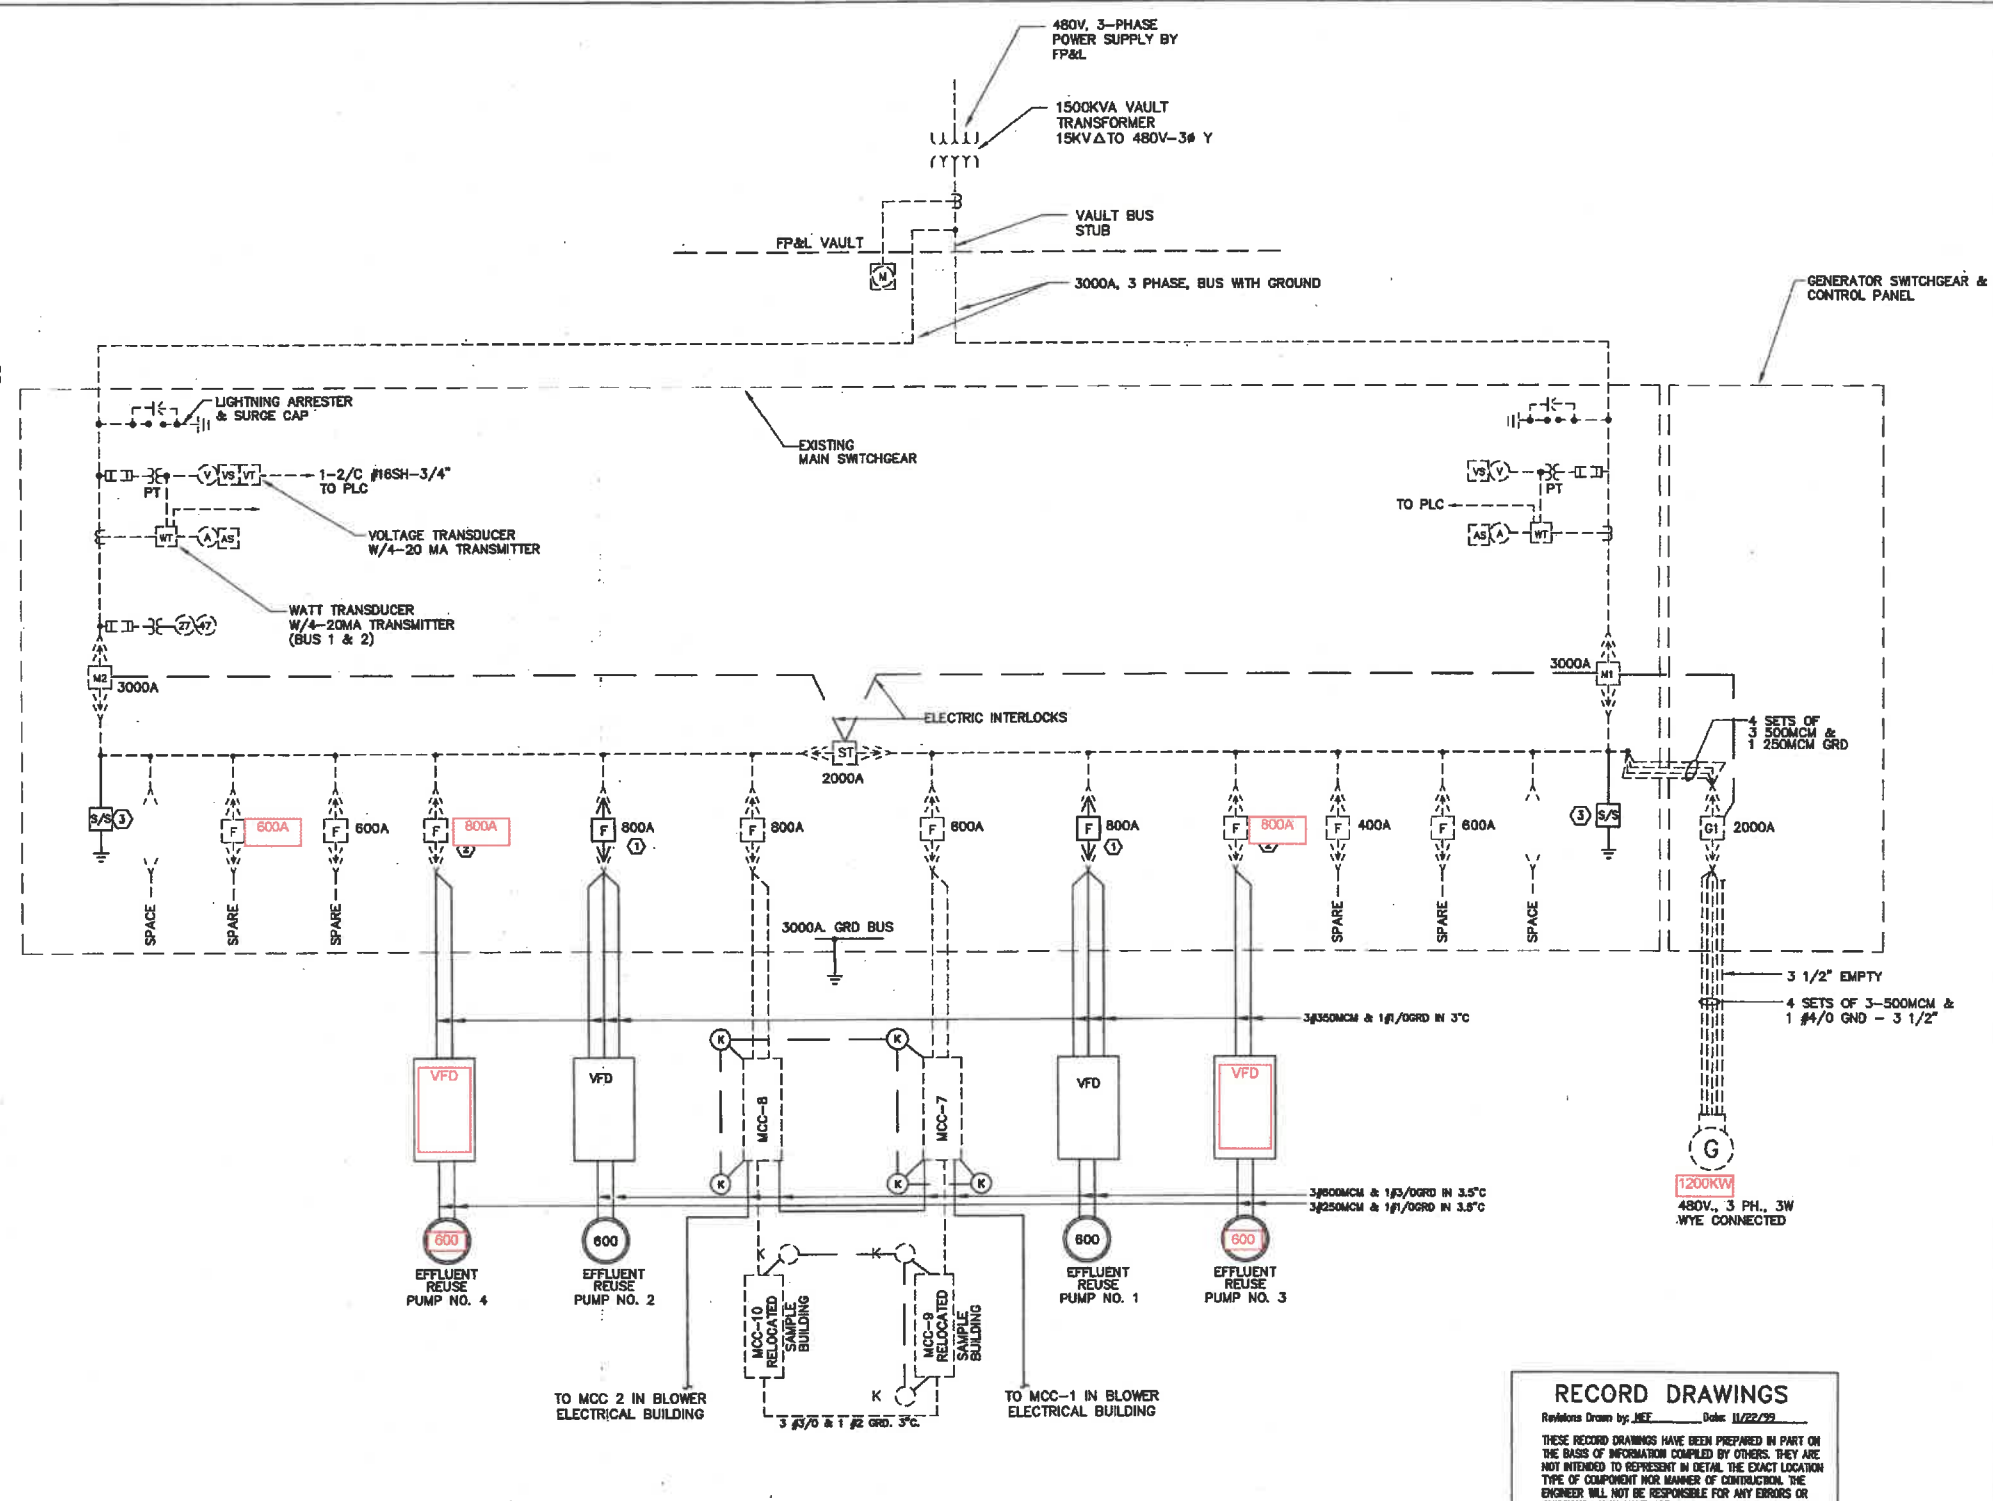
DATE: DEC. 2018  
 PROJECT NO. 20150110-007  
 FILE NO. 03-50-25  
 SCALE: NONE

**ELECTRICAL  
 DETAILS**

SHEET NUMBER  
**ED02**



- KEYNOTES**
- 1.) MODIFY FOR 300A TRIP UNIT. MODIFY BUS CONNECTION FOR ADDITIONAL CABLES. PROVIDE NEW TRIP UNIT FOR 100X RATING.
  - 2.) PROPOSED HIGH ENERGY SURGE SUPPRESSION DEVICE INTERNALLY FUSED, MOUNTED TO REAR OF EXISTING CABINET PER MANUFACTURER INSTRUCTIONS, G.E. TYPE 8L0F SERIES RATED 100KA; NO EQUAL.



**RECORD DRAWINGS**  
 Revisions Drawn by: JEF Date: 11/22/99  
 THESE RECORD DRAWINGS HAVE BEEN PREPARED IN PART ON THE BASIS OF INFORMATION COMPILED BY OTHERS. THEY ARE NOT INTENDED TO REPRESENT IN DETAIL THE EXACT LOCATION TYPE OF COMPONENT NOR MANNER OF CONSTRUCTION. THE ENGINEER WILL NOT BE RESPONSIBLE FOR ANY ERRORS OR OMISSIONS WHICH HAVE NOT BEEN INCORPORATED INTO THE RECORD DRAWINGS.

L:\MAP\WWTP\44801e5.dwg 11/22/99 14:45 MEF PLOT SCALE: 1=48

JOB NO. 494-480  
 CAD FILE: 44801E5  
 SCALES: NONE  
 DATE: AUG 1995

**TLC Tilden Lobnitz Cooper CONSULTING ENGINEERS INC.**  
 1500 Royal Palm Square Blvd., Ste. 102  
 Ft. Myers, Florida 33919 (813) 276-4240  
 • Orlando • Ft. Myers • Tallahassee • Cleveland • Cocoa •

| NO. | DATE | ISSUED FOR | BY |
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|     |      |            |    |

DCN WILLIAMS, P.E.  
 Florida Reg. No. 29504

**HMA HOLE, MONTES & ASSOCIATES, INC.**  
 ENGINEERS - PLANNERS - SURVEYORS

|          |       |         |            |
|----------|-------|---------|------------|
| DESIGNER | DRAWN | CHECKED | PROJ. ENG. |
|          |       |         |            |

CITY OF NAPLES WWTRF EXPANSION & UPGRADE

**PROPOSED MODIFICATIONS TO EXISTING ELECTRICAL SERVICE SINGLE LINE DIAGRAM**

PROJECT NO. 94.30  
 DATE: 08/95  
 SHEET: 1E5

**JOHNSON ENGINEERING**  
 JOHNSON ENGINEERING, INC.  
 2122 JOHNSON STREET  
 NAPLES, FL 34109-1550  
 PHONE: (813) 354-3600  
 FAX: (813) 354-3600

12-16-18  
 WAYNE WRIGHT  
 LICENSE  
 No. 58220  
 STATE OF FLORIDA  
 PROFESSIONAL ENGINEER  
 City of Naples

CITY OF NAPLES WWTP  
 SWITCHGEAR REPLACEMENT  
 CONSTRUCTION PLANS  
 CITY OF NAPLES  
 NAPLES, FL

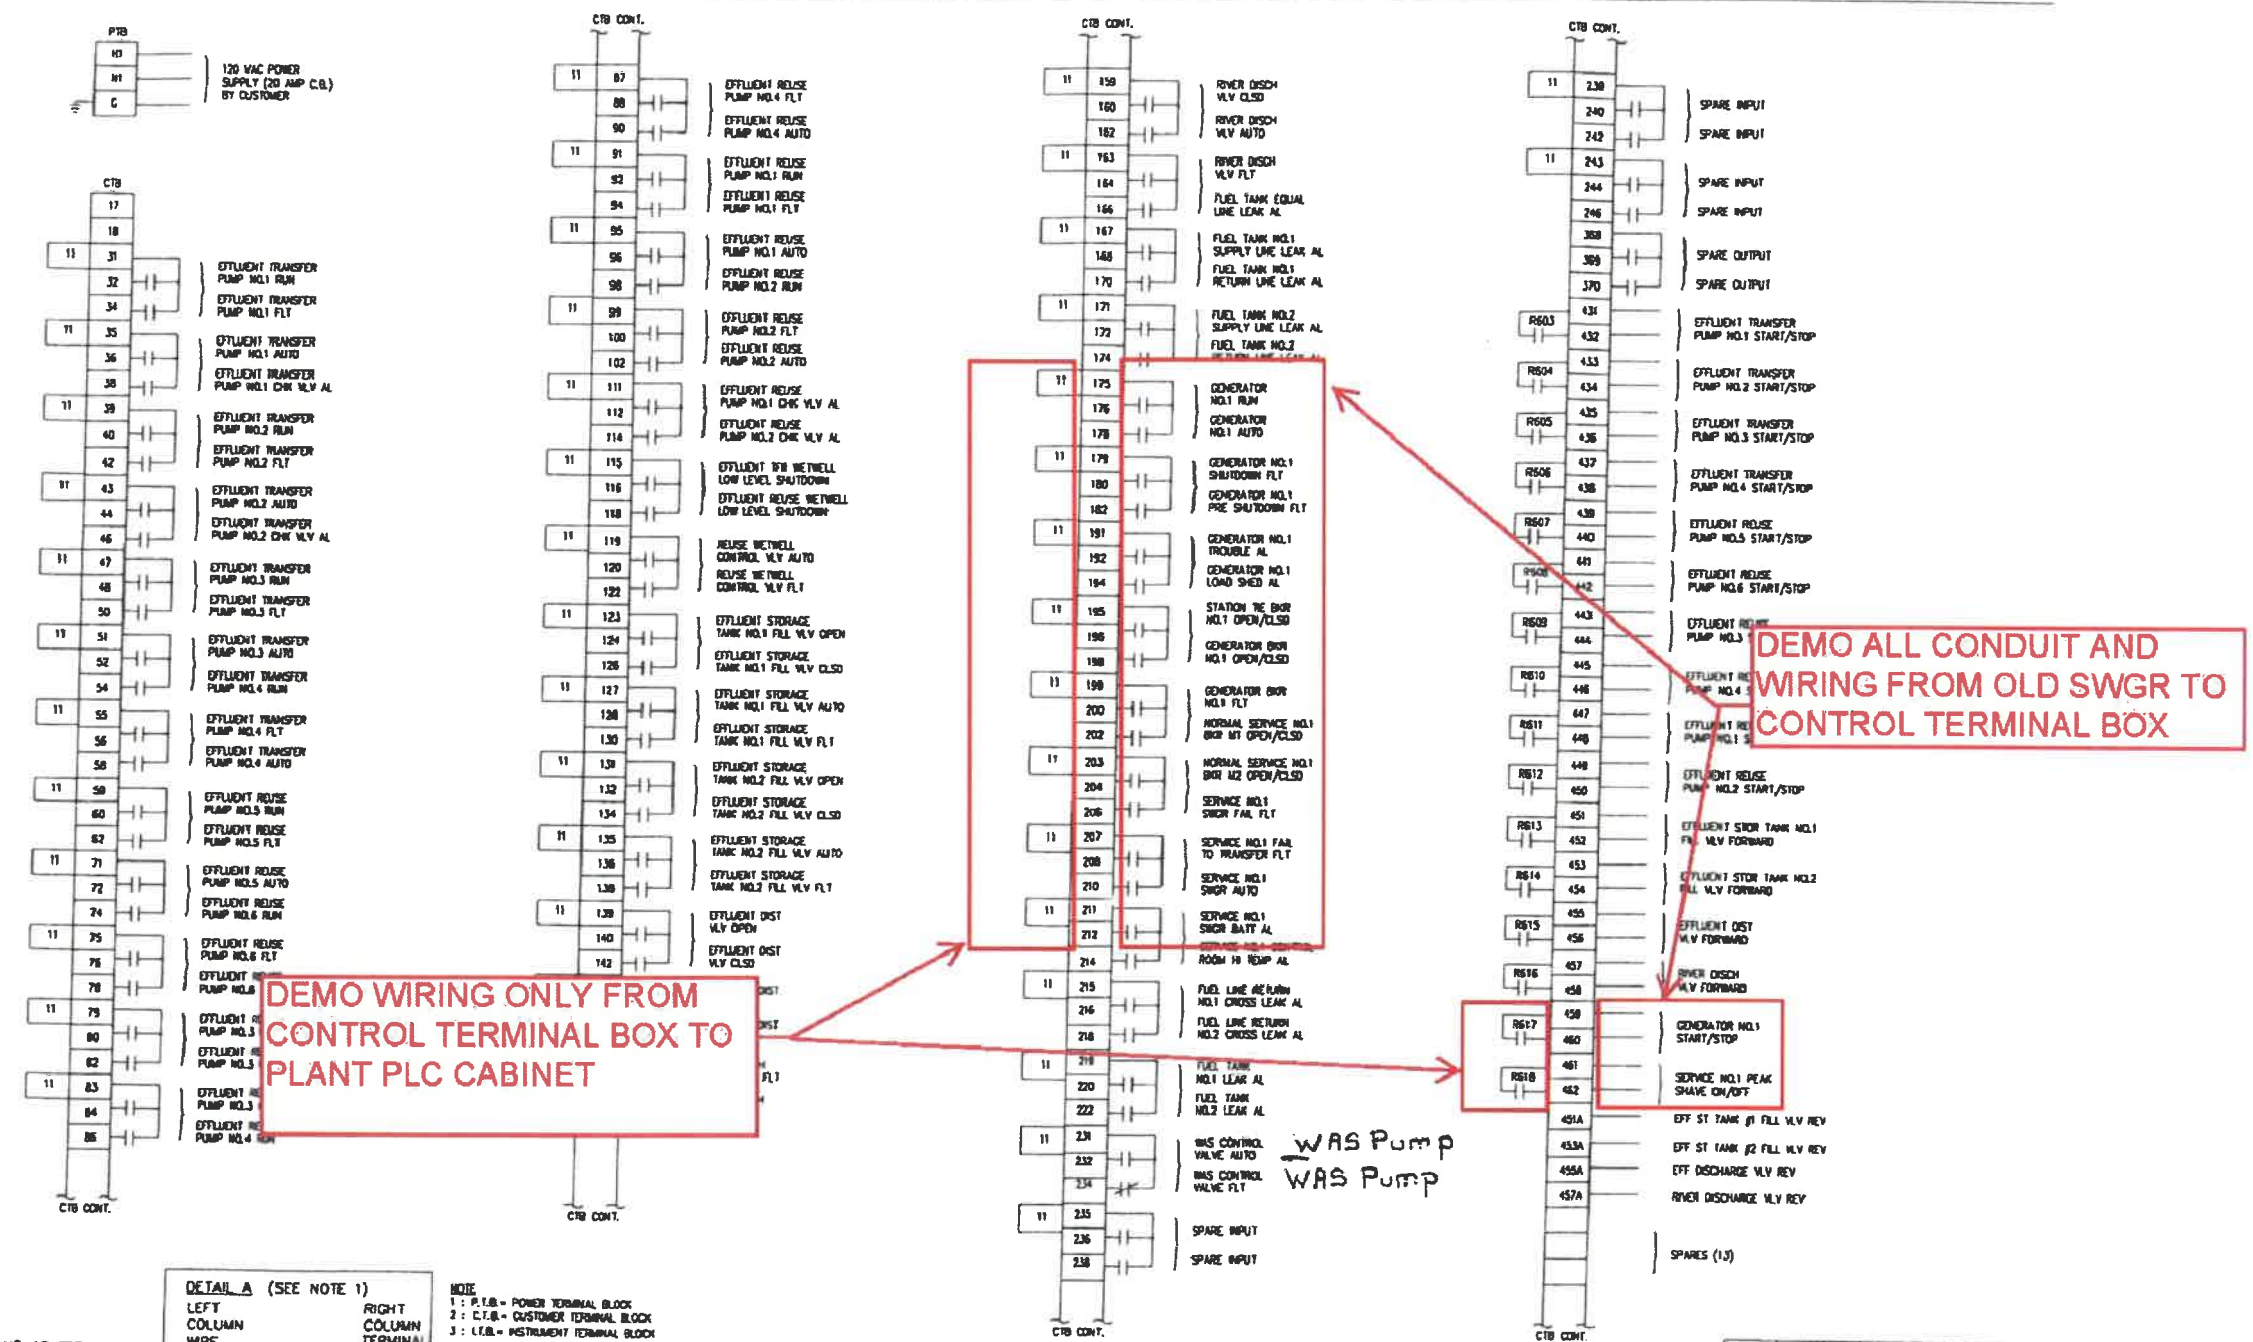
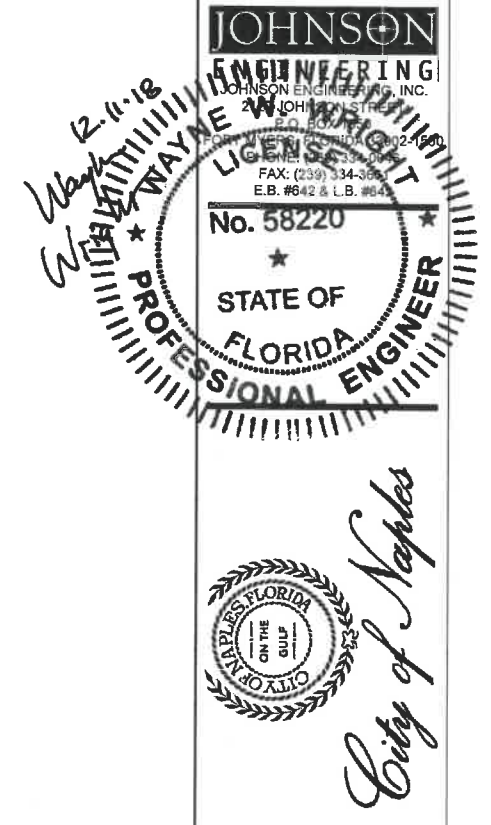
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DATE: DEC. 2018  
 PROJECT NO. 20150110-007  
 FILE NO. 03-50-25  
 SCALE: AS SHOWN

(REF) EX.  
 SWITCHGEAR  
 SINGLE LINE  
 DIAGRAM

SHEET NUMBER  
 ER01



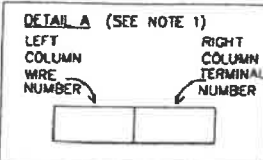


DEMO WIRING ONLY FROM CONTROL TERMINAL BOX TO PLANT PLC CABINET

DEMO ALL CONDUIT AND WIRING FROM OLD SWGR TO CONTROL TERMINAL BOX

WAS Pump WAS Pump

NOTE  
1 : WIRE NO. IS SAME AS TERMINAL NO. UNLESS INDICATED OTHERWISE.



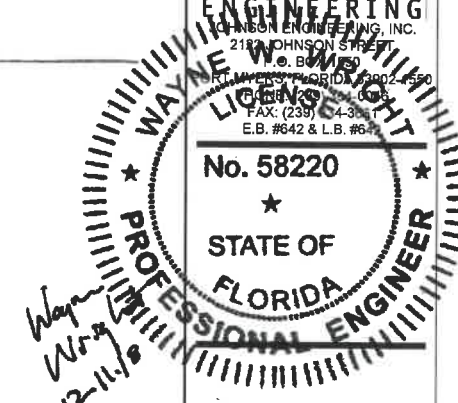
NOTE  
1 : P.T.B. = POWER TERMINAL BLOCK  
2 : C.T.B. = CUSTOMER TERMINAL BLOCK  
3 : I.T.B. = INSTRUMENT TERMINAL BLOCK

| REV | DESCRIPTION       | BY | DATE     | APPROVED | DATE     |
|-----|-------------------|----|----------|----------|----------|
| 3   | ISS BUILT UPDATE  | CH | 10/23/98 | ANNVIC   | 3800 NEW |
| 2   | NO CHANGES        | CH | 11/11/97 | ANNVIC   |          |
| 1   | PER BILL COMMENTS | CH | 11/12/96 | ANNVIC   |          |

NOTES:  
1. THIS DRAWING IS PROVIDED FOR REFERENCE ONLY.

| NO. | DATE | DESCRIPTION |
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(REF) EX. CONTROL CABINET JB



*City of Naples*

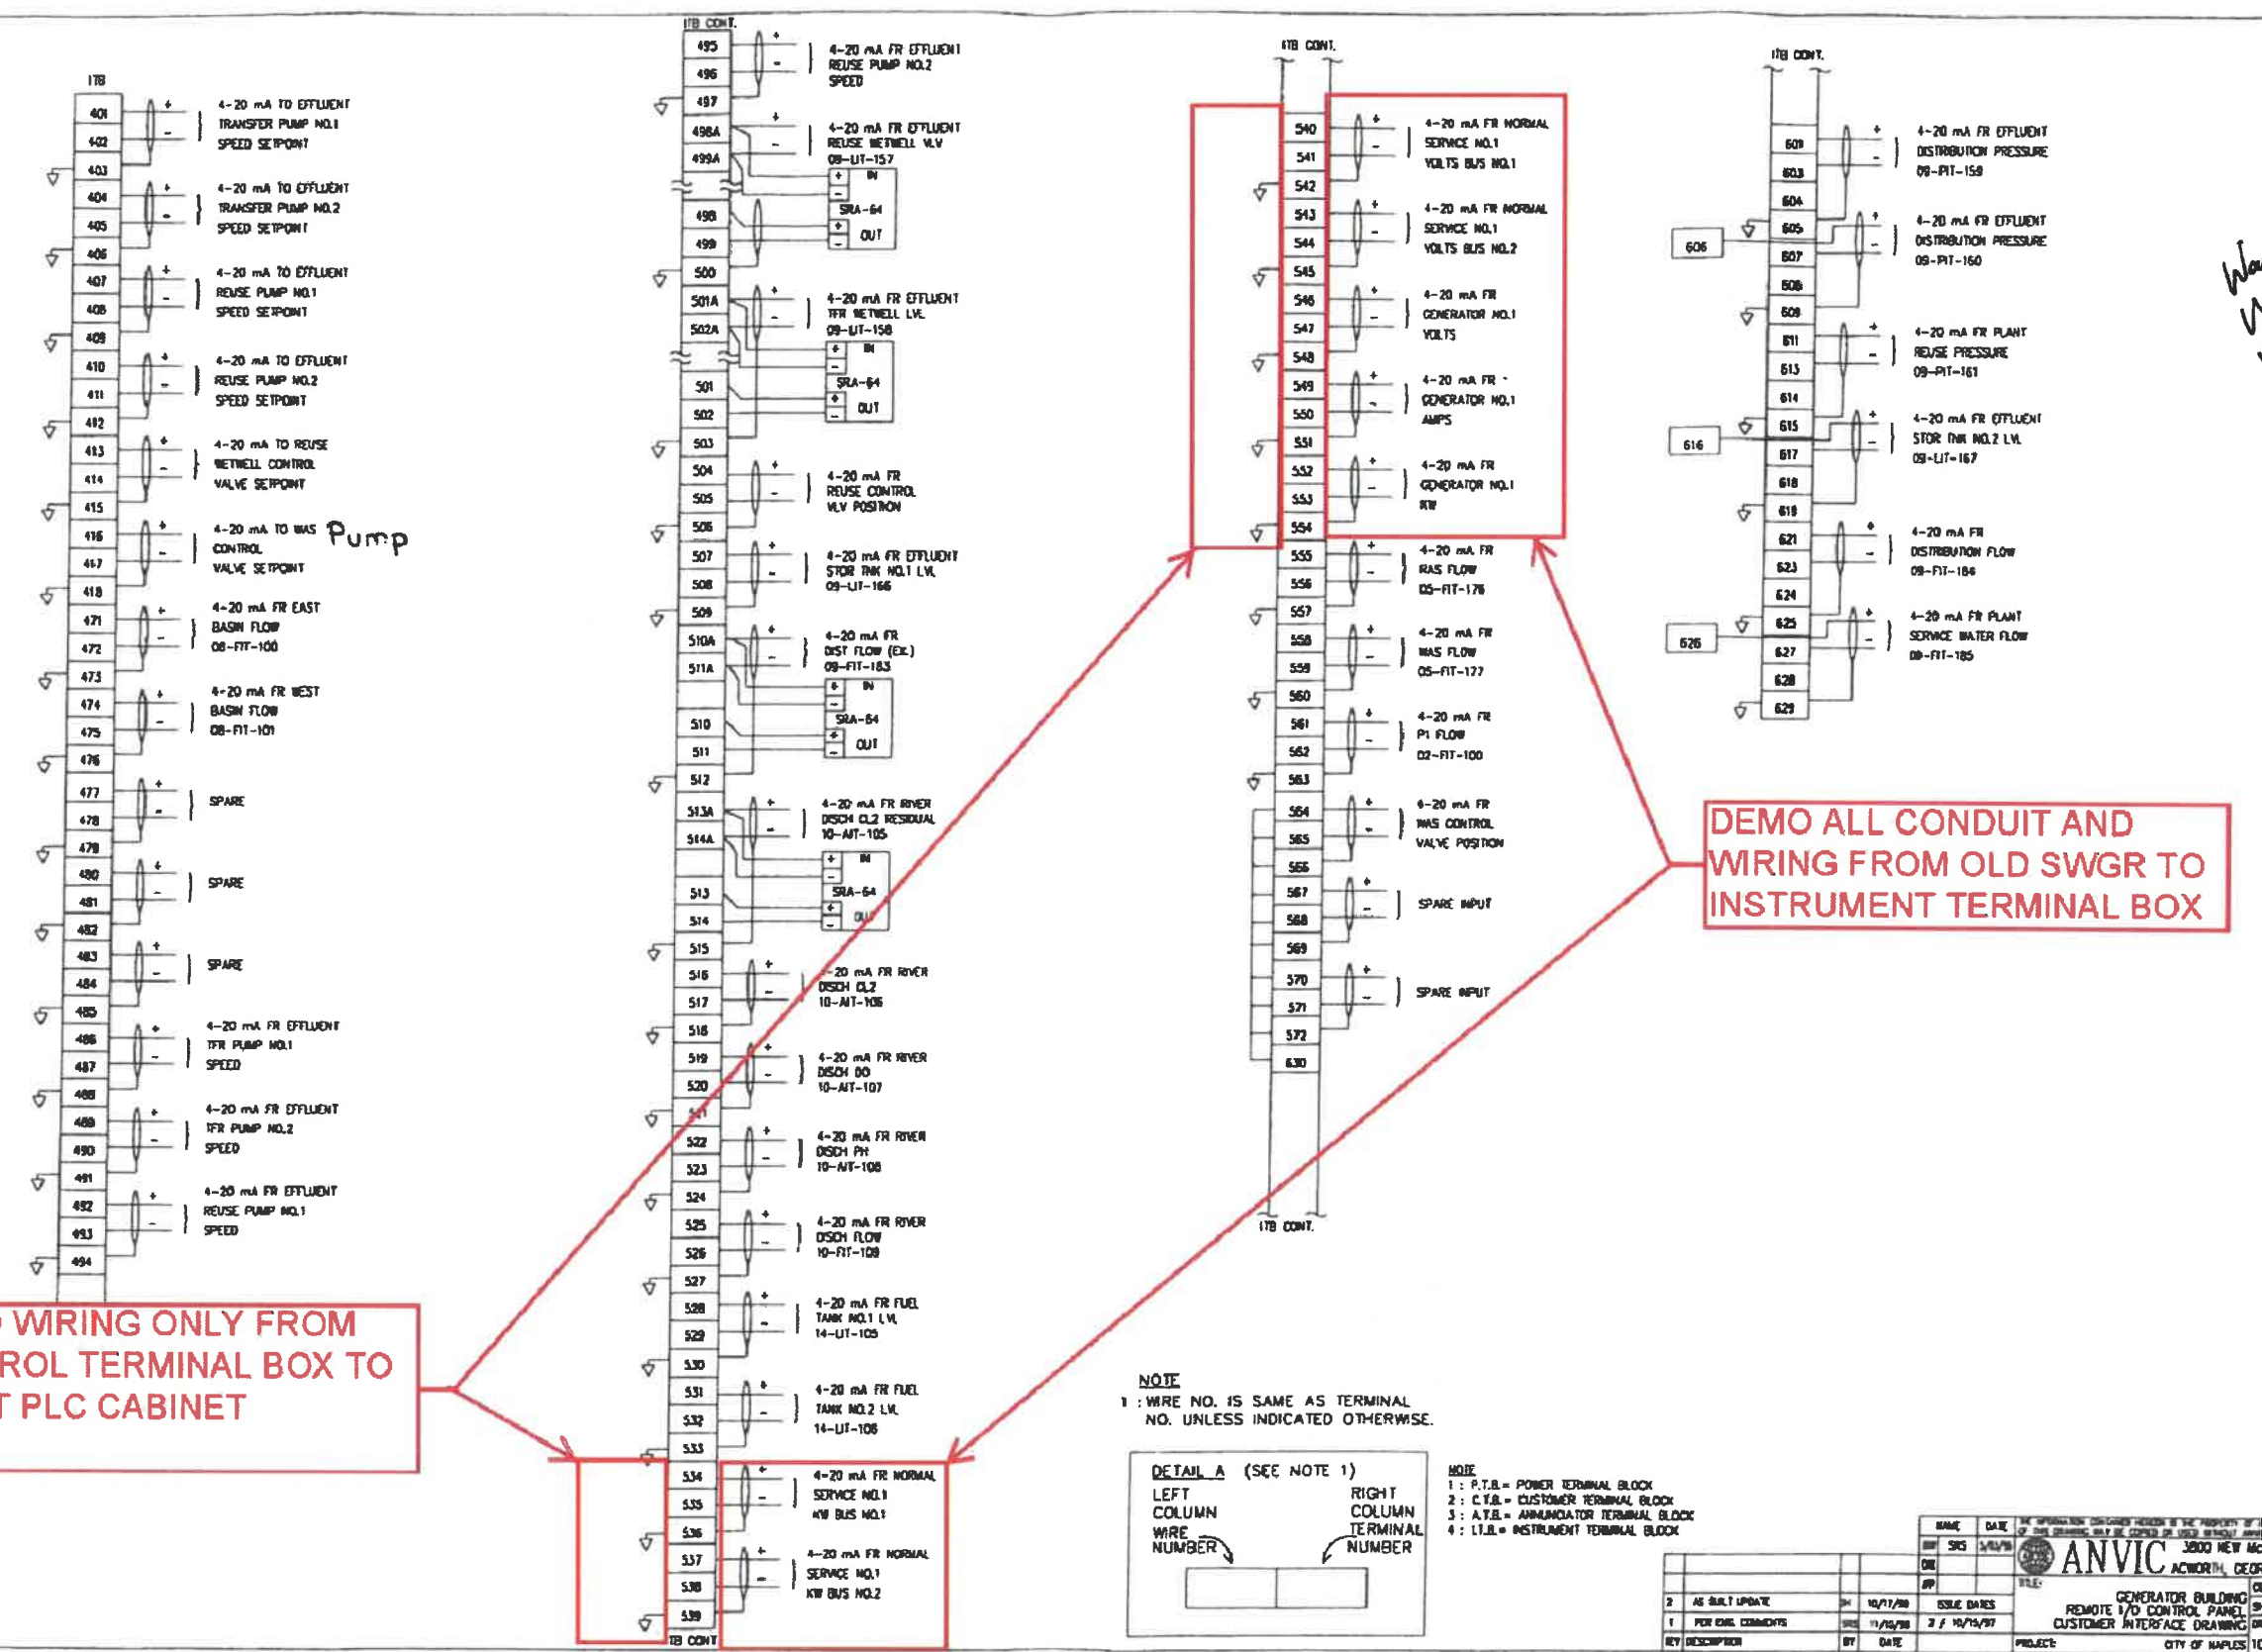
CITY OF NAPLES WWTP  
 SWITCHGEAR REPLACEMENT  
 CONSTRUCTION PLANS  
 CITY OF NAPLES  
 NAPLES, FL

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 PROJECT NO. 20150110-007  
 FILE NO. 03-50-25  
 SCALE: AS SHOWN

(REF) EX. INSTRU.  
 CABINET JB

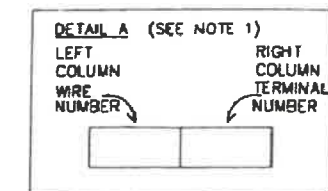
SHEET NUMBER  
**ER03**



**DEMO WIRING ONLY FROM CONTROL TERMINAL BOX TO PLANT PLC CABINET**

**DEMO ALL CONDUIT AND WIRING FROM OLD SWGR TO INSTRUMENT TERMINAL BOX**

**NOTE**  
 1: WIRE NO. IS SAME AS TERMINAL NO. UNLESS INDICATED OTHERWISE.



**NOTE**  
 1: P.T.B. = POWER TERMINAL BLOCK  
 2: C.T.B. = CUSTOMER TERMINAL BLOCK  
 3: A.T.B. = ANNUNCIATOR TERMINAL BLOCK  
 4: I.T.B. = INSTRUMENT TERMINAL BLOCK

| REV | DESCRIPTION       | BY | DATE     | ISSUE DATES  |
|-----|-------------------|----|----------|--------------|
| 2   | AS BUILT UPDATE   | SH | 10/17/20 | 10/17/20     |
| 1   | FOR CHG. COMMENTS | SH | 11/20/20 | 2 / 10/19/21 |

**ANVIC** 3000 NEW McENER ACWORTH, GEORGIA  
 GENERATOR BUILDING  
 REMOTE I/O CONTROL PANEL  
 CUSTOMER INTERFACE DRAWING  
 PROJECT: CITY OF NAPLES 1099-3





ERP-1,2 VFD'S AND ERP-3,4 VFD'S  
ELECTRICAL ROOM #1



FPL VAULT  
ELECTRICAL ROOM #1

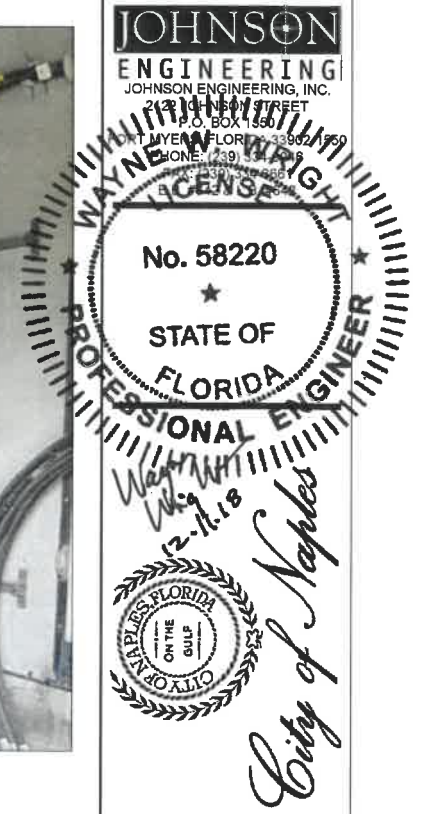


EX. SWITCHGEAR (FRONT VIEW)  
ELECTRICAL ROOM #1



EX. SWITCHGEAR (TOP VIEW)  
ELECTRICAL ROOM #1

**JOHNSON**  
ENGINEERING  
JOHNSON ENGINEERING, INC.  
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CITY OF NAPLES WWTP  
SWITCHGEAR REPLACEMENT  
CONSTRUCTION PLANS  
CITY OF NAPLES  
NAPLES, FL

| NO. | REVISIONS DESCRIPTION | DATE |
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DATE: DEC. 2018  
PROJECT NO. 20150110-007  
FILE NO. 03-50-25  
SCALE: AS SHOWN

(REF) PHOTOS

SHEET NUMBER  
**ER04**





ENTRANCE AND EQUIPMENT ACCESS  
ELECTRICAL ROOM #1



EX. SWITCHGEAR OVERHEAD CONDUIT AND BUS DUCT  
ELECTRICAL ROOM #1

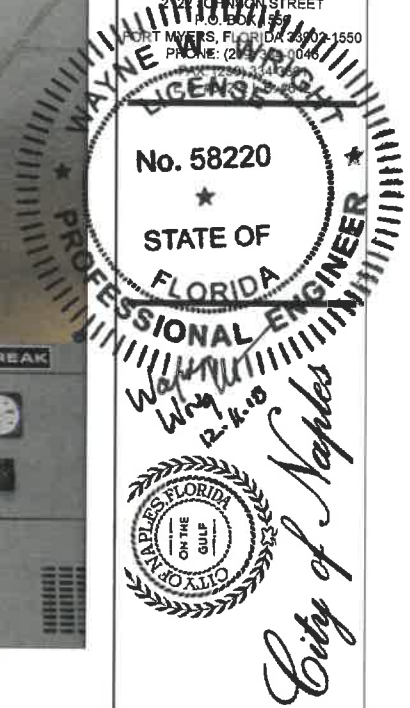


EX. GENERATOR #1  
ELECTRICAL ROOM #1



EX. SWITCHGEAR BUS DUCT TO FPL VAULT  
ELECTRICAL ROOM #1

**JOHNSON**  
ENGINEERING  
JOHNSON ENGINEERING, INC.  
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CITY OF NAPLES WWTP  
SWITCHGEAR REPLACEMENT  
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