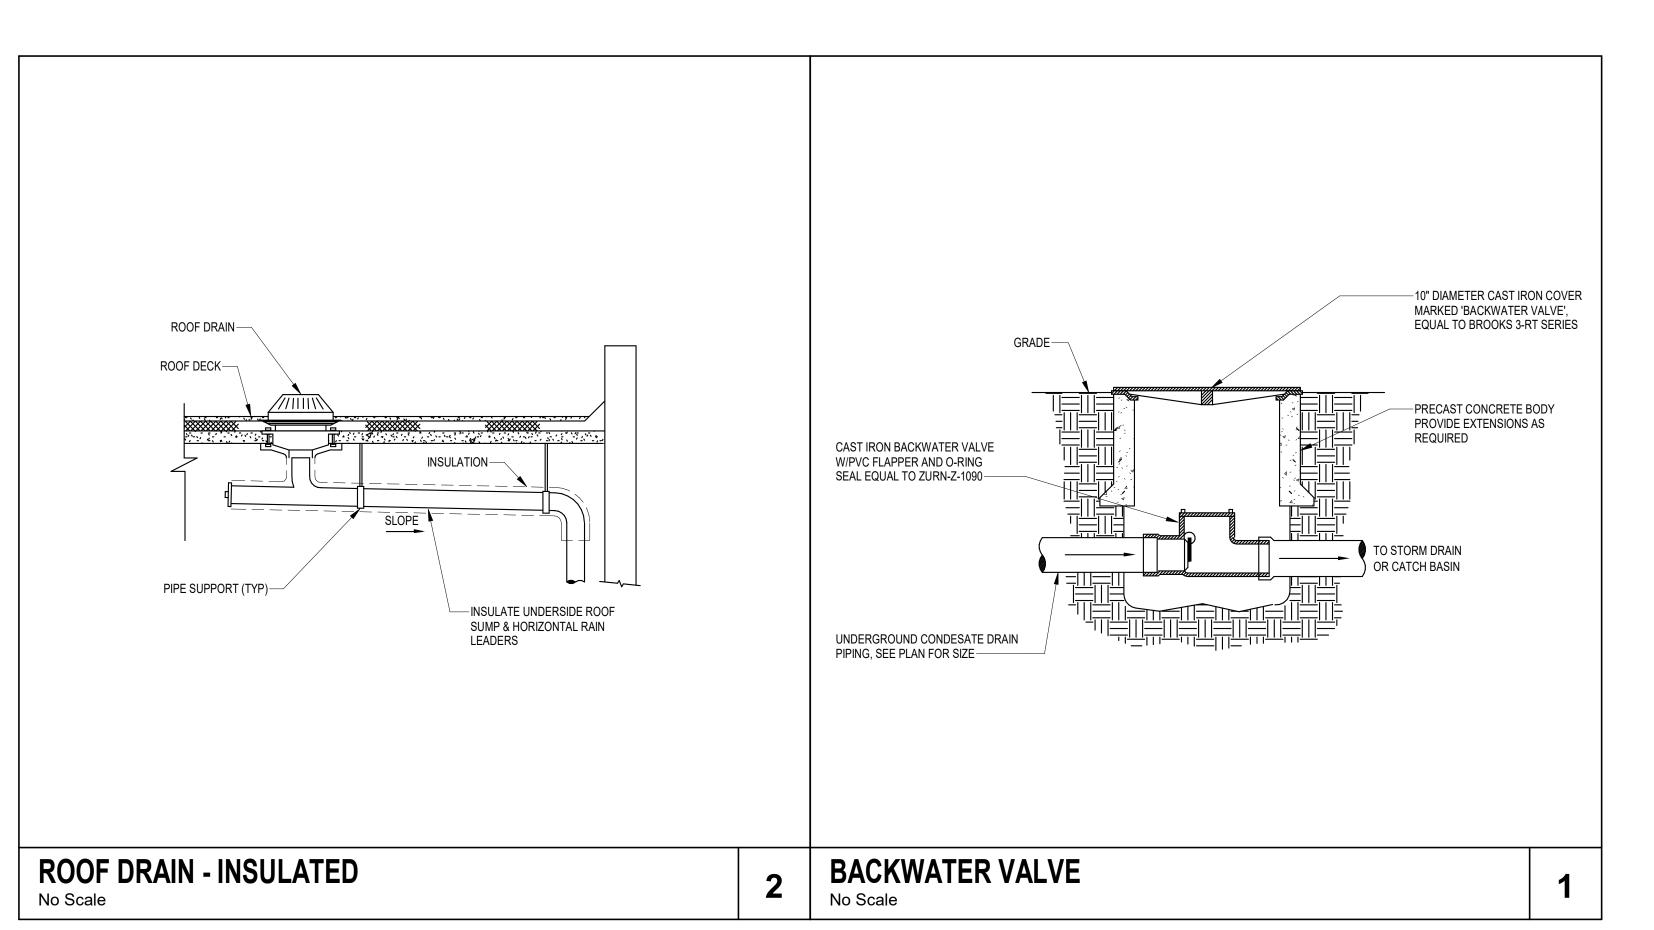
		DRAIN S	SCHEDU	JLE	PLUMB	ING SYMBOLS	PLUMI	BING ABBREVIATIONS	
MARK	DESCRIPTION	MANUFACTURER	MODEL	SPECIFICATION	SYMBOL	DESCRIPTION	ABBREVIATION	DESCRIPTION	
PD-4	DECK DRAIN	WATTS	FD-490-F-4	CAST IN PLACE PARKING DECK DRAIN WITH17"X17" (432X432) SQUARE ANTI-PONDING TOP					1. RI
				WITH MEMBRANE CLAMPING FLANGE, HEAVY DUTY SELF-CLOSING HINGED GRATE, ALUMINUM SEDIMENT BUCKET, AND NO HUB OUTLET.	CD	- CONDENSATE DRAIN PIPING	CA - AFF -	COMPRESSED AIR ABOVE FINISH FLOOR	
RD-1	ROOF DRAIN (PRIMARY)	WATTS	RD-300-K40	15" DIAMETER, DURA COATED CAST IRON BODY WITH FLASHING CLAMP, SUMP RECEIVER			AW -	ACID WASTE	2. Th
				AND UNDER DECK CLAMP, DRAIN SHALL HAVE COMBINATION MEMBRANE GRAVEL STOP AND	CW	- DOMESTIC COLD WATER PIPING	AV - CB -	ACID VENT CATCH BASIN	3. U1
TD 0	TREMOUDRAIN (OLAR ON ORARE)	711011	7000 UDO	GALVANIZED CAST IRON DOME.	HW	- DOMESTIC HOT WATER PIPING	CD -	CONDENSATE DRAIN	FI EX
TD-2	TRENCH DRAIN (SLAB-ON-GRADE)	ZURN	Z882-HDS	12" WIDE TOP MODULAR TRENCH DRAIN, MODULAR CHANNEL SECTIONS MADE OF 0% WATER ABSORBENT HIGH DENSITY POLYETHYLENE (HDPE), LOCKED INTO SURROUNDING	HWR	- DOMESTIC HOT WATER RETURN PIPING	CFH -	CUBIC FEET PER HOUR	DI
				CONCRETE EVERY 12", 12" WIDE REVEAL STAINLESS STEEL REINFORCED SLOTTED GRATE	SS	- SANITARY WASTE PIPING	CO - CONT -	CLEANOUT CONTINUATION	
				CONFORMING TO ASTM SPECIFICATION A351, GRADE CF8 (TYPE 304).		- VENT PIPING	CW -	DOMESTIC COLD WATER	4. FI
					ST	- STORM DRAIN PIPING	DI -	DEIONIZED WATER	17
					STO	- OVERFLOW STORM DRAIN PIPING	DN - DS -	DOWN DOWNSPOUT	5. NO
					310		DWG -	DRAWING	TI
					G	- FUEL GAS PIPING	EXIST - °F -	EXISTING DEGREE FAHRENHEIT	
					#	- HOSE BIBB OR WALL HYDRANT	F - FCO -	FLOOR CLEANOUT	6. PL
					• •		FD -	FLOOR DRAIN	E> IN
					<u>co</u> -	- CLEANOUT PLUG	FOF - FOG -	FUEL OIL FILL FUEL OIL GAGE	AN
					co 170	- WALL CLEANOUT	FOR -	FUEL OIL GAGE FUEL OIL RETURN	7. PF
					<u>co</u> (S)	- WALL CLEANOUT	FOS -	FUEL OIL SUPPLY	1.
						- FLOOR CLEANOUT / EXTERIOR CLEANOUT	FOV - FS -	FUEL OIL VENT FLOOR SINK	8. CC
							FSE# -	FOODSERVICE EQUIPMENT NUMBER	NO
					FD $\bigoplus$	- FLOOR DRAIN	G -	GAS	9. PF
					FS I	- FLOOR SINK	GPH - GPM -	GALLONS PER HOUR GALLONS PER MINUTE	40 01
					DD I	- DECK DRAIN	GR -	KITCHEN WASTE (GREASE)	10. SL AS
					DD	- DEGR DIVAIN	HB -	HOSE BIBB	FL
						- SHUT-OFF VALVE	- UH -	HUB DRAIN DOMESTIC HOT WATER	14 5
					[5]	- BALL VALVE	HWR -	DOMESTIC HOT WATER RECIRCULATING	11. FL
							IE - IW -	INVERT ELEVATION INDIRECT WASTE	12. W
					——————————————————————————————————————	- CALIBRATED BALANCING VALVE	KW -	KILOWATT	AF
						- CHECK VALVE (SWING)	LBS -	POUNDS	13. PF
					——————————————————————————————————————	- PRESSURE REDUCING VALVE	MH - NC -	MANHOLE NORMALLY CLOSED	SL
					\$	- SOLENOID OPERATING VALVE	NIC -	NOT IN CONTRACT	14. SE
					<u> </u>	- GAS COCK	NO -	NORMALLY OPEN	14. 31
					*		NP - NTS -	NON-POTABLE WATER NOT TO SCALE	15. PF
					*	- GAS PRESSURE REGULATOR	OD -	OUTSIDE DIAMETER	16. PF
					DETAIL No.		PRV -	PRESSURE REDUCING VALVE	AF
							PSI - PVC -	POUNDS PER SQUARE INCH POLYVINYL CHLORIDE PIPE	17. AL
					(4) P4.101)	- DETAIL REFERENCE	RD -	ROOF DRAIN	17. AL
					1 7.101		RPBP -	REDUCED PRESSURE BACKFLOW PREVENTOR SANITARY	18. Mo
					SHEET No.		SAN - SD -	STORM DRAIN	10 00
					SHOWN ON		SF -	SQUARE FEET	19. PF
							SH - ST -	SHEET STORM	
					4" S	- PIPE TAG	STO -	OVERFLOW STORM DRAIN	20. CC
					PIPE SIZE — PLUMBING SYSTEM		SW -	SOFT COLD WATER	
					I II L SIZL FLUMDING STSTEM		V - VAC -	VENT VACUUM	21. CO
					$\wedge$	DEMOION DEFENCE	VC -	VACUUM CLEANING	IN PI
					$\triangle$	- REVISION REFERENCE	VTR -	VENT THRU ROOF	
							WCO - WTR -	WALL CLEANOUT WATER	22. AL
									V



NOTE: SOME SYMBOLS SHOWN ON THIS LEGEND MAY NOT PERTAIN TO THIS PROJECT

## PLUMBING GENERAL NOTES

- 1. REFERENCE THE SPECIFICATIONS FOR MATERIAL AND EQUIPMENT INSTALLATION STANDARDS.
- 2. THE PLUMBING INSTALLATION SHALL COMPLY WITH ALL STATE AND LOCAL CODES.
- 3. UTILITIES AND SERVICES INDICATED ARE TAKEN FROM VARIOUS OLD AND NEW SURVEYS, AS-BUILT RECORDS AND FIELD INVESTIGATIONS. UNFORSEEN CONDITIONS PROBABLY EXIST AND NEW WORK MAY NOT BE FIELD LOCATED EXACTLY AS SHOWN ON DRAWINGS. COOPERATION WITH OTHER TRADES IN ROUTING AND BURIAL DEPTHS, AS DETERMINED DURING CONSTRUCTION, WILL BE NECESSARY.
- FIELD VERIFY EXISTING INSTALLATIONS. MODIFY EXISTING PLUMBING SYSTEMS, WHICH ARE TO REMAIN ACTIVE, TO FACILITATE RECONNECTION AND EXTENSION OF THE NEW WORK.
- 5. NOTIFY OWNER AT LEAST 24 HOURS PRIOR TO INTERRUPTING EXISTING SERVICE. SCHEDULE DISCONNECTION AND TIE-INS TO MINIMIZE DISRUPTION OF SERVICES. SERVICES ARE NOT TO BE LEFT DISRUPTED DURING NON-NORMAL CONTRACTOR WORKING HOURS.
- PLANS ARE NOT COMPLETELY TO SCALE. PIPE ROUTING SHOWN IS SCHEMATIC AND IS NOT INTENDED TO INDICATE EXACT ROUTING. CONTRACTOR SHALL PROVIDE ANY ADDITIONAL OFFSETS AND FITTINGS REQUIRED FOR PROPER INSTALLATION AND TO MAINTAIN CLEARANCES. VERIFY STRUCTURAL, MECHANICAL AND ELECTRICAL INSTALLATIONS AND OTHER POTENTIAL OBSTRUCTIONS AND ROUTE PIPING TO AVOID INTERFERENCES.
- 7. PROVIDE ALL OFFSETS AND FITTINGS AND MAKE CONNECTION TO SITE UTILITIES.
- 8. CONCEAL PIPING ABOVE CEILINGS, WITHIN WALLS OR CHASES EXCEPT IN MECHANICAL ROOMS OR AS SPECIFICALLY NOTED.
- PROVIDE ACCESS PANELS FOR ALL VALVES CONCEALED IN WALLS OR ABOVE NON-ACCESSIBLE CEILINGS.
- SLEEVE AND/OR FIRESTOP ALL PENETRATIONS THROUGH RATED WALLS, CEILINGS, AND FLOORS WITH U/L LISTED ASSEMBLIES. FIRESTOP ASSEMBLIES SHALL BE EQUAL TO OR EXCEED THE RATING OF THE WALL, CEILING OR FLOOR. SEE ARCHITECTURAL DRAWINGS FOR FINAL FINISHES.
- 11. FLASH AND COUNTER-FLASH ROOF PENETRATIONS.
- . WHEN BEAM SLEEVE PENETRATIONS ARE NECESSARY, COORDINATE PENETRATIONS WITH ALL TRADES, THE ARCHITECT AND THE STRUCTURAL ENGINEER.
- 13. PROVIDE FOUNDATION PAD PENETRATION SLEEVES. ALLOW 1" MINIMUM CLEARANCE BETWEEN SLEEVE INSIDE SURFACE AND PIPE EXTERIOR.
- 14. SEE ARCHITECTURAL DRAWINGS FOR FIXTURE LOCATIONS AND MOUNTING HEIGHTS.
- 5. PROVIDE AUTOMATIC TRAP PRIMERS FOR FLOOR DRAIN TRAP SEALS.
- 16. PROVIDE AN AIR GAP, WHEN REQUIRED BY CODE, SERVING INDIVIDUAL FIXTURES, DEVICES, APPLIANCES AND
- 17. ALL EXPOSED PIPE AND FITTINGS IN FINISHED AREAS SHALL BE CHROME PLATED.
- 18. MOUNT HOSE BIBBS 24" ABOVE FINISHED GRADE.
- 19. PROVIDE CLEANOUTS IN ACCORDANCE WITH ALL STATE AND LOCAL CODES. INSTALL CLEANOUT WITH COVER FLUSH TO FINISH SURFACE
- 20. COORDINATE EXACT FLOOR DRAIN LOCATIONS WITH ARCHITECTURAL DRAWINGS. SET FLOOR DRAINS BELOW FINISHED FLOOR TO ALLOW FOR FLOOR SLOPING TO THE DRAIN.
- 21. COORDINATE PIPING WITH ALL ELECTRICAL EQUIPMENT (PANELS, TRANSFORMERS, ETC.) PRIOR TO ANY INSTALLATION. DO NOT ROUTE ANY PIPING OVER ANY ELECTRICAL PANELS UNDER ANY CIRCUMSTANCES. ANY PIPING RUN OVER PANELS SHALL BE RE-ROUTED AT NO ADDITIONAL COST.
- 22. ALL WALL MOUNTED LAVATORIES SHALL BE ATTACHED TO FLOOR MOUNTED CARRIER DESIGNED TO WITHSTAND A VERTICAL LOAD OF 250 POUNDS ON THE FRONT OF THE FIXTURE.
- 23. PROVIDE SANITARY WASTE, VENT, DOMESTIC WATER, ETC. ROUGH-IN AND MAKE FINAL CONNECTIONS (TO INCLUDE PROVIDING ALL NECESSARY RELATED STOPS, VALVES, TRAPS, ETC. AND MAKE READY FOR USE) TO ALL EQUIPMENT, WHETHER FURNISHED BY THIS CONTRACTOR OR FURNISHED BY OTHERS.
- 24. ALL MATERIALS AND EQUIPMENT INSTALLED IN RETURN AIR PLENUMS SHALL BE NON-COMBUSTIBLE AND UL APPROVED FOR USE IN A RETURN AIR PLENUM SPACE. IF MATERIALS ARE NOT NON-COMBUSTIBLE IN RETURN AIR PLENUMS, THEY SHALL BE REPLACED OR WRAPPED WITH A UL LISTED FIRE RATED FIRE WRAP (I.E. FYREWRAP 0.5 PLENUM INSULATION OR APPROVED EQUAL) AND INSTALLED IN ACCORDANCE WITH THE MANUFACTURES UL LISTED DETAILS AND RECOMMENDATIONS AT NO ADDITIONAL COST. (NOTE: REFER TO MECHAICAL DRAWINGS FOR RETURN AIR PLENUM INCOLUMNS)
- 25. PIPING, INSULATION, FITTINGS, MATERIALS, COVERS AND FINISHES IN RETURN AIR PLENUM SHALL HAVE A MAXIMUM FLAME SPREAD RATING OF 25 AND A MAXIMUM SMOKE DEVELOPED RATING OF 50.

## PLUMBING DRAWING INDEX

SHEET	DESCRIPTION
P0.01	PLUMBING SYMBOLS, LEGEND, NOTES AND INDEX
P1.00	PLUMBING SITE PLAN
P1.01	PLUMBING UNDERGROUND PLAN
P1.02	PLUMBING FLOOR PLAN GROUND LEVEL
P1.03	PLUMBING FLOOR PLAN - SECOND LEVEL
P1.04	PLUMBING FLOOR PLAN - THIRD LEVEL
P1.05	PLUMBING FLOOR PLAN - ROOF
P6.0	STORM RISER

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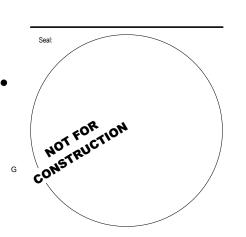
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Schematic Design

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Date Revision

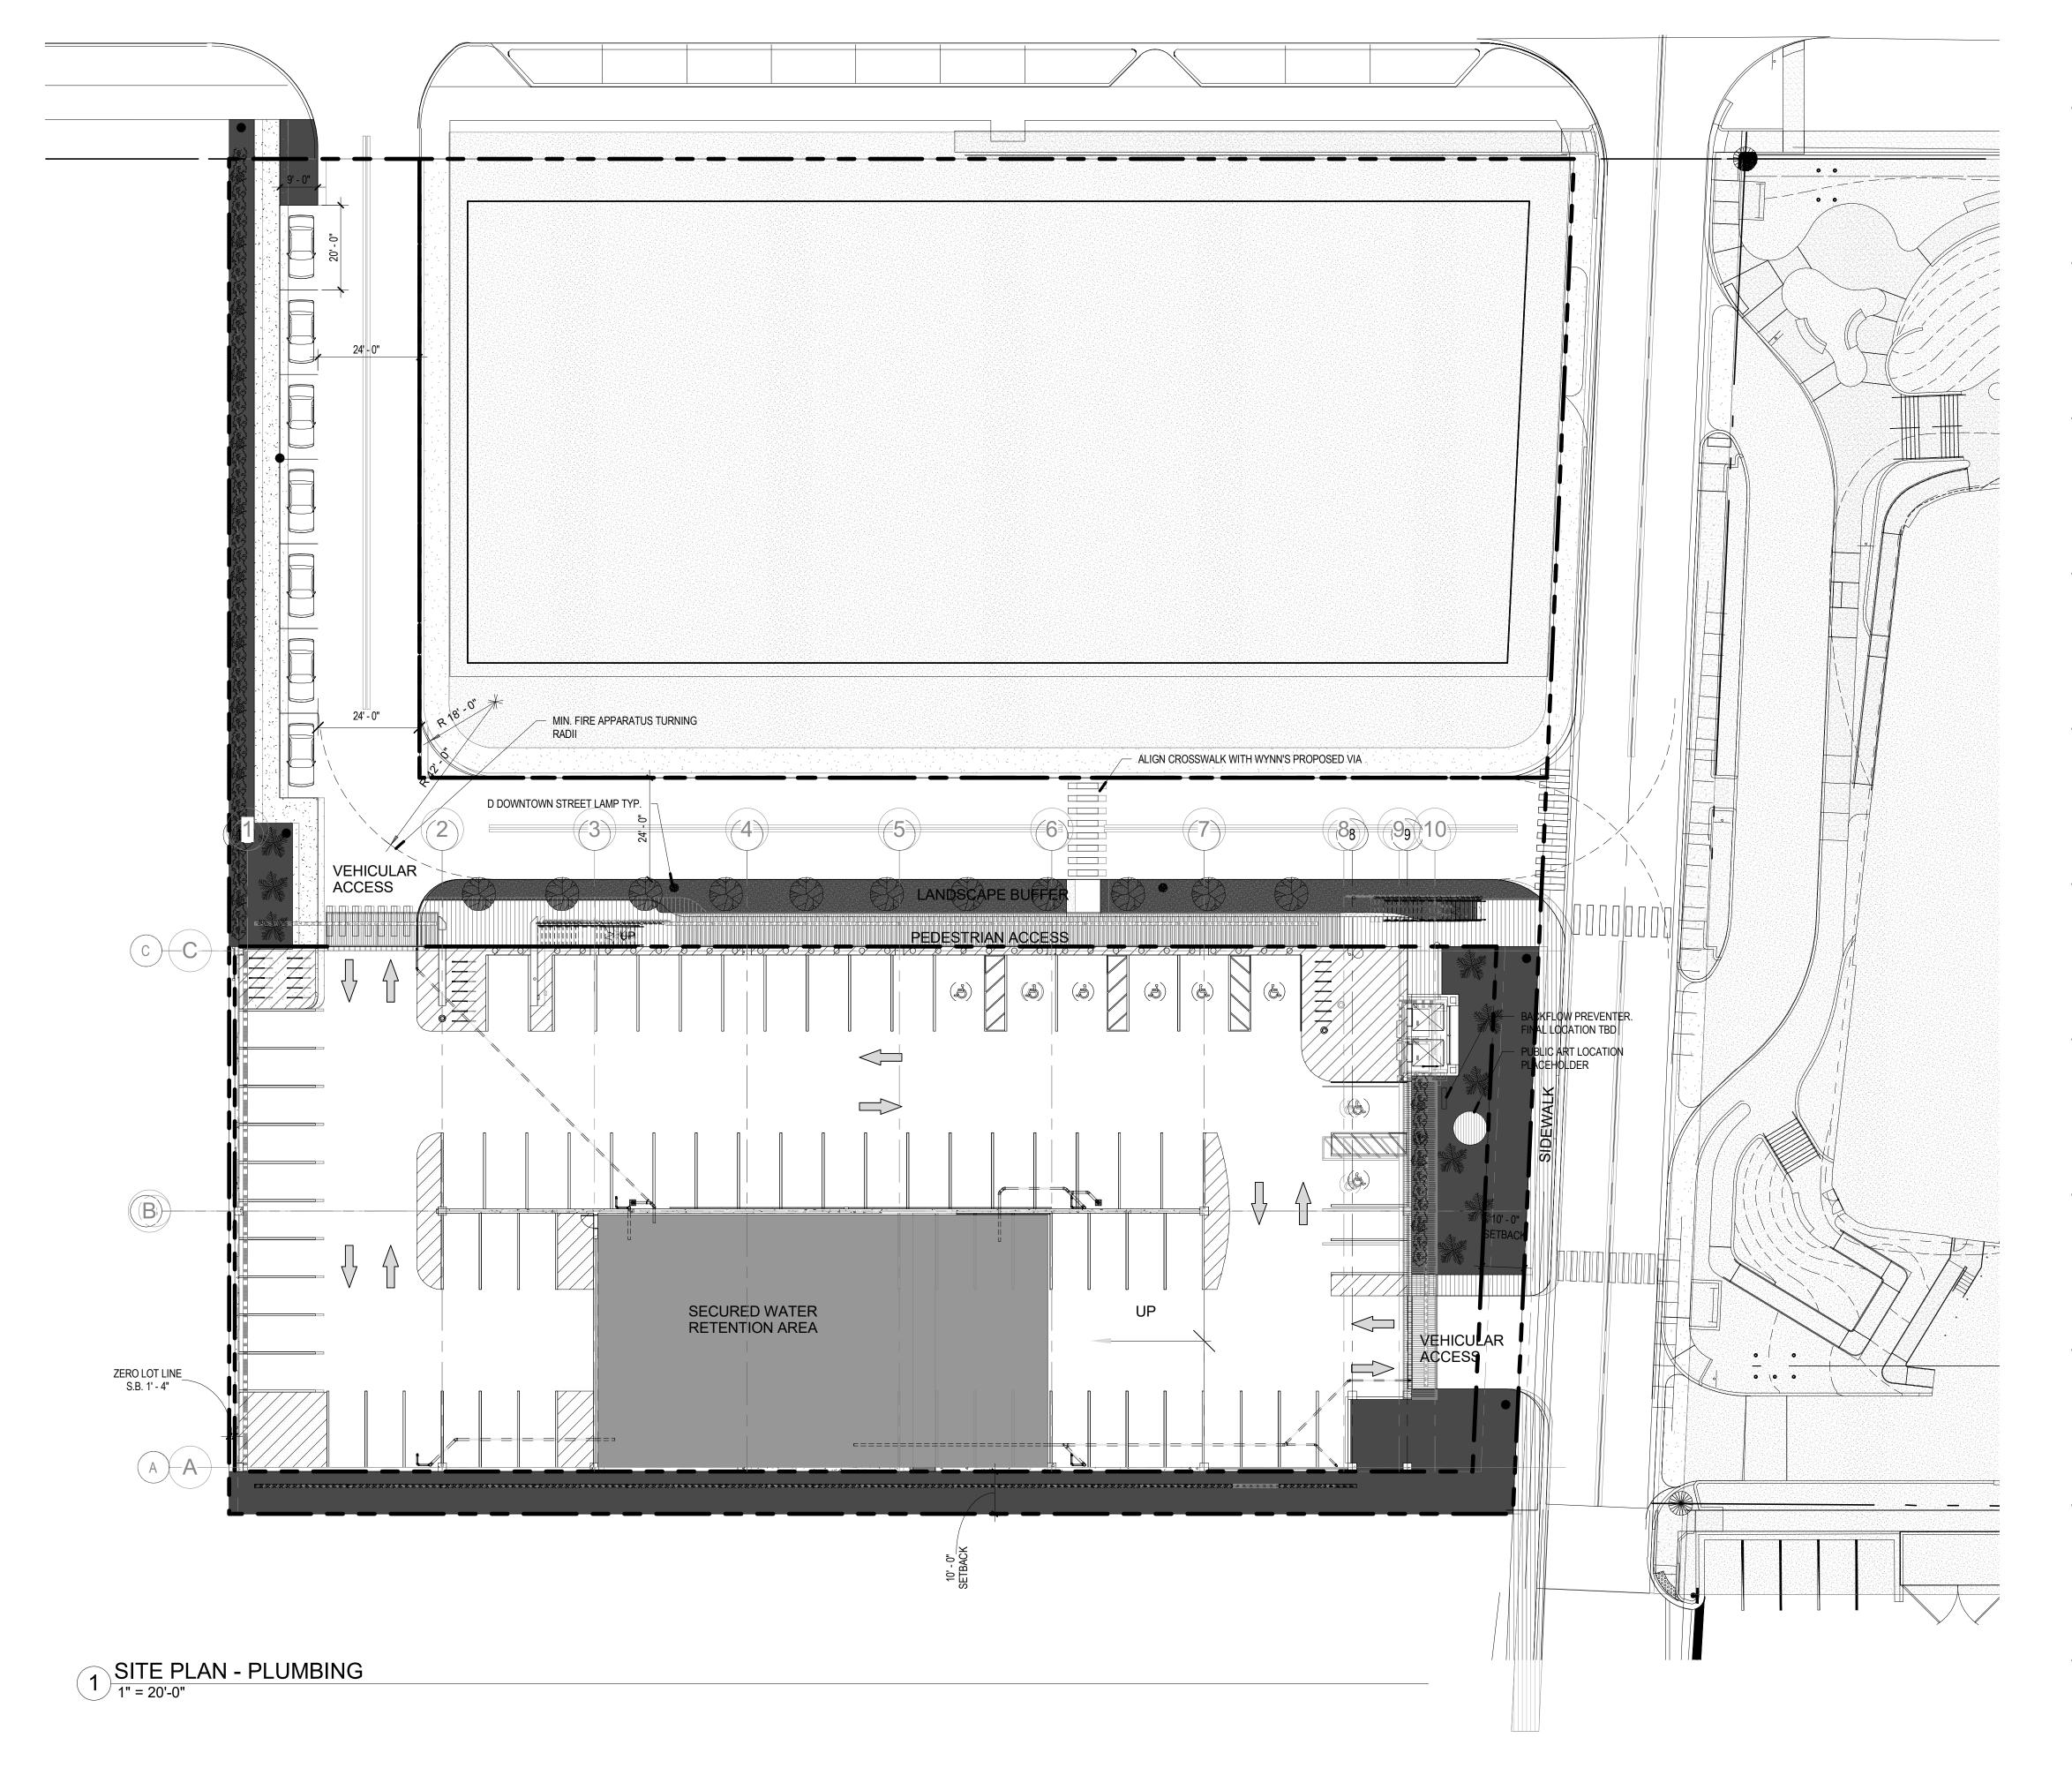
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PLUMBING
SYMBOLS,
LEGEND, NOTES

A AND INDEX





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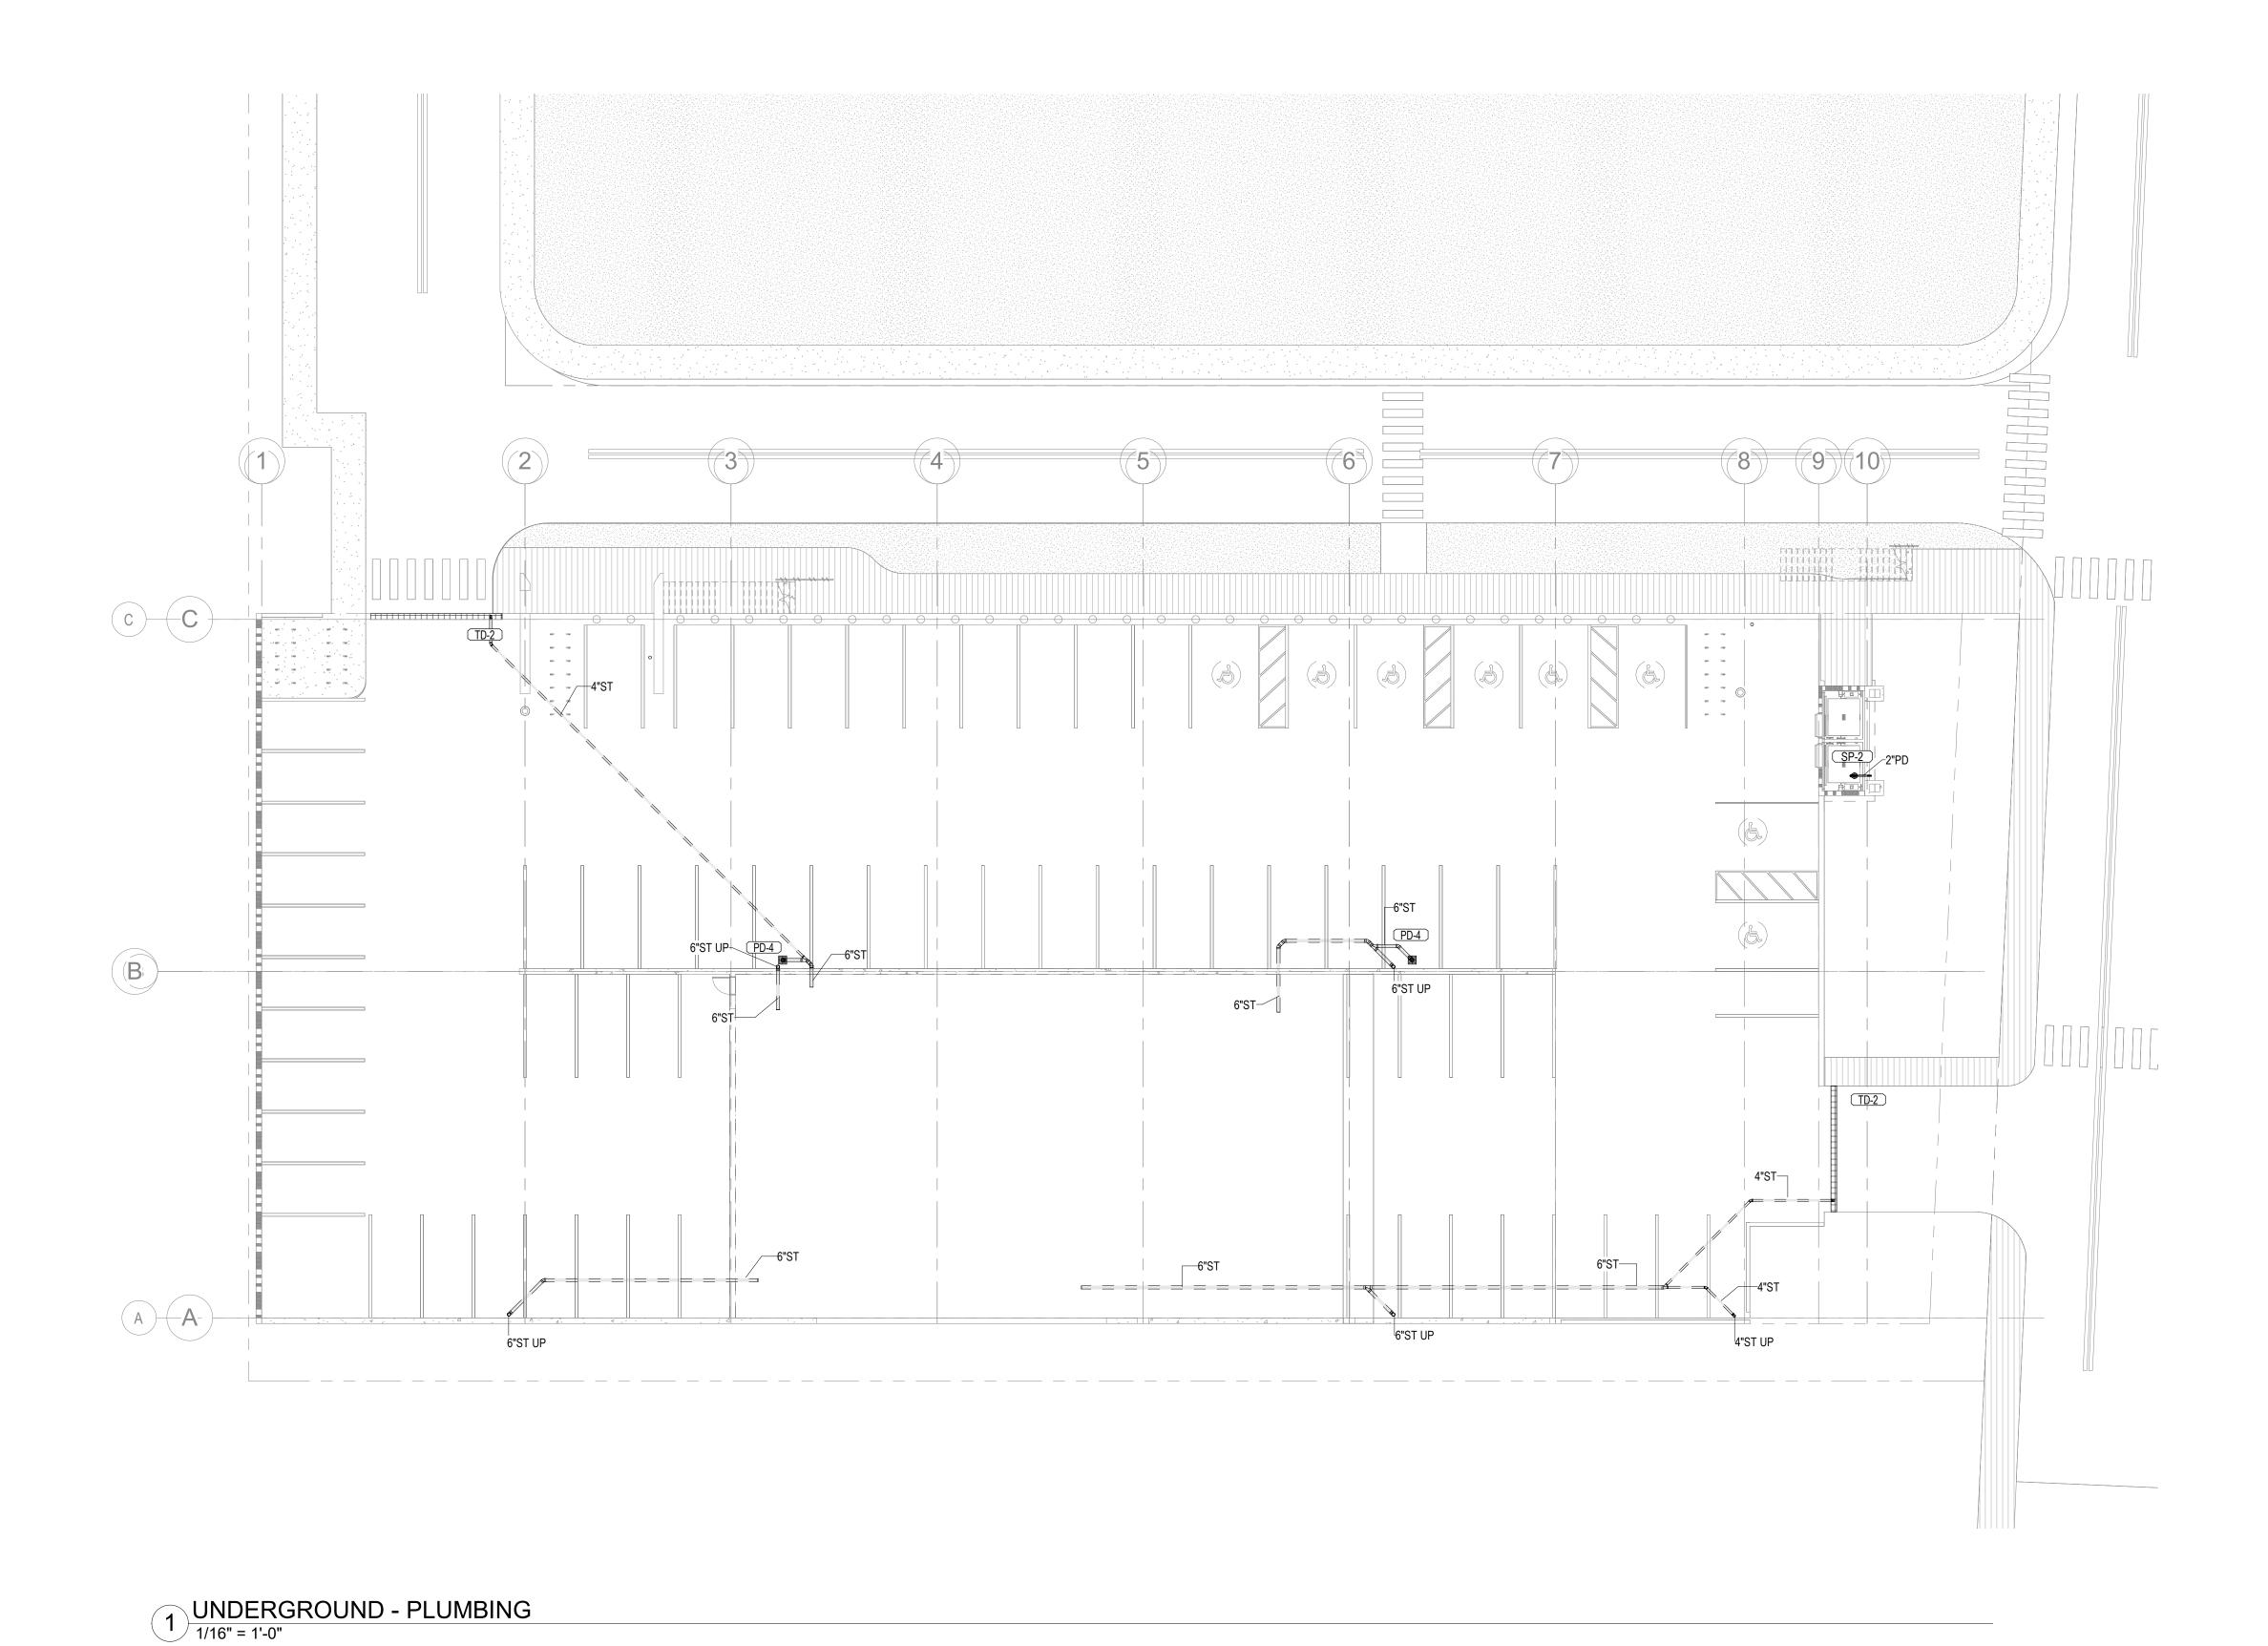
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PLUMBING SITE
PLAN

P1.00

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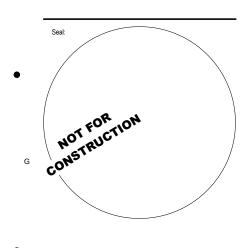
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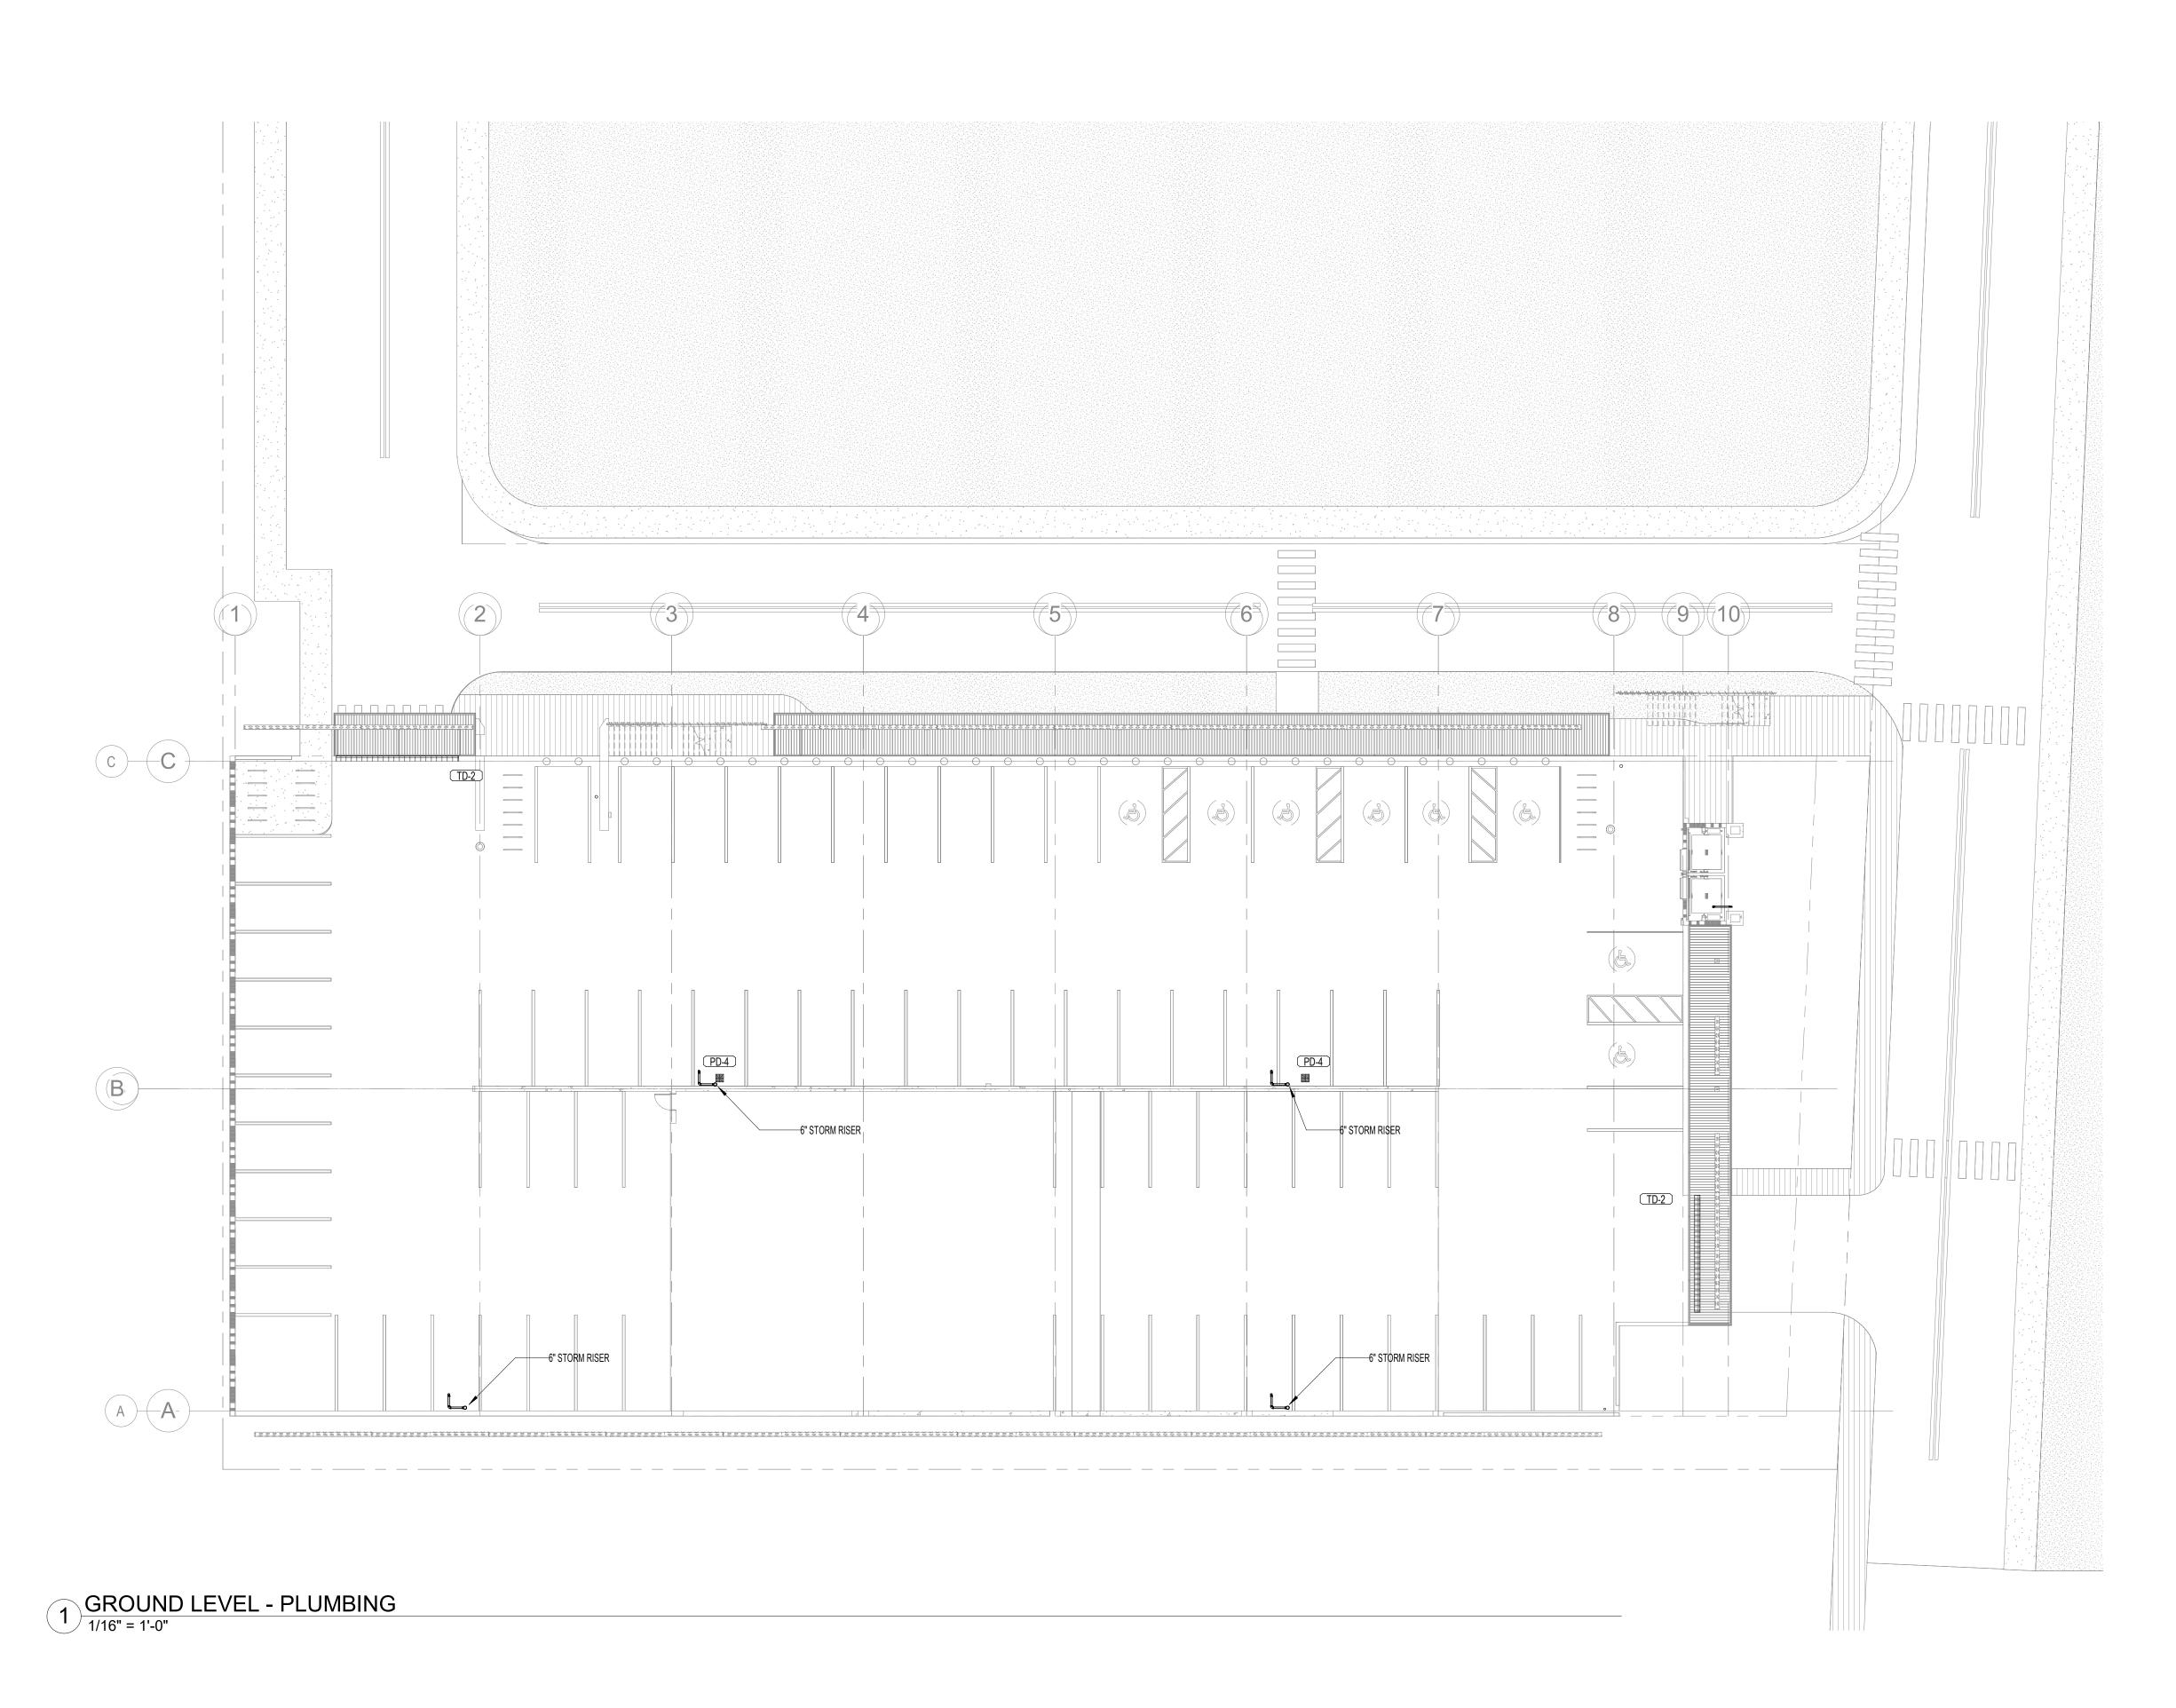
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PLUMBING
UNDERGROUND
PLAN
Sheet No.

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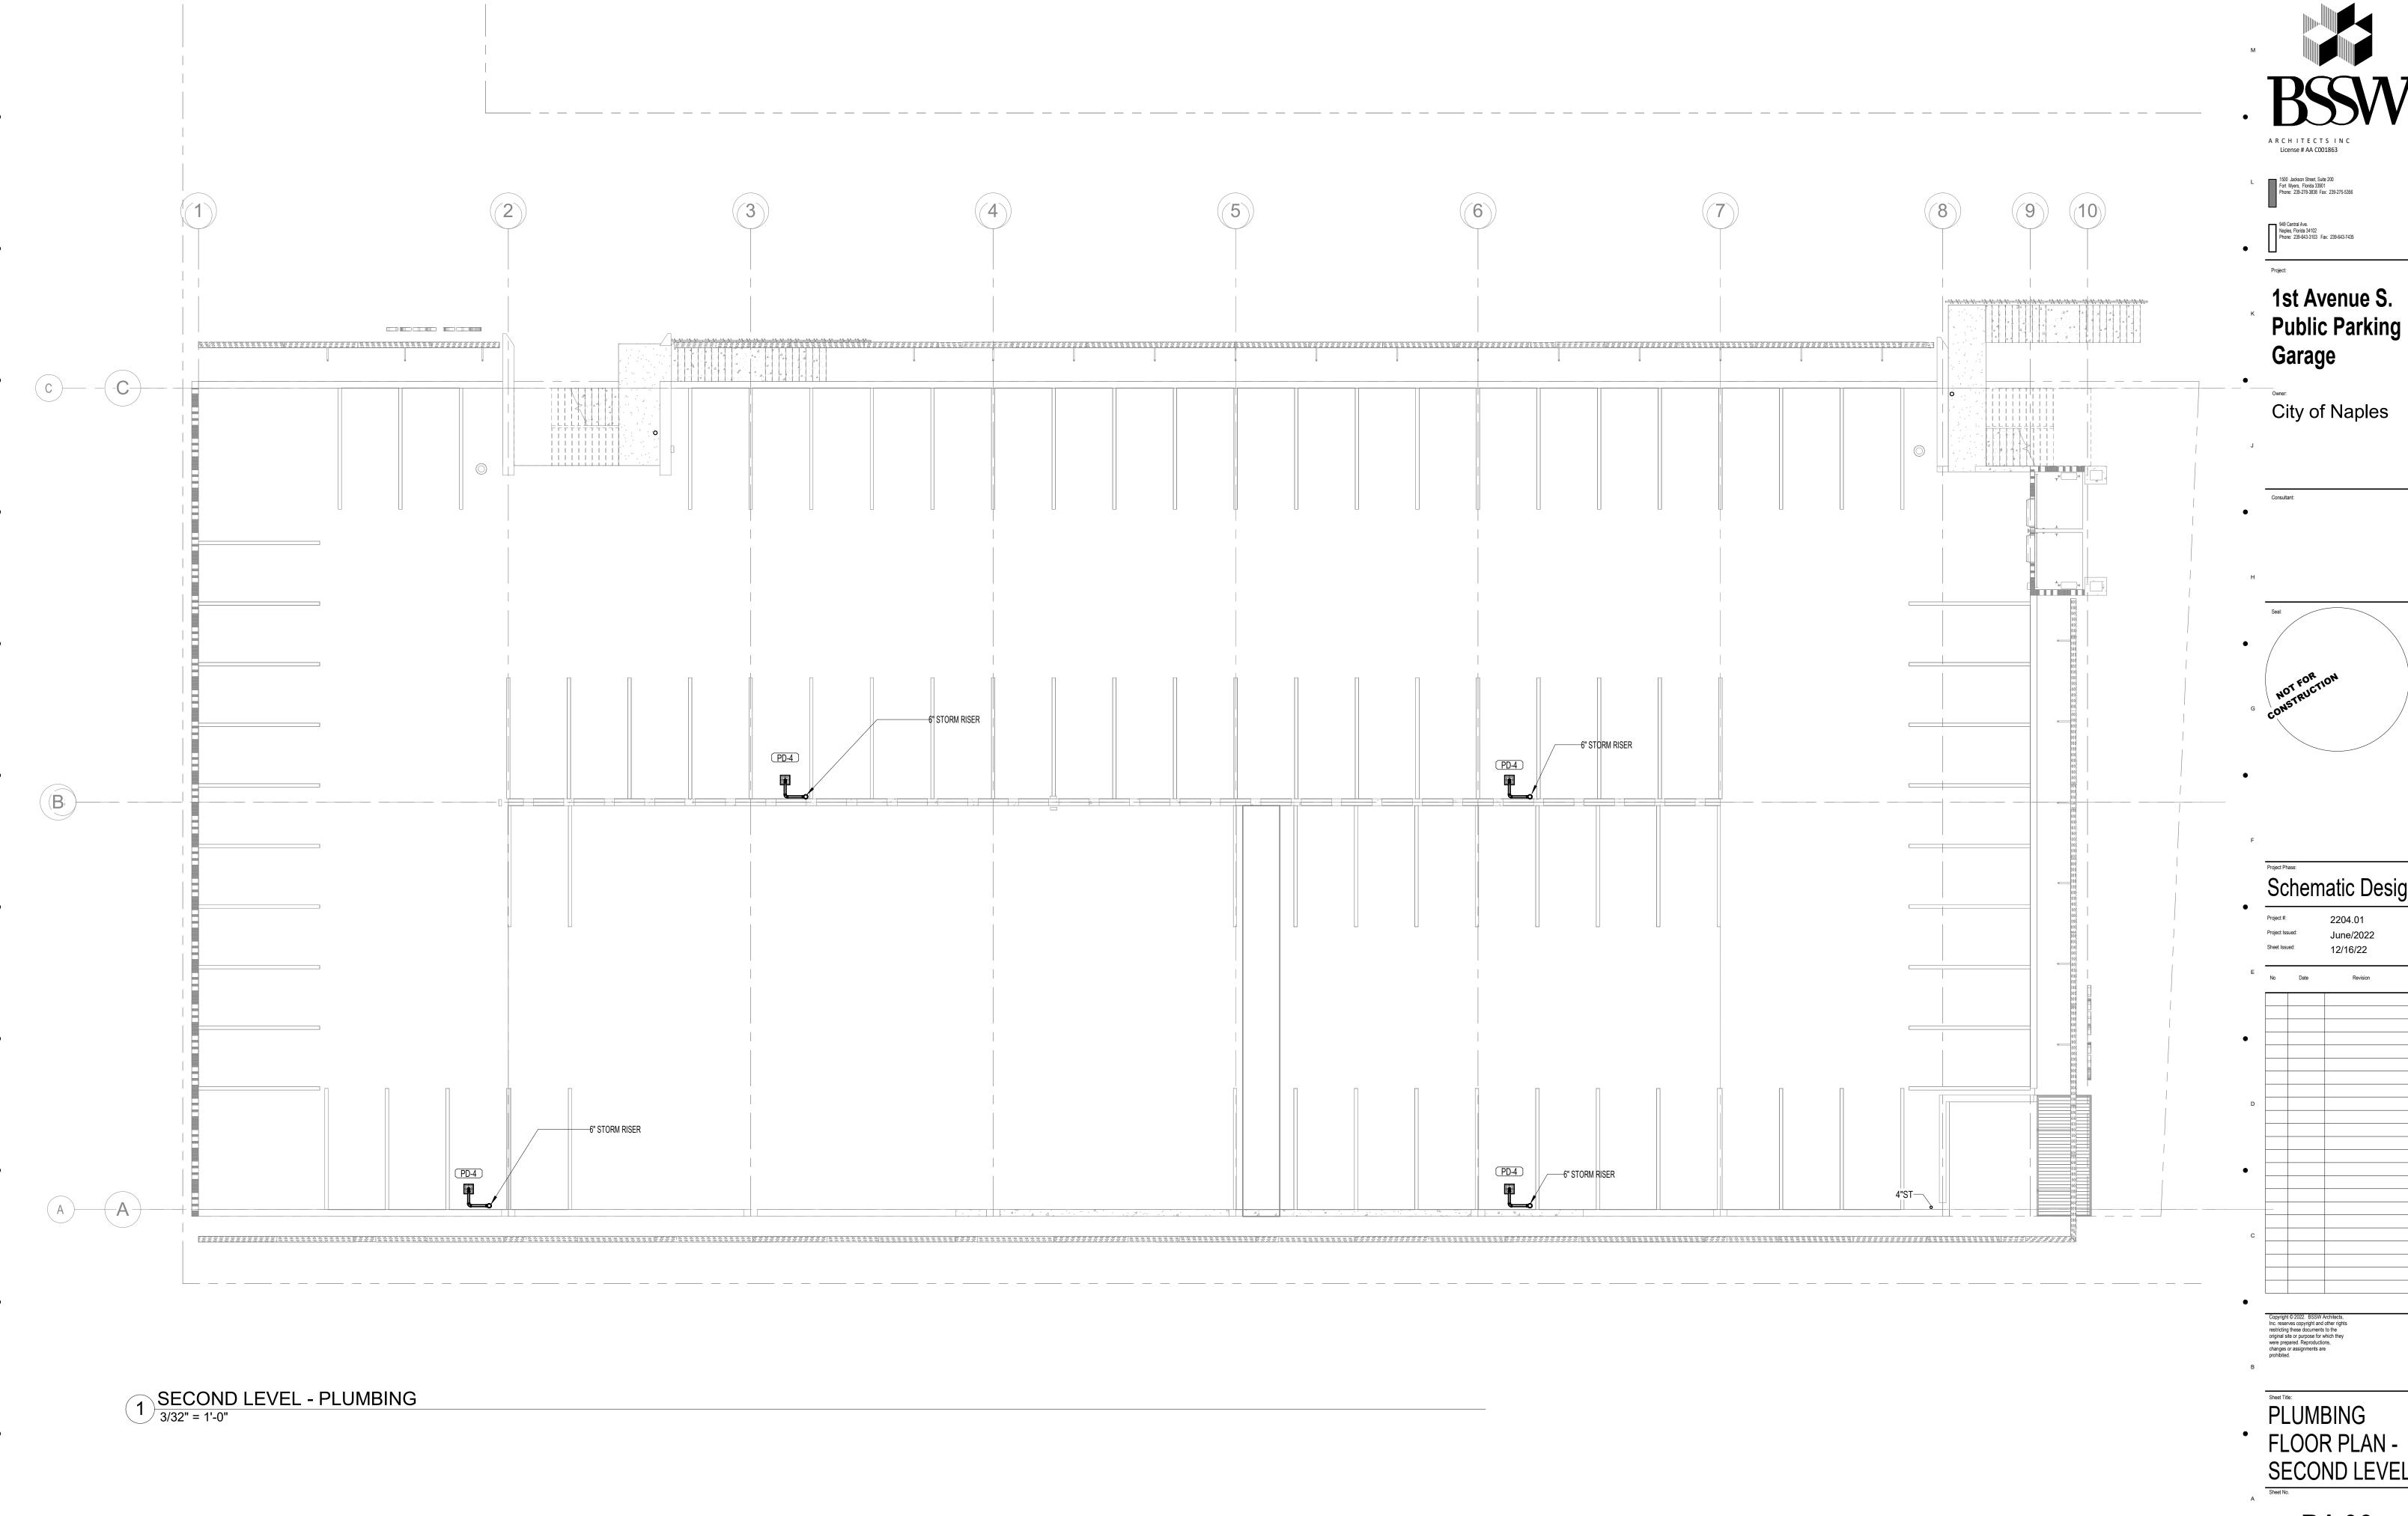
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PLUMBING
FLOOR PLAN
GROUND LEVEL

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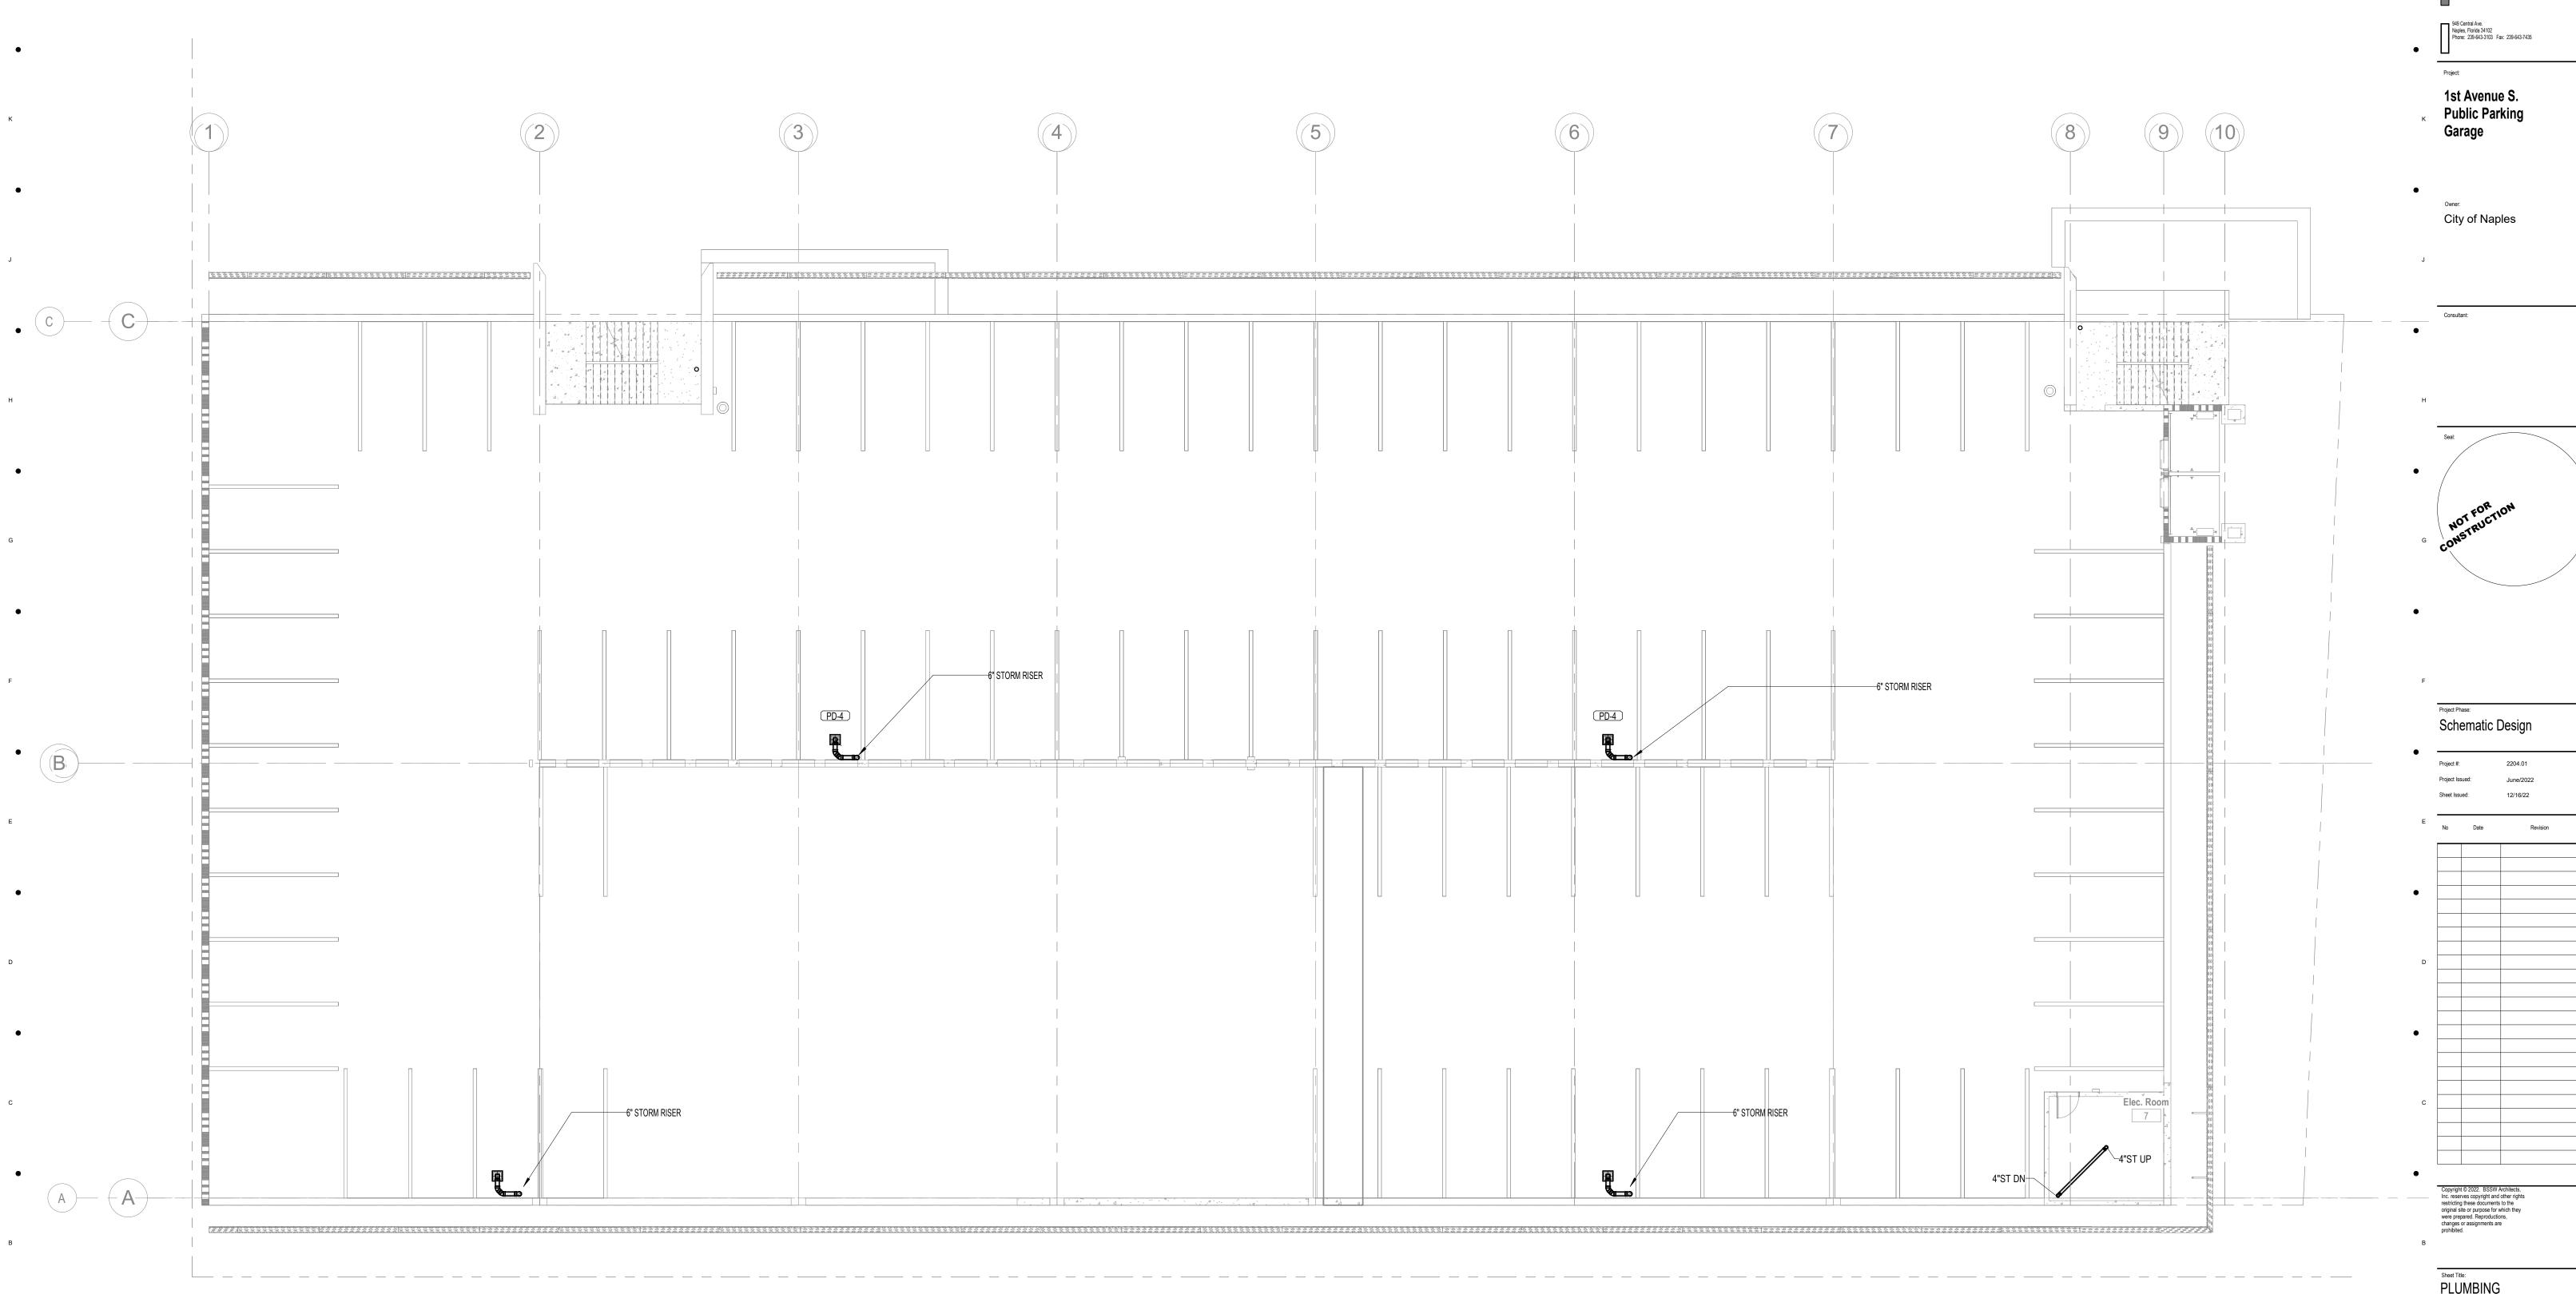
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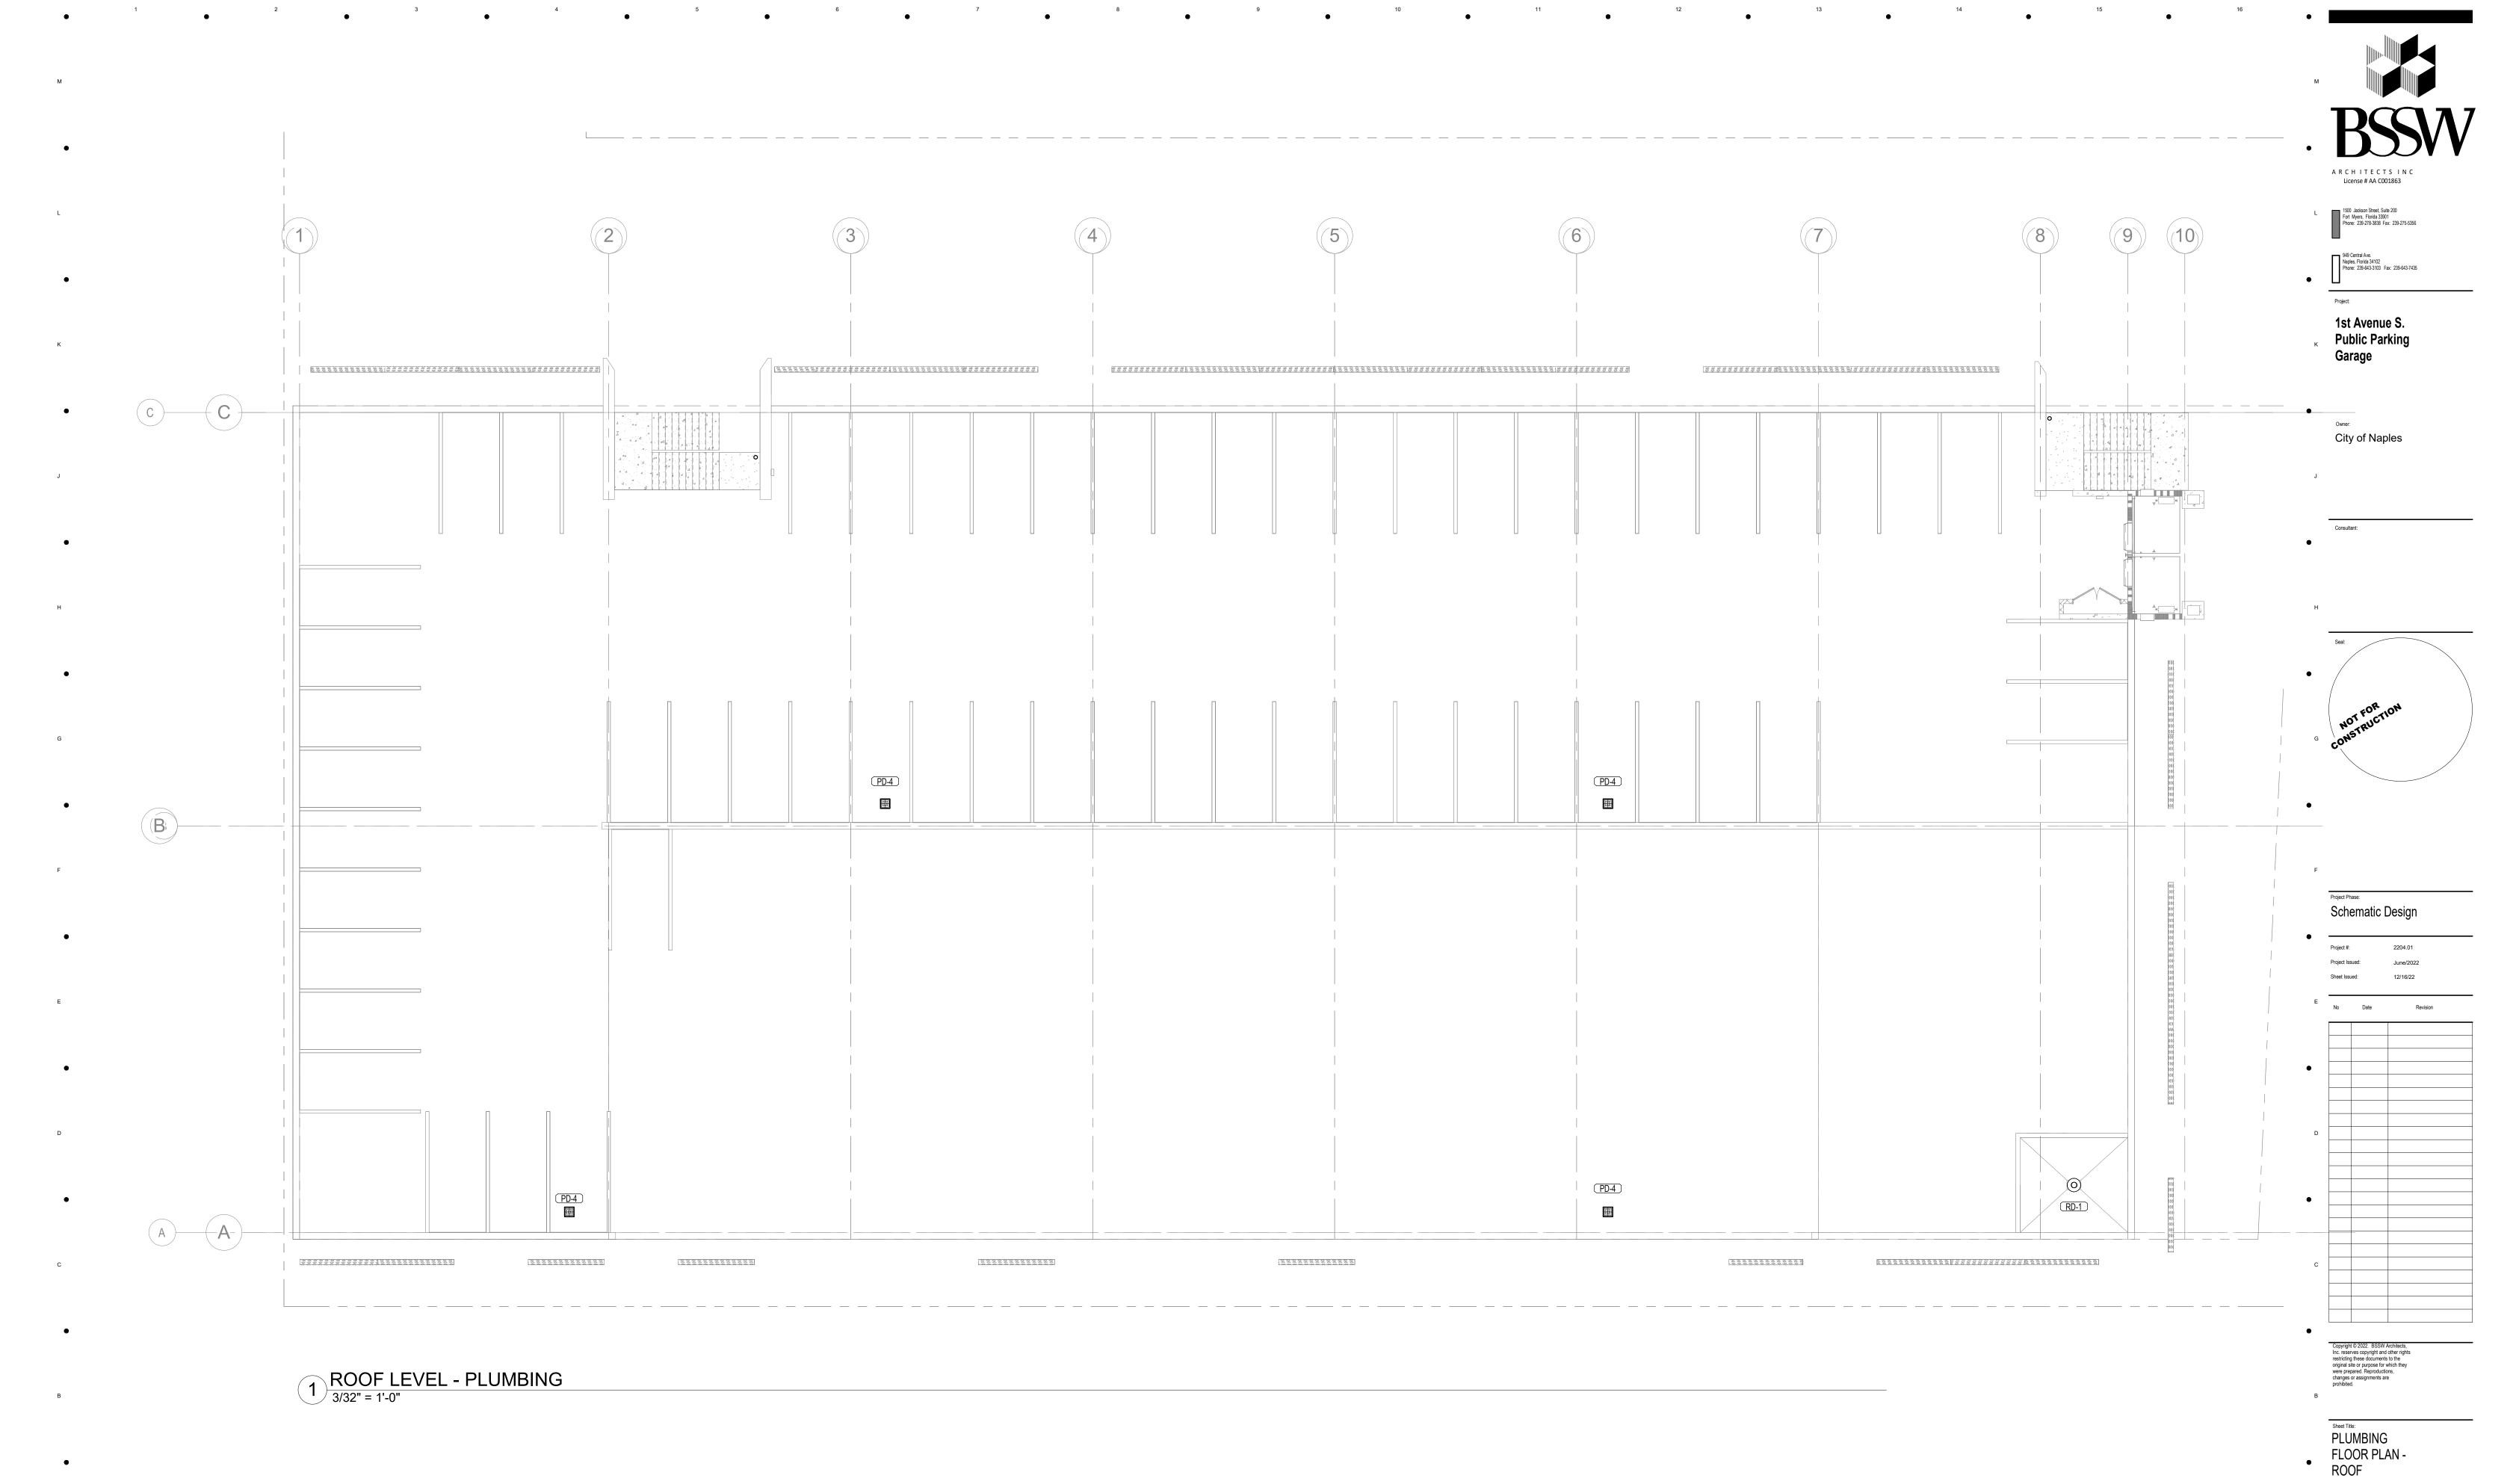
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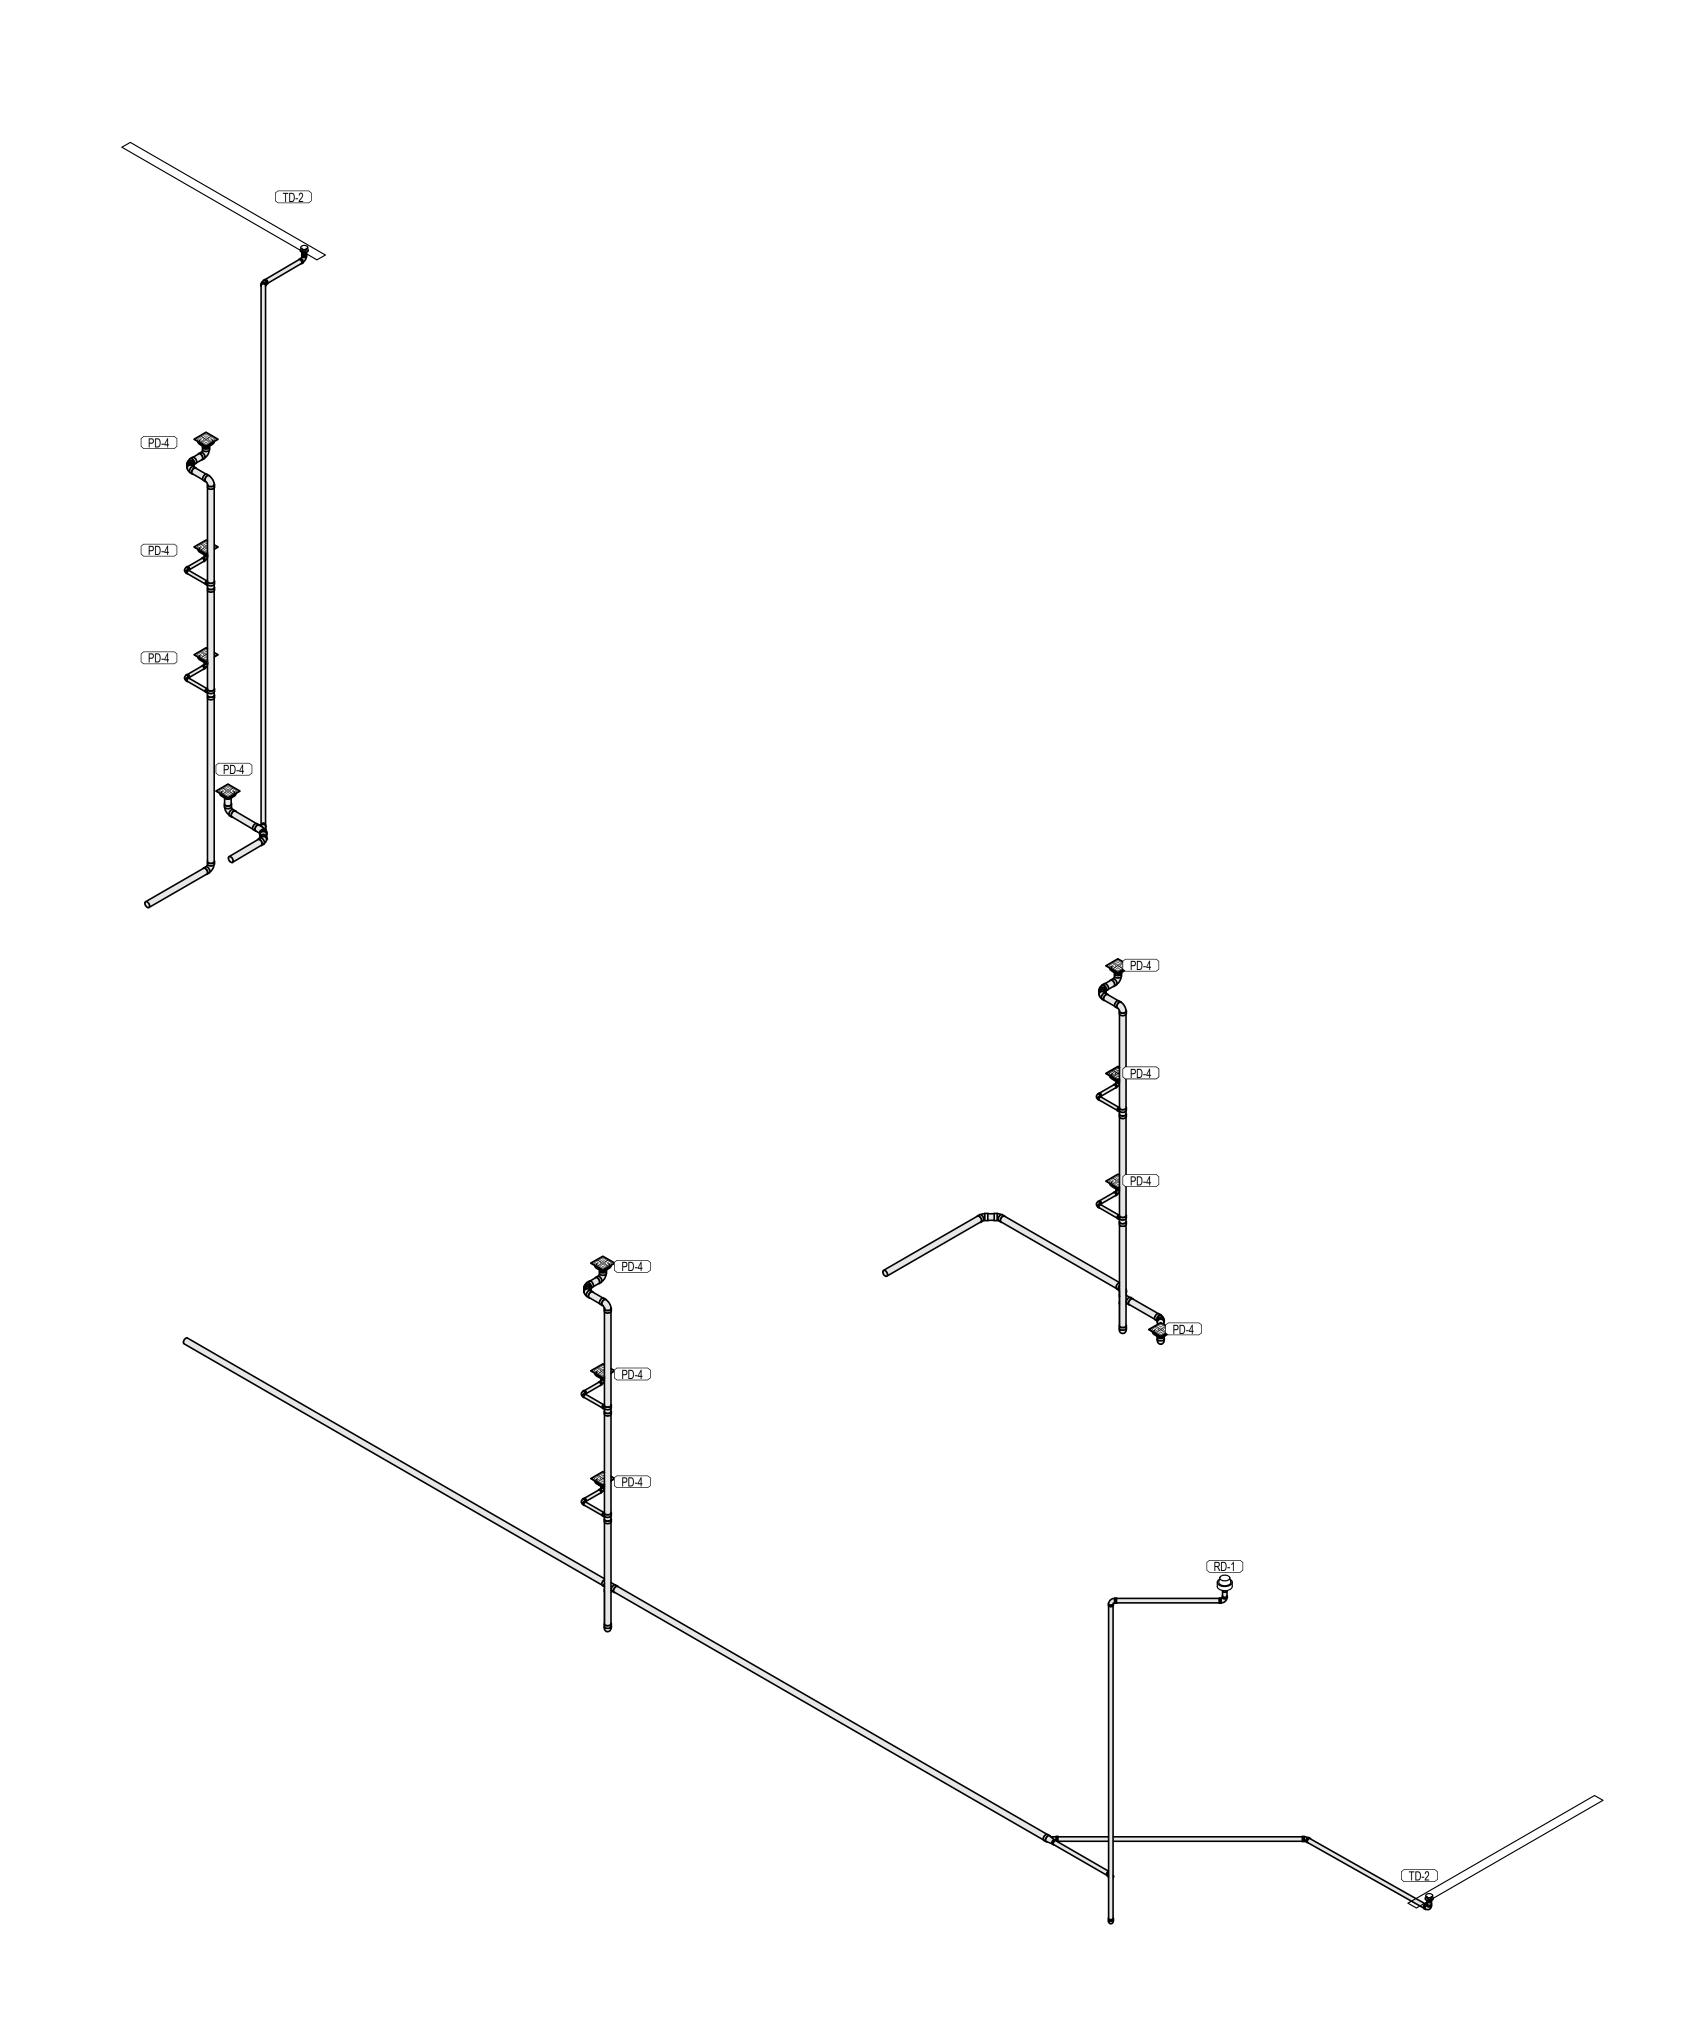
1 THIRD LEVEL - PLUMBING
3/32" = 1'-0"

FLOOR PLAN -THIRD LEVEL



P1.05

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PD-4

PD-4



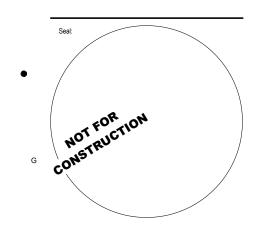
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STORM RISER

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