

# BID PLANS FOR THE CITY OF NAPLES RECYCLE TRANSFER FACILITY

**PART OF SECTION 2, TOWNSHIP 50 SOUTH, RANGE 25 EAST,  
COLLIER COUNTY, FLORIDA**


















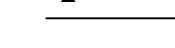
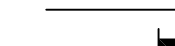
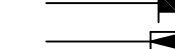
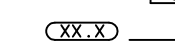
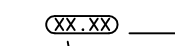
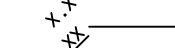
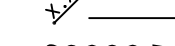
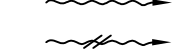
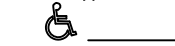




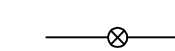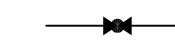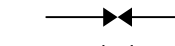

A DEVELOPMENT BY  
**CITY OF NAPLES**  
380 RIVERSIDE CIRCLE  
NAPLES, FLORIDA 34102  
(239) 213-4745
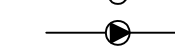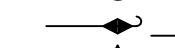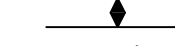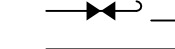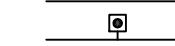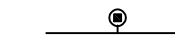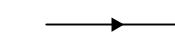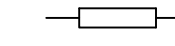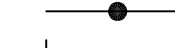
## LEGEND


### ABBREVIATIONS

BOC \_\_\_\_\_ BACK OF CURB or BACK OF GUTTER  
EOP \_\_\_\_\_ EDGE OF PAVEMENT  
DE \_\_\_\_\_ DRAINAGE EASEMENT  
LME \_\_\_\_\_ LAKE MAINTENANCE EASEMENT  
UE \_\_\_\_\_ UTILITY EASEMENT  
CUE \_\_\_\_\_ CITY UTILITY EASEMENT  
EL or ELEV. \_\_\_\_\_ ELEVATION  
INV. \_\_\_\_\_ INVERT  
LF \_\_\_\_\_ LINEAR FEET  
NAVD \_\_\_\_\_ NORTH AMERICAN VERTICAL DATUM  
NGVD \_\_\_\_\_ NATIONAL GEODETIC VERTICAL DATUM  
PVI \_\_\_\_\_ POINT OF VERTICAL INTERSECTION  
NIC \_\_\_\_\_ NOT IN CONTRACT  
R/W or ROW \_\_\_\_\_ RIGHT OF WAY  
SB \_\_\_\_\_ SOIL BORING  
STA \_\_\_\_\_ STATION  
UP \_\_\_\_\_ UTILITY POLE  
FDOT \_\_\_\_\_ FLORIDA DEPARTMENT OF TRANSPORTATION  
CATV \_\_\_\_\_ CABLE TELEVISION  
FPL or FP&L \_\_\_\_\_ FLORIDA POWER & LIGHT  
UTF \_\_\_\_\_ CENTURYLINK  
NAA \_\_\_\_\_ NAPLES AIRPORT AUTHORITY  
CNPUI \_\_\_\_\_ CITY OF NAPLES PUBLIC UTILITIES  
CNFD \_\_\_\_\_ CITY OF NAPLES FIRE DEPARTMENT  
B.L. \_\_\_\_\_ BASE LINE  
C.L. \_\_\_\_\_ CENTERLINE  
F.L. \_\_\_\_\_ FLOW LINE  
P.L. \_\_\_\_\_ PROPERTY LINE  
CMP \_\_\_\_\_ CORRUGATED METAL PIPE  
D.I.P. \_\_\_\_\_ DUCTILE IRON PIPE  
PVC \_\_\_\_\_ POLYVINYL CHLORIDE PIPE  
HDPE \_\_\_\_\_ HIGH DENSITY POLYETHYLENE  
RCP \_\_\_\_\_ REINFORCED CONCRETE PIPE  
ERCP \_\_\_\_\_ ELLIPTICAL REINFORCED CONCRETE PIPE  
MH \_\_\_\_\_ MANHOLE  
STR \_\_\_\_\_ STORM SEWER STRUCTURE  
X.XX' LT/X.XX' RT \_\_\_\_\_ FEET LEFT or FEET RIGHT


### SYMBOLS

 AIR RELEASE VALVE, COMPLETE  
 IN-LINE PLUG VALVE W/ BOX  
 IN-LINE VALVE W/ BOX  
 IN-LINE CHECK VALVE W/ BOX  
 FIRE HYDRANT, COMPLETE  
 FIRE DEPARTMENT CONNECTION  
 POST INDICATOR VALVE  
 BLOW-OFF W/ BACTERIAL SAMPLE POINT  
 BACTERIAL SAMPLE POINT  
 BLOW-OFF  
 PIPE PLUG  
 WATER METER  
 IRRIGATION METER  
 REDUCER  
 BACKFLOW PREVENTER/ABOVE GROUND METER  
 SANITARY SEWER MANHOLE  
 SANITARY SEWER LATERAL & CLEAN-OUT  
 PUMP STATION  
 STORM SEWER & STRUCTURE  
 STORM SEWER & STRUCTURE WITH SIDE INLETS  
 HEADWALL  
 U-ENDWALL  
 CONTROL STRUCTURE  
 MITERED END/FLARED END SECTION  
 PROPOSED ELEVATION  
 PROPOSED PAVEMENT ELEVATION  
 EXISTING ELEVATION  
 EXISTING PAVEMENT ELEVATION  
 DIRECTION OF DRAINAGE FLOW  
 SWALE & DIRECTION OF FLOW  
 HANDICAPPED PARKING SPACE  
 UNDERDRAIN

NOTE: OPEN SYMBOLS AND DASHED LINES DENOTE EXISTING IMPROVEMENTS

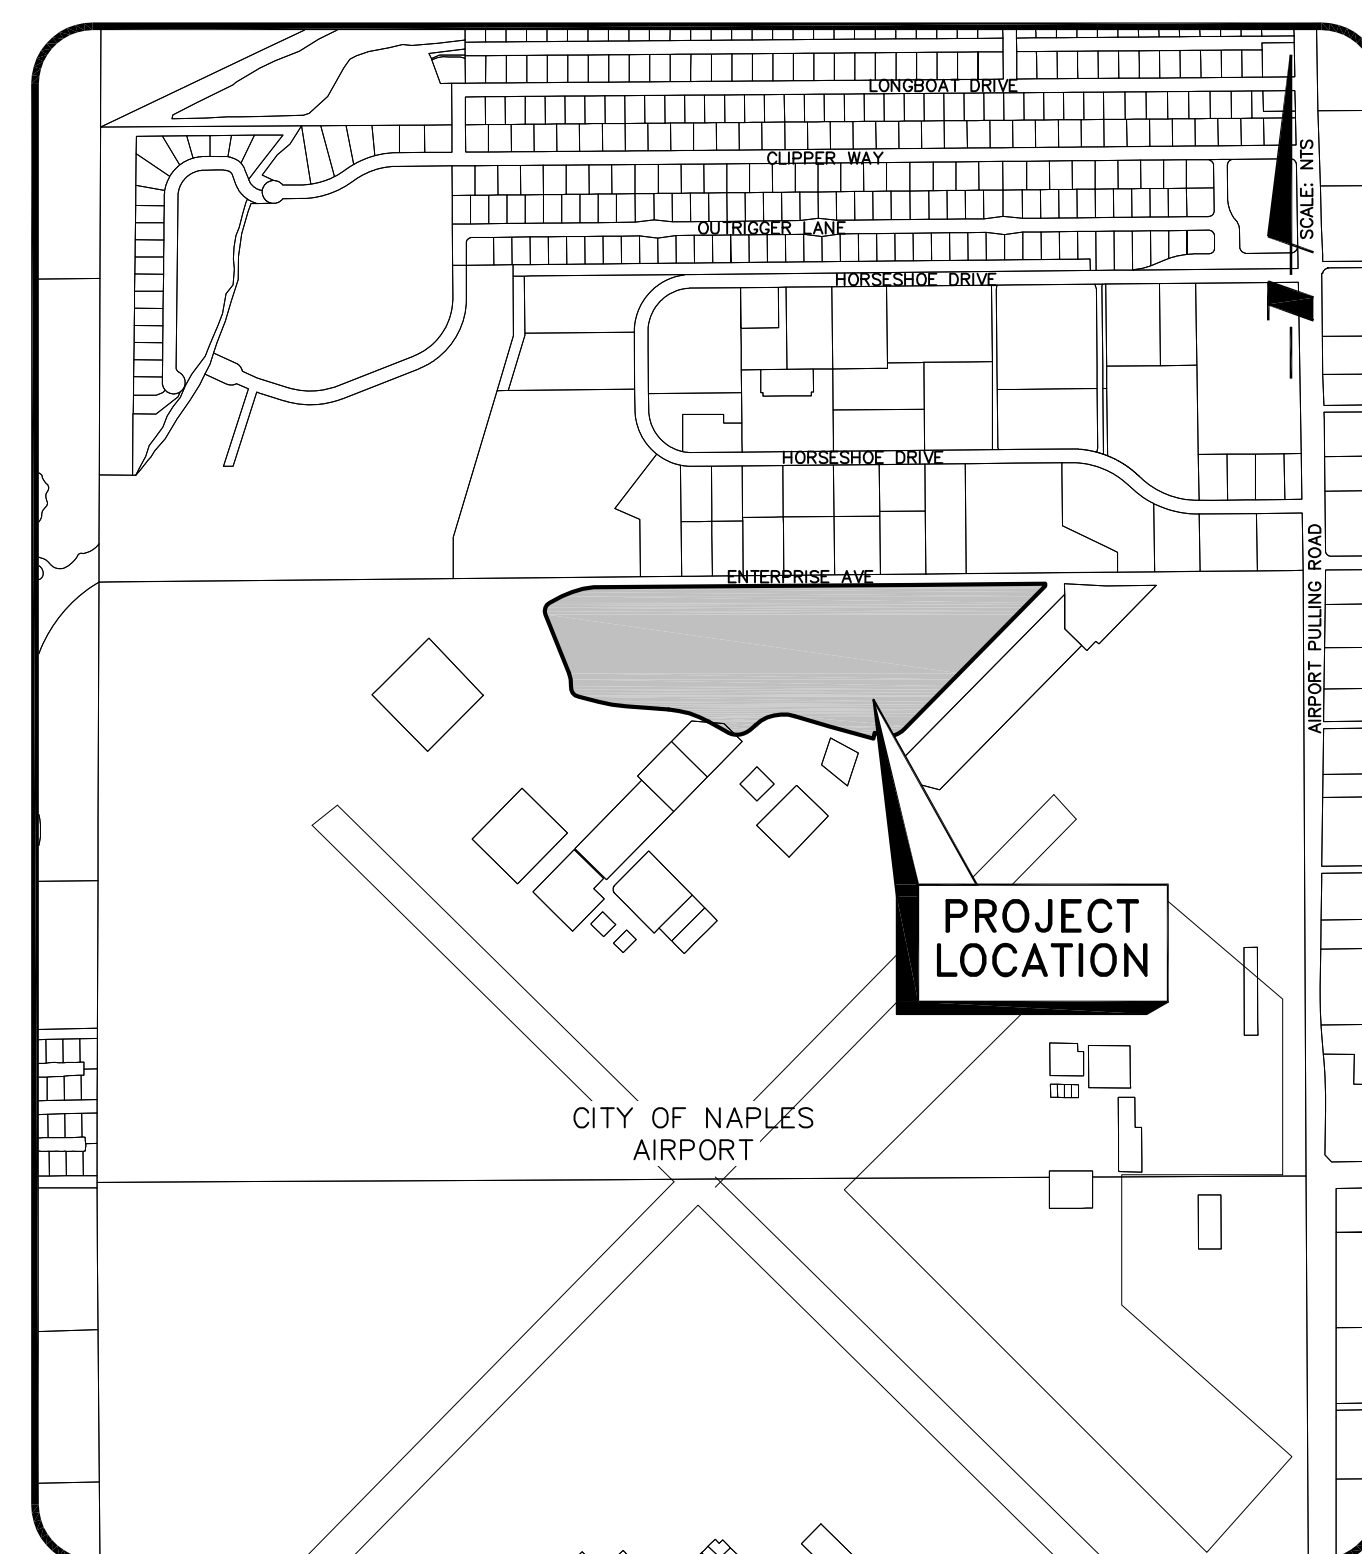

**LOCATION MAP**

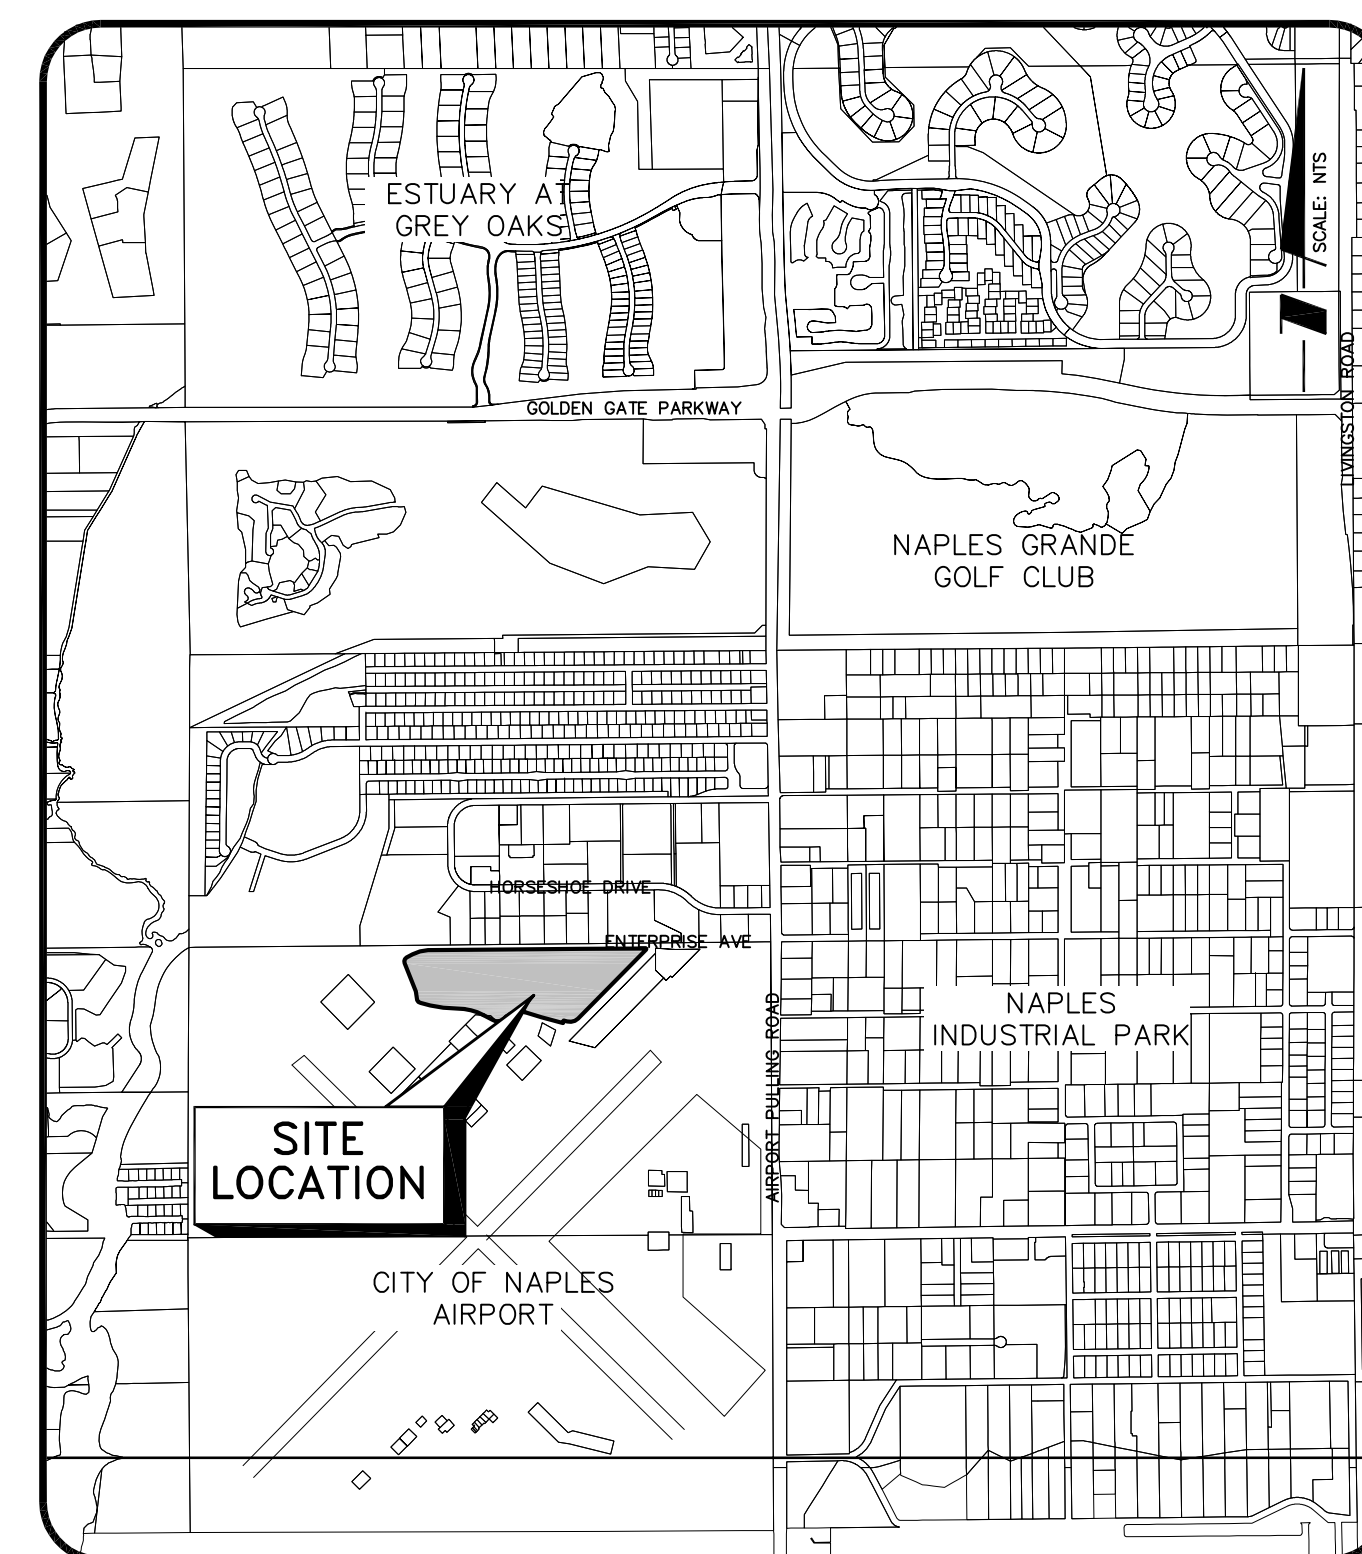

**SITE MAP**

SHEET NO.	DESCRIPTION
1	COVER SHEET
2	AERIAL WITH EXISTING CONDITIONS AND CLEARING PLAN
3	GENERAL, UTILITY, SITE DESIGN AND COORDINATION NOTES
4	OVERALL SITE PLAN
5	SITE PLAN - UTILITIES
6	SITE PLAN - DRAINAGE AND UNDERCUT EXCAVATION
7	SITE PLAN - PAVING AND GRADING (WEST)
8	SITE PLAN - PAVING AND GRADING (EAST)
9	PLAN AND PROFILE - EX. MH TO MH #2
10	PLAN AND PROFILE - WATER MAIN
11	CROSS SECTION MAP AND CROSS SECTIONS
12	DRAINAGE AND CONTROL STRUCTURE DETAILS
13	PAVING DETAILS
14	CITY OF NAPLES WATER UTILITY DETAILS
15	CITY OF NAPLES GENERAL UTILITY DETAILS
16	CITY OF NAPLES SANITARY SEWER AND IRRIGATION DETAILS
17	NPDES DISCHARGE CONTROL PLAN AND DETAILS

NO.	DATE	DESCRIPTION	BY

#### STATUS : REVISIONS

PROJECT DESIGNER <b>RAYMOND J. PIACENTE, III</b> P.M.P., LEED AP	PROJECT SURVEYOR <b>LANCE T. MILLER</b> P.S.M. #5627	PROJECT MANAGER <b>RAYMOND J. PIACENTE, III</b> P.M.P., LEED AP
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FOLIO #20764680005

**BIDDING PLANS ONLY  
NOT FOR CONSTRUCTION  
PERMITTING PROCESS  
INCOMPLETE**




3200 Bailey Lane, Suite 200 • Naples, Florida 34105-8507 • Phone 239-649-4040 • Fax 239-263-6494 • Web-Site www.stantec.com

RESERVED FOR STATUS AND DATE STAMPS DAVID S. WILSON LICENSE # 38871

PROJECT NUMBER <b>215610640</b>	<b>PRELIMINARY</b>
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DATE <b>MAY 2012</b>	INDEX NUMBER <b>215610640-001</b>
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EXISTING NAPLES BUSINESS PARK ZONING - BP

JOHNSON PIN AND CAP EL = 6.60 FT-NAVD-88 (BENCHMARK No. 1)

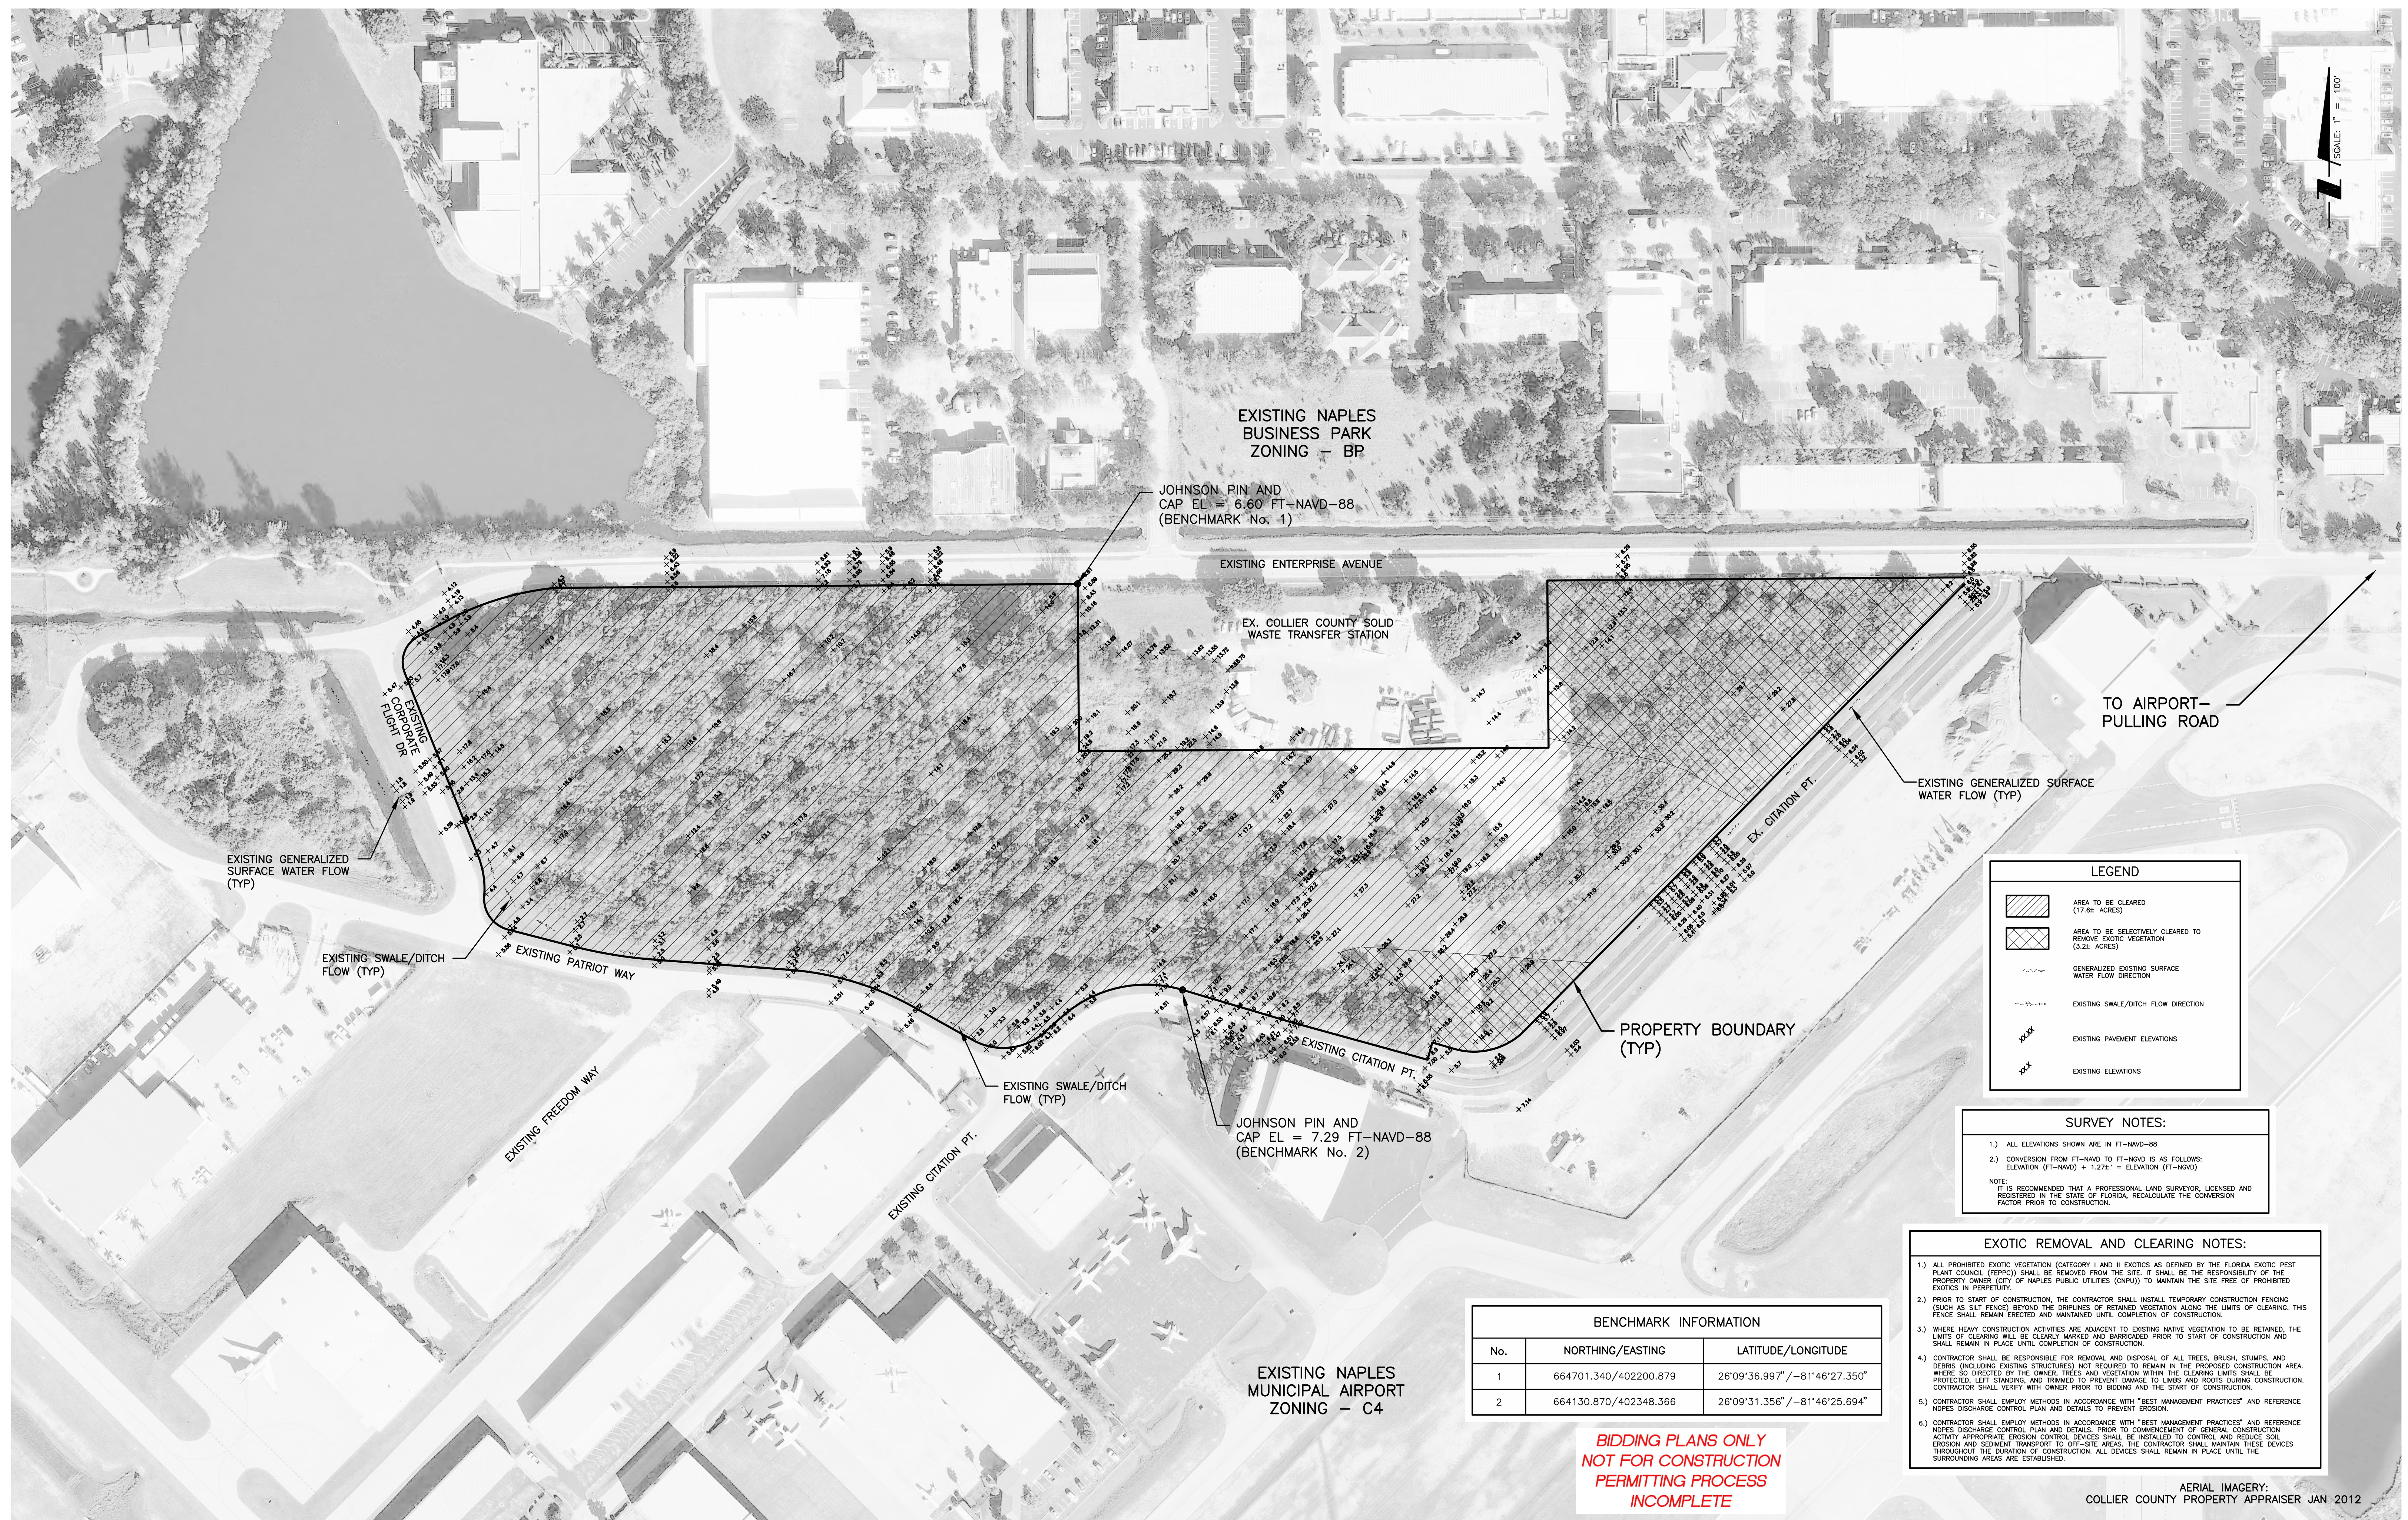EXISTING ENTERPRISE AVENUE

EX. COLLIER COUNTY SOLID WASTE TRANSFER STATION

TO AIRPORT - PULLING ROAD

EXISTING GENERALIZED SURFACE WATER FLOW (TYP)

EXISTING GENERALIZED SURFACE WATER FLOW (TYP)

EXISTING SWALE/DITCH FLOW (TYP)

EXISTING PATRIOT WAY

PROPERTY BOUNDARY (TYP)

EXISTING FREEDOM WAY

EXISTING SWALE/DITCH FLOW (TYP)

JOHNSON PIN AND CAP EL = 7.29 FT-NAVD-88 (BENCHMARK No. 2)

EXISTING CITATION PT.

EXISTING CITATION PT.

**LEGEND**

- AREA TO BE CLEARED (17.6± ACRES)
- AREA TO BE SELECTIVELY CLEARED TO REMOVE EXOTIC VEGETATION (3.2± ACRES)
- GENERALIZED EXISTING SURFACE WATER FLOW DIRECTION
- EXISTING SWALE/DITCH FLOW DIRECTION
- EXISTING PAVEMENT ELEVATIONS
- EXISTING ELEVATIONS

**SURVEY NOTES:**

- ALL ELEVATIONS SHOWN ARE IN FT-NAVD-88
- CONVERSION FROM FT-NAVD TO FT-NGVD IS AS FOLLOWS:  
ELEVATION (FT-NAVD) + 1.273' = ELEVATION (FT-NGVD)

NOTE:  
IT IS RECOMMENDED THAT A PROFESSIONAL LAND SURVEYOR, LICENSED AND REGISTERED IN THE STATE OF FLORIDA, RECALCULATE THE CONVERSION FACTOR PRIOR TO CONSTRUCTION.

**EXOTIC REMOVAL AND CLEARING NOTES:**

- ALL PROHIBITED EXOTIC VEGETATION (CATEGORY I AND II EXOTICS AS DEFINED BY THE FLORIDA EXOTIC PEST PLANT COUNCIL (FEPPC)) SHALL BE REMOVED FROM THE SITE. IT SHALL BE THE RESPONSIBILITY OF THE PROPERTY OWNER (CITY OF NAPLES PUBLIC UTILITIES (CNPUI)) TO MAINTAIN THE SITE FREE OF PROHIBITED EXOTICS IN PERPETUITY.
- PRIOR TO START OF CONSTRUCTION, THE CONTRACTOR SHALL INSTALL TEMPORARY CONSTRUCTION FENCING (SUCH AS SILT FENCE) BEYOND THE DRILLPILES OF RETAINED VEGETATION ALONG THE LIMITS OF CLEARING. THIS FENCE SHALL REMAIN ERECTED AND MAINTAINED UNTIL COMPLETION OF CONSTRUCTION.
- WHERE HEAVY CONSTRUCTION ACTIVITIES ARE ADJACENT TO EXISTING NATIVE VEGETATION TO BE RETAINED, THE LIMITS OF CLEARING WILL BE CLEARLY MARKED AND BARRICADED PRIOR TO START OF CONSTRUCTION AND SHALL REMAIN IN PLACE UNTIL COMPLETION OF CONSTRUCTION.
- CONTRACTOR SHALL BE RESPONSIBLE FOR REMOVAL AND DISPOSAL OF ALL TREES, BRUSH, STUMPS, AND DEBRIS (INCLUDING EXISTING STRUCTURES) NOT REQUIRED TO REMAIN IN THE PROPOSED CONSTRUCTION AREA. WHERE SO DIRECTED BY THE OWNER, TREES AND VEGETATION WITHIN THE CLEARING LIMITS SHALL BE PROTECTED, LEFT STANDING, AND TRIMMED TO PREVENT DAMAGE TO LIMBS AND ROOTS DURING CONSTRUCTION. CONTRACTOR SHALL VERIFY WITH OWNER PRIOR TO BIDDING AND THE START OF CONSTRUCTION.
- CONTRACTOR SHALL EMPLOY METHODS IN ACCORDANCE WITH "BEST MANAGEMENT PRACTICES" AND REFERENCE NOTES DISCHARGE CONTROL PLAN AND DETAILS TO PREVENT EROSION.
- CONTRACTOR SHALL EMPLOY METHODS IN ACCORDANCE WITH "BEST MANAGEMENT PRACTICES" AND REFERENCE NOTES DISCHARGE CONTROL PLAN AND DETAILS. PRIOR TO COMMENCEMENT OF GENERAL CONSTRUCTION ACTIVITY APPROPRIATE EROSION CONTROL DEVICES SHALL BE INSTALLED TO CONTROL AND REDUCE SOIL EROSION AND SEDIMENT TRANSPORT TO OFF-SITE AREAS. THE CONTRACTOR SHALL MAINTAIN THESE DEVICES THROUGHOUT THE DURATION OF CONSTRUCTION. ALL DEVICES SHALL REMAIN IN PLACE UNTIL THE SURROUNDING AREAS ARE ESTABLISHED.

**BENCHMARK INFORMATION**


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2	664130.870/402348.366	26°09'31.356" / -81°46'25.694"

**BIDDING PLANS ONLY  
NOT FOR CONSTRUCTION  
PERMITTING PROCESS  
INCOMPLETE**

AERIAL IMAGERY:  
COLLIER COUNTY PROPERTY APPRAISER JAN 2012

REV. NO.    REVISION DESCRIPTION _____ _____ _____	REV. DATE    DRAWN BY / EMP. NO. _____ _____	CITY:    COLLIER ISSUE DATE: ISSUE DESCRIPTION: _____ _____		CLIENT: CITY OF NAPLES CITY OF NAPLES RECYCLE TRANSFER FACILITY	PROJECT: _____ _____	PROJ. START DATE: MAY 2012 HORIZONTAL SCALE: 1" = 100' VERTICAL SCALE: N/A Copyright Wilson Miller Inc. 2009	TITLE: AERIAL WITH EXISTING CONDITIONS AND CLEARING PLAN	CROSS REF. NUMBER: _____ WILSONMILLER PROJECT NUMBER: 215610640	PRELIMINARY INDEX NUMBER: 215610640c-002aer SHEET NUMBER: 2 OF 17



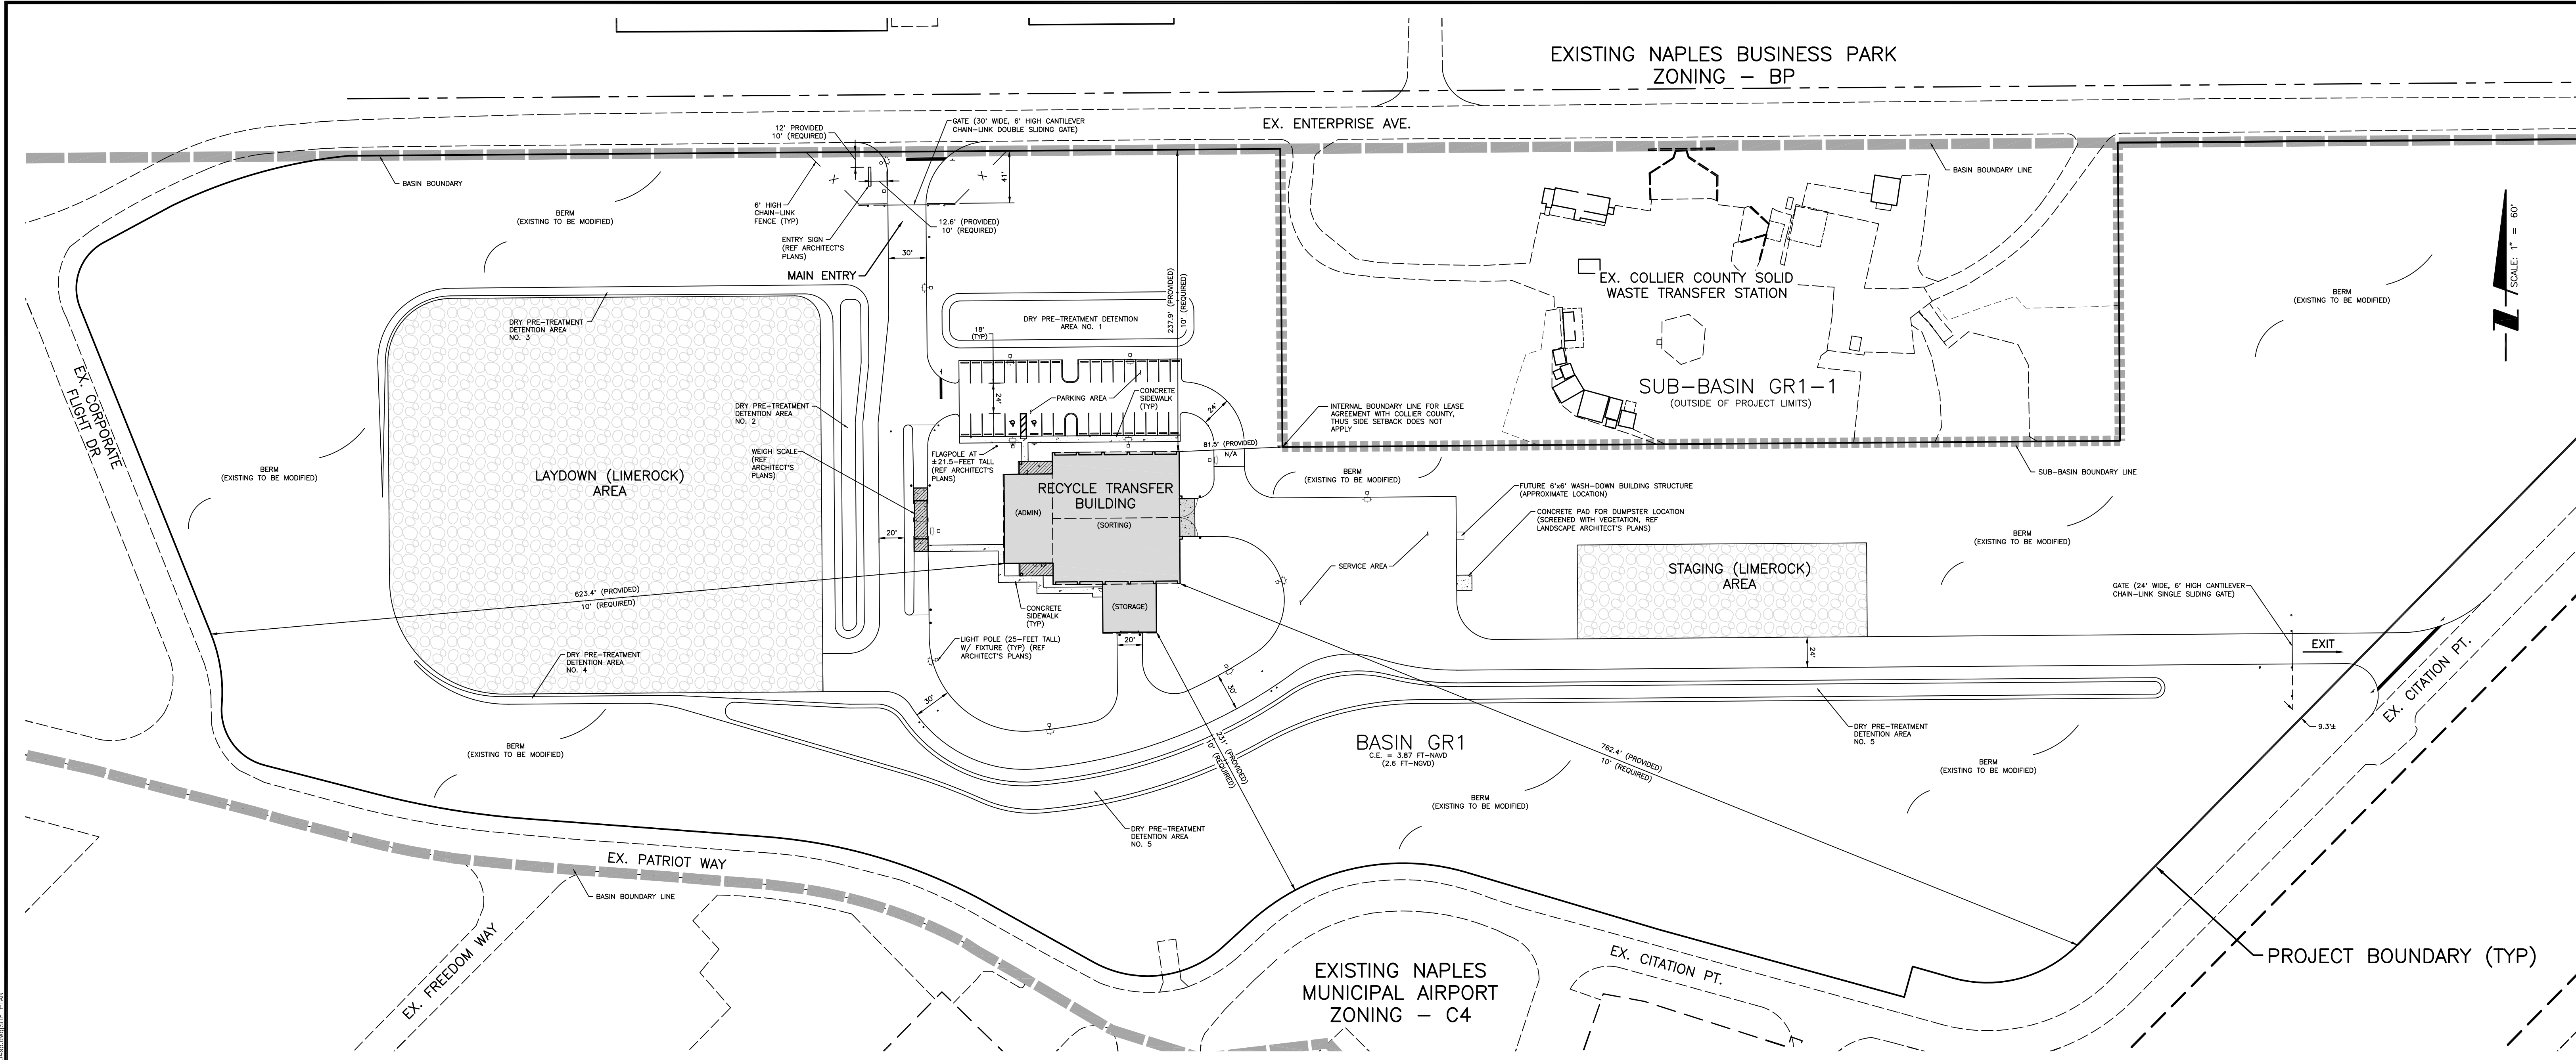

EXISTING NAPLES BUSINESS PARK ZONING - BP

EX. ENTERPRISE AVE.

EX. COLLIER COUNTY SOLID WASTE TRANSFER STATION

SUB-BASIN GR1-1 (OUTSIDE OF PROJECT LIMITS)

LAYDOWN (LIMEROCK) AREA

RECYCLE TRANSFER BUILDING (ADMIN) (SORTING)

STAGING (LIMEROCK) AREA

BASIN GR1 C.E. = 3.87 FT-NAVD (2.6 FT-NGVD)

EXISTING NAPLES MUNICIPAL AIRPORT ZONING - C4

PROJECT BOUNDARY (TYP)

**(1) WATER MANAGEMENT SUMMARY TABLE**

WATER MANAGEMENT PARAMETERS	BASIN GR1	
	NAVD	NGVD
CONTROL ELEVATION	3.87	2.6
10-YEAR, 1-DAY RAINFALL (INCHES)	6.8	
25-YEAR, 3-DAY RAINFALL (INCHES)	8.5	
100-YEAR, 1-DAY STORM STAGE ELEVATION	7.42	6.15
PEAK 25-YEAR, 3-DAY STORM STAGE ELEVATION	7.61	6.34
PEAK 25-YEAR, 3-DAY STORM DISCHARGE (GFS)	9.66	
PEAK 100-YEAR, 3-DAY ZERO DISCHARGE STORM STAGE ELEVATION	8.19	6.92
FEMA ELEVATION	ZONE X	
MINIMUM REQUIRED PARKING LOT ELEVATION	7.42	6.15
MINIMUM REQUIRED FINISHED FLOOR ELEVATION	9.57	8.30
MINIMUM PERMETER BERM ELEVATION (25-YEAR, 3-DAY PEAK STAGE)	7.61	6.34

NOTE: (1) SUB-BASIN GR1-1 HAS BEEN REVISED TO ONLY INCLUDE THE EXISTING COLLIER COUNTY SOLID WASTE TRANSFER STATION. THE PROPOSED PROJECT WILL LIE ENTIRELY IN BASIN GR1.

**DRY PRE-TREATMENT VOLUME CALCULATION**

DRY PRE-TREATMENT VOLUME PROVIDED = 39,231 CF  
 DRY PRE-TREATMENT VOLUME REQUIRED = 916,228 SF (TOTAL SITE AREA) X 0.5-INCHES = 38,176 CF

**DRY PRE-TREATMENT AREA SUMMARY TABLE**

DRY PRE-TREATMENT AREA NO.	BOTTOM AREA (SF)	TOP AREA (SF)	PROVIDED PRE-TREATMENT VOLUME (CF)
1	5,718 SF	7,450 SF	6,584 CF
2	3,209 SF	5,419 SF	4,314 CF
3	3,043 SF	5,530 SF	4,287 CF
4	1,813 SF	2,278 SF	2,046 CF
5	18,266 SF	25,735 SF	22,001 CF
TOTAL:			39,231 CF

**WATER MANAGEMENT LAND USE SUMMARY TABLE**

LAND USE	AREA (AC)
BUILDING COVERAGE (INCLUDES FUTURE WASH-DOWN BUILDING STRUCTURE)	0.35 AC
DRY DETENTION AREAS	1.07 AC
PAVEMENT/SIDEWALK/LAYDOWN & STAGING AREAS	4.74 AC
BERM/PERVIOUS/OPEN SPACE AREAS	14.87 AC
TOTAL:	21.03 AC

**(1) FIRE CODE BUILDING SUMMARY TABLE**

TYPE OF CONSTRUCTION: TYPE III-B  
 No. OF STORES: ONE  
 TOTAL SF UNDER ROOF: 15,196 SF  
 BASE NEEDED FIRE FLOW: 2,500 GPM  
 SPRINKLER SYSTEM: YES, QUICK RESPONSE HEADS  
 NEEDED FIRE FLOW (75% REDUCTION): 625 GPM

NOTE: (1) INFORMATION PROVIDED BY ARCHITECT, DISNEY AND ASSOCIATES, P.A.

**(1) REQUIRED ACCESSIBLE PARKING SUMMARY TABLE**

TOTAL PARKING	REQUIRED MINIMUM NUMBER OF ACCESSIBLE SPACES
1 TO 25	1
26 TO 50	2
51 TO 75	3
76 TO 100	4
101 TO 150	5
151 TO 200	6
201 TO 300	7
301 TO 400	8
401 TO 500	9
501 TO 1,000	2% OF TOTAL

**PARKING SUMMARY TABLE**

BUILDING	USE	# EMPLOYEES	(1) TOTAL REQUIRED PARKING 1 SPACE PER 2 EMPLOYEES	TOTAL PROVIDED PARKING SPACES	(2) REQUIRED ACCESSIBLE PARKING SPACES	PROVIDED ACCESSIBLE PARKING SPACES
RECYCLE TRANSFER BUILDING	INDUSTRIAL WAREHOUSE	26	13	35	2	2

NOTE: (1) PER DEPARTMENT OF JUSTICE ADA STANDARDS FOR ACCESSIBLE DESIGN, SEC. 4.1.2.

NOTE: (1) PER CITY OF NAPLES CODE OF ORDINANCE SEC. 50-104, 1 PARKING SPACE PER EVERY 2 EMPLOYEES.  
 (2) PER CITY OF NAPLES CODE OF ORDINANCE SEC. 50-103, 2 SPACES REQUIRED FOR 26-50 TOTAL SPACES PROVIDED.

**SITE LAND USE SUMMARY TABLE**

CATEGORY	SQUARE FOOTAGE	ACREAGE	PERCENTAGE OF TOTAL
IMPERVIOUS AREAS:			
BUILDING/ROOF	15,196 SF	0.35 AC	1.7%
PAVEMENT/SIDEWALK	84,333 SF	1.94 AC	9.2%
LAYDOWN/STAGING	120,940 SF	2.78 AC	13.2%
PERVIOUS AREAS:			
OPEN SPACE	695,759 SF	15.96 AC	75.0%
TOTAL:	916,228 SF	21.03 AC	100%

**ZONING SUMMARY TABLE**

1.) CURRENT ZONING: CITY OF NAPLES - C4 AIRPORT COMMERCIAL  
 THE C4 DISTRICT IS A LIMITED COMMERCIAL ZONE DISTRICT INTENDED TO ACCOMMODATE ONLY THE NAPLES MUNICIPAL AIRPORT, ITS RELATED COMMERCIAL AND LIGHT INDUSTRIAL USES, RELATED SERVICE FACILITIES, AND A LIMITED RANGE OF NON-AIRPORT RELATED COMMERCIAL USES.


2.) ADJACENT ZONING:  
 NORTH = CITY OF NAPLES ZONING BP (BUSINESS PARK)  
 SOUTH = CITY OF NAPLES ZONING C4 (AIRPORT COMMERCIAL)  
 EAST = CITY OF NAPLES ZONING C4 (AIRPORT COMMERCIAL)  
 WEST = CITY OF NAPLES ZONING C4 (AIRPORT COMMERCIAL)

**(4) SETBACK TABLE TABLE**

BLDG#	REQUIRED SETBACK				PROVIDED SETBACK			
	FRONT	REAR	SIDE	MAX. HEIGHT	FRONT	REAR	SIDE	HEIGHT
RECYCLE TRANSFER BUILDING	(1) 10'	25'	10'	(3) 42'	(2) 237.9'	231'	623.4'	33'

NOTE: (1) PER CITY OF NAPLES CODE OF ORDINANCE SEC. 44-8, DEFINITIONS (D0 44.15), ALL SIDES OF THE PROPERTY ABUT A STREET OR AVENUE, THEREFORE ALL SIDES ARE CONSIDERED FRONT YARDS.  
 (2) PROVIDED FRONT SETBACK REPRESENTS THE MINIMUM DISTANCE FROM THE RECYCLE TRANSFER FACILITY TO THE CLOSEST PROPERTY BOUNDARY LINE.  
 (3) BUILDING HEIGHT IS MEASURED AS THE VERTICAL DISTANCE FROM THE FEMA 1ST HABITABLE FLOOR HEIGHT REQUIREMENT TO THE PEAK OF THE ROOF OR THE HIGHEST POINT OF ANY APPURTENANCE ATTACHED TO THE ROOF, PER CITY OF NAPLES CODE OF ORDINANCE SEC. 44-8, DEFINITIONS.  
 (4) FENCES, BERMED EARTH, PLANT MATERIALS, DRIVEWAY CONNECTIONS ARE NOT SUBJECT TO SETBACK REQUIREMENTS, PER CITY OF NAPLES CODE OF ORDINANCE SEC. 56-54.

**BIDDING PLANS ONLY  
 NOT FOR CONSTRUCTION  
 PERMITTING PROCESS  
 INCOMPLETE**

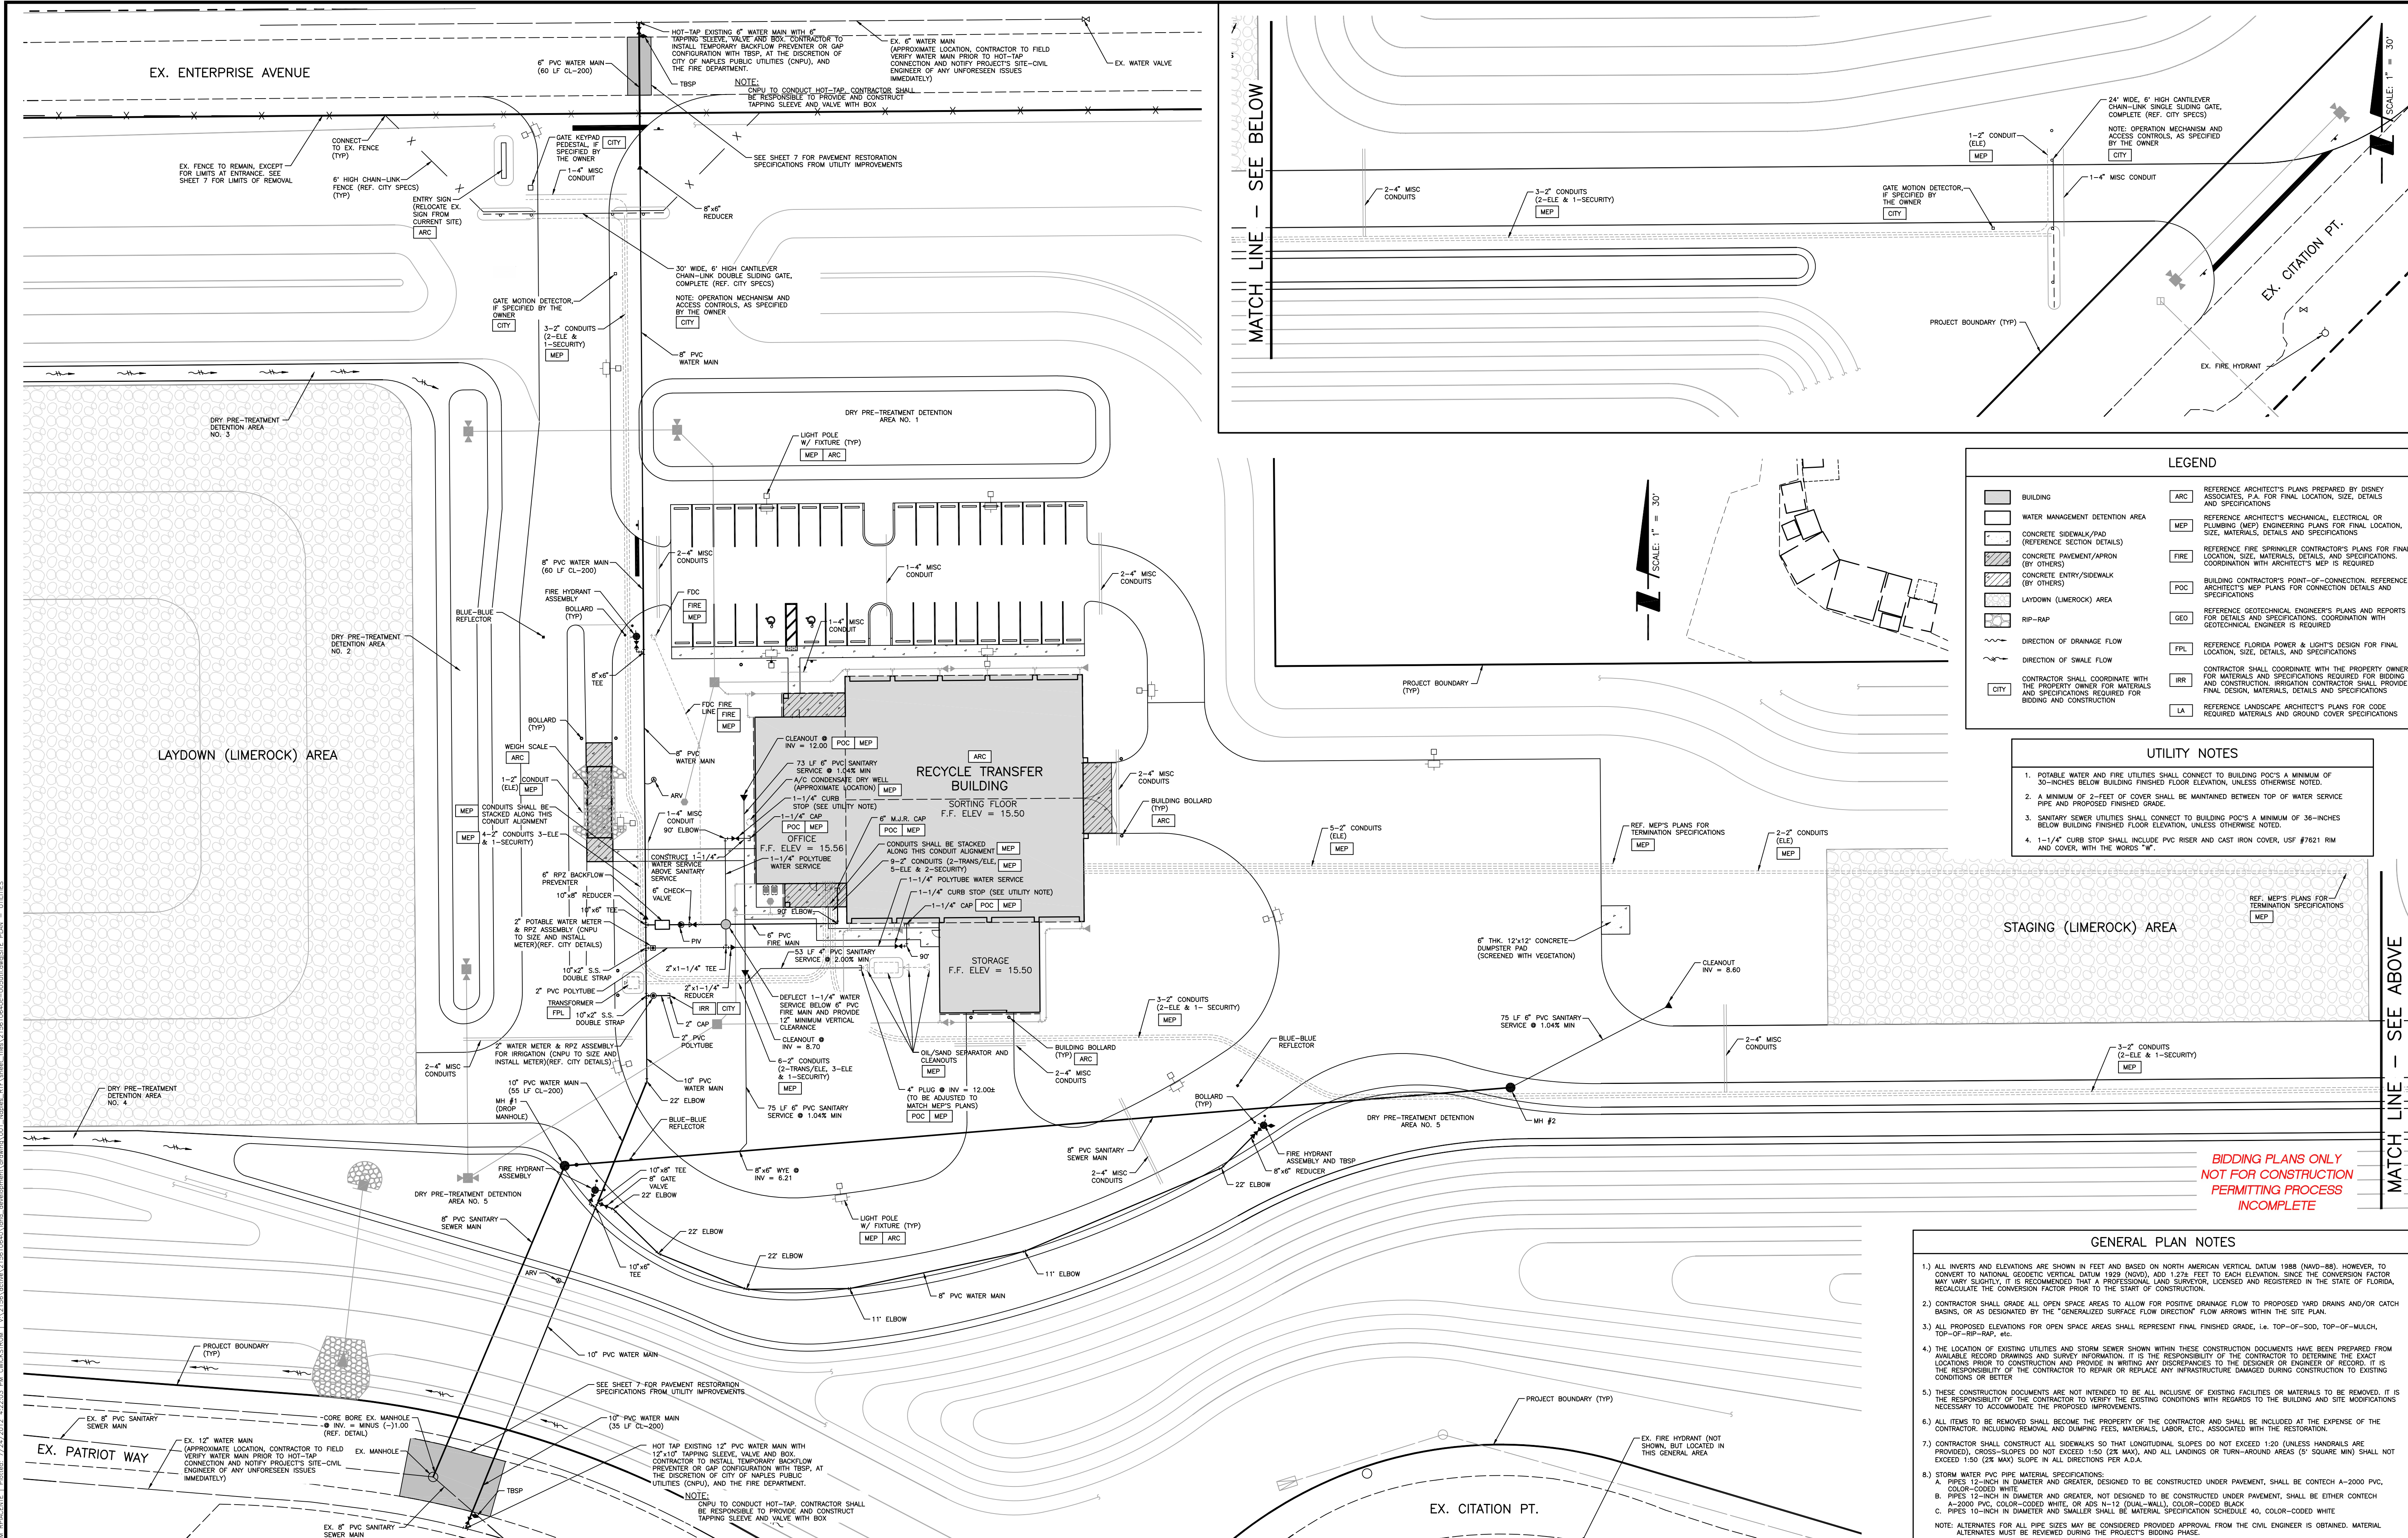

**LEGEND**

[Symbol]	BUILDING	[Symbol]	REFERENCE ARCHITECT'S PLANS PREPARED BY DESNY ASSOCIATES, P.A. FOR FINAL LOCATION, SIZE, DETAILS AND SPECIFICATIONS
[Symbol]	WATER MANAGEMENT DETENTION AREA	[Symbol]	REFERENCE ARCHITECT'S MECHANICAL, ELECTRICAL OR PLUMBING (MEP) ENGINEERING PLANS FOR FINAL LOCATION, SIZE, MATERIALS, DETAILS AND SPECIFICATIONS
[Symbol]	CONCRETE SIDEWALK/PAD (REFERENCE SECTION DETAILS)	[Symbol]	REFERENCE FIRE SPRINKLER CONTRACTOR'S PLANS FOR FINAL LOCATION, SIZE, MATERIALS, DETAILS, AND SPECIFICATIONS. COORDINATION WITH ARCHITECT'S MEP IS REQUIRED.
[Symbol]	CONCRETE PAVEMENT/APRON (BY OTHERS)	[Symbol]	BUILDING CONTRACTOR'S POINT-OF-CONNECTION. REFERENCE ARCHITECT'S MEP PLANS FOR CONNECTION DETAILS AND SPECIFICATIONS
[Symbol]	CONCRETE ENTRY/SIDEWALK (BY OTHERS)	[Symbol]	REFERENCE GEOTECHNICAL ENGINEER'S PLANS AND REPORTS FOR DETAILS AND SPECIFICATIONS. COORDINATION WITH GEOTECHNICAL ENGINEER IS REQUIRED
[Symbol]	LAYDOWN (LIMEROCK) AREA	[Symbol]	REFERENCE FLORIDA POWER & LIGHTS DESIGN FOR FINAL LOCATION, SIZE, DETAILS, AND SPECIFICATIONS
[Symbol]	RIP-RAP	[Symbol]	CONTRACTOR SHALL COORDINATE WITH THE PROPERTY OWNER FOR MATERIALS AND SPECIFICATIONS REQUIRED FOR BIDDING AND CONSTRUCTION. IRRIGATION CONTRACTOR SHALL PROVIDE FINAL DESIGN, MATERIALS, DETAILS AND SPECIFICATIONS
[Symbol]	DIRECTION OF DRAINAGE FLOW	[Symbol]	REFERENCE LANDSCAPE ARCHITECT'S PLANS FOR CODE REQUIRED MATERIALS AND GROUND COVER SPECIFICATIONS
[Symbol]	DIRECTION OF SWALE FLOW		
[Symbol]	CITY		




- UTILITY NOTES**
- POTABLE WATER AND FIRE UTILITIES SHALL CONNECT TO BUILDING POC'S A MINIMUM OF 30-INCHES BELOW BUILDING FINISHED FLOOR ELEVATION, UNLESS OTHERWISE NOTED.
  - A MINIMUM OF 2'-FEET OF COVER SHALL BE MAINTAINED BETWEEN TOP OF WATER SERVICE PIPE AND PROPOSED FINISHED GRADE.
  - SANITARY SEWER UTILITIES SHALL CONNECT TO BUILDING POC'S A MINIMUM OF 36-INCHES BELOW BUILDING FINISHED FLOOR ELEVATION, UNLESS OTHERWISE NOTED.
  - 1-1/4" CURB STOP SHALL INCLUDE PVC RISER AND CAST IRON COVER, USF #7621 RIM AND COVER, WITH THE WORDS "W".

**BIDDING PLANS ONLY  
NOT FOR CONSTRUCTION  
PERMITTING PROCESS  
INCOMPLETE**

- GENERAL PLAN NOTES**
- ALL INVERTS AND ELEVATIONS ARE SHOWN IN FEET AND BASED ON NORTH AMERICAN VERTICAL DATUM 1988 (NAVD-88). HOWEVER, TO CONVERT TO NATIONAL GEODETIC VERTICAL DATUM 1929 (NGVD), ADD 1.278 FEET TO EACH ELEVATION. SINCE THE CONVERSION FACTOR MAY VARY SLIGHTLY, IT IS RECOMMENDED THAT A PROFESSIONAL LAND SURVEYOR, LICENSED AND REGISTERED IN THE STATE OF FLORIDA, RECALCULATE THE CONVERSION FACTOR PRIOR TO THE START OF CONSTRUCTION.
  - CONTRACTOR SHALL GRADE ALL OPEN SPACE AREAS TO ALLOW FOR POSITIVE DRAINAGE FLOW TO PROPOSED YARD DRAINS AND/OR CATCH BASINS, OR AS DESIGNATED BY THE "GENERALIZED SURFACE FLOW DIRECTION" FLOW ARROWS WITHIN THE SITE PLAN.
  - ALL PROPOSED ELEVATIONS FOR OPEN SPACE AREAS SHALL REPRESENT FINAL FINISHED GRADE, I.E. TOP-OF-SOD, TOP-OF-MULCH, TOP-OF-RIP-RAP, ETC.
  - THE LOCATION OF EXISTING UTILITIES AND STORM SEWER SHOWN WITHIN THESE CONSTRUCTION DOCUMENTS HAVE BEEN PREPARED FROM AVAILABLE RECORD DRAWINGS AND SURVEY INFORMATION. IT IS THE RESPONSIBILITY OF THE CONTRACTOR TO DETERMINE THE EXACT LOCATIONS PRIOR TO CONSTRUCTION AND TO NOTIFY THE DESIGNER OR ENGINEER OF RECORD. IT IS THE RESPONSIBILITY OF THE CONTRACTOR TO REPAIR OR REPLACE ANY INFRASTRUCTURE DAMAGED DURING CONSTRUCTION TO EXISTING CONDITIONS OR BETTER.
  - THESE CONSTRUCTION DOCUMENTS ARE NOT INTENDED TO BE ALL INCLUSIVE OF EXISTING FACILITIES OR MATERIALS TO BE REMOVED. IT IS THE RESPONSIBILITY OF THE CONTRACTOR TO VERIFY THE EXISTING CONDITIONS WITH REGARDS TO THE BUILDING AND SITE MODIFICATIONS NECESSARY TO ACCOMMODATE THE PROPOSED IMPROVEMENTS.
  - ALL ITEMS TO BE REMOVED SHALL BECOME THE PROPERTY OF THE CONTRACTOR AND SHALL BE INCLUDED AT THE EXPENSE OF THE CONTRACTOR, INCLUDING REMOVAL AND DUMPING FEES, MATERIALS, LABOR, ETC., ASSOCIATED WITH THE RESTORATION.
  - CONTRACTOR SHALL CONSTRUCT ALL SIDEWALKS SO THAT LONGITUDINAL SLOPES DO NOT EXCEED 1:20 (UNLESS HANDRAILS ARE PROVIDED), CROSS-SLOPES DO NOT EXCEED 1:50 (2% MAX), AND ALL LANDINGS OR TURN-AROUND AREAS (5' SQUARE MIN) SHALL NOT EXCEED 1:50 (2% MAX) SLOPE IN ALL DIRECTIONS PER A.S.A.
  - STORM WATER PVC PIPE MATERIAL SPECIFICATIONS:
    - PIPES 12-INCH IN DIAMETER AND GREATER, DESIGNED TO BE CONSTRUCTED UNDER PAVEMENT, SHALL BE CONTECH A-2000 PVC, COLOR-CODED WHITE.
    - PIPES 12-INCH IN DIAMETER AND GREATER, NOT DESIGNED TO BE CONSTRUCTED UNDER PAVEMENT, SHALL BE EITHER CONTECH A-2000 PVC, COLOR-CODED WHITE, OR ADS N-12 (DUAL-WALL), COLOR-CODED BLACK.
    - PIPES 10-INCH IN DIAMETER AND SMALLER SHALL BE MATERIAL SPECIFICATION SCHEDULE 40, COLOR-CODED WHITE.
 NOTE: ALTERNATES FOR ALL PIPE SIZES MAY BE CONSIDERED PROVIDED APPROVAL FROM THE CIVIL ENGINEER IS OBTAINED. MATERIAL ALTERNATES MUST BE REVIEWED DURING THE PROJECT'S BIDDING PHASE.

<p>REV. NO.    REVISION DESCRIPTION</p>	<p>DATE    DRAWN BY / D.P. NO.</p>	<p>CITY:    COLLIER</p> <p>ISSUE DATE:    MAY 2012</p> <p>ISSUE DESCRIPTION:    2, 505, 25E</p> <p>LEAD DESIGNER:    CMW/89458</p> <p>LEAD TECHNICIAN:    CMW/89458</p>	<p>CLIENT:    CITY OF NAPLES</p> <p>PROJECT:    CITY OF NAPLES RECYCLE TRANSFER FACILITY</p>	<p>PROJ. START DATE:    MAY 2012</p> <p>HORIZONTAL SCALE:    1" = 30'</p> <p>VERTICAL SCALE:    N/A</p> <p>CROSS REF. NUMBER:    ---</p> <p>WILSONMILLER PROJECT NUMBER:    215610640</p>	<p>TITLE:    SITE PLAN - UTILITIES</p> <p>PRELIMINARY</p> <p>INDEX NUMBER:    215610640c-005util</p> <p>SHEET NUMBER:    5 OF 17</p>
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**STORM WATER PVC PIPE NOTES**

STORM WATER PVC PIPE MATERIAL SPECIFICATIONS:

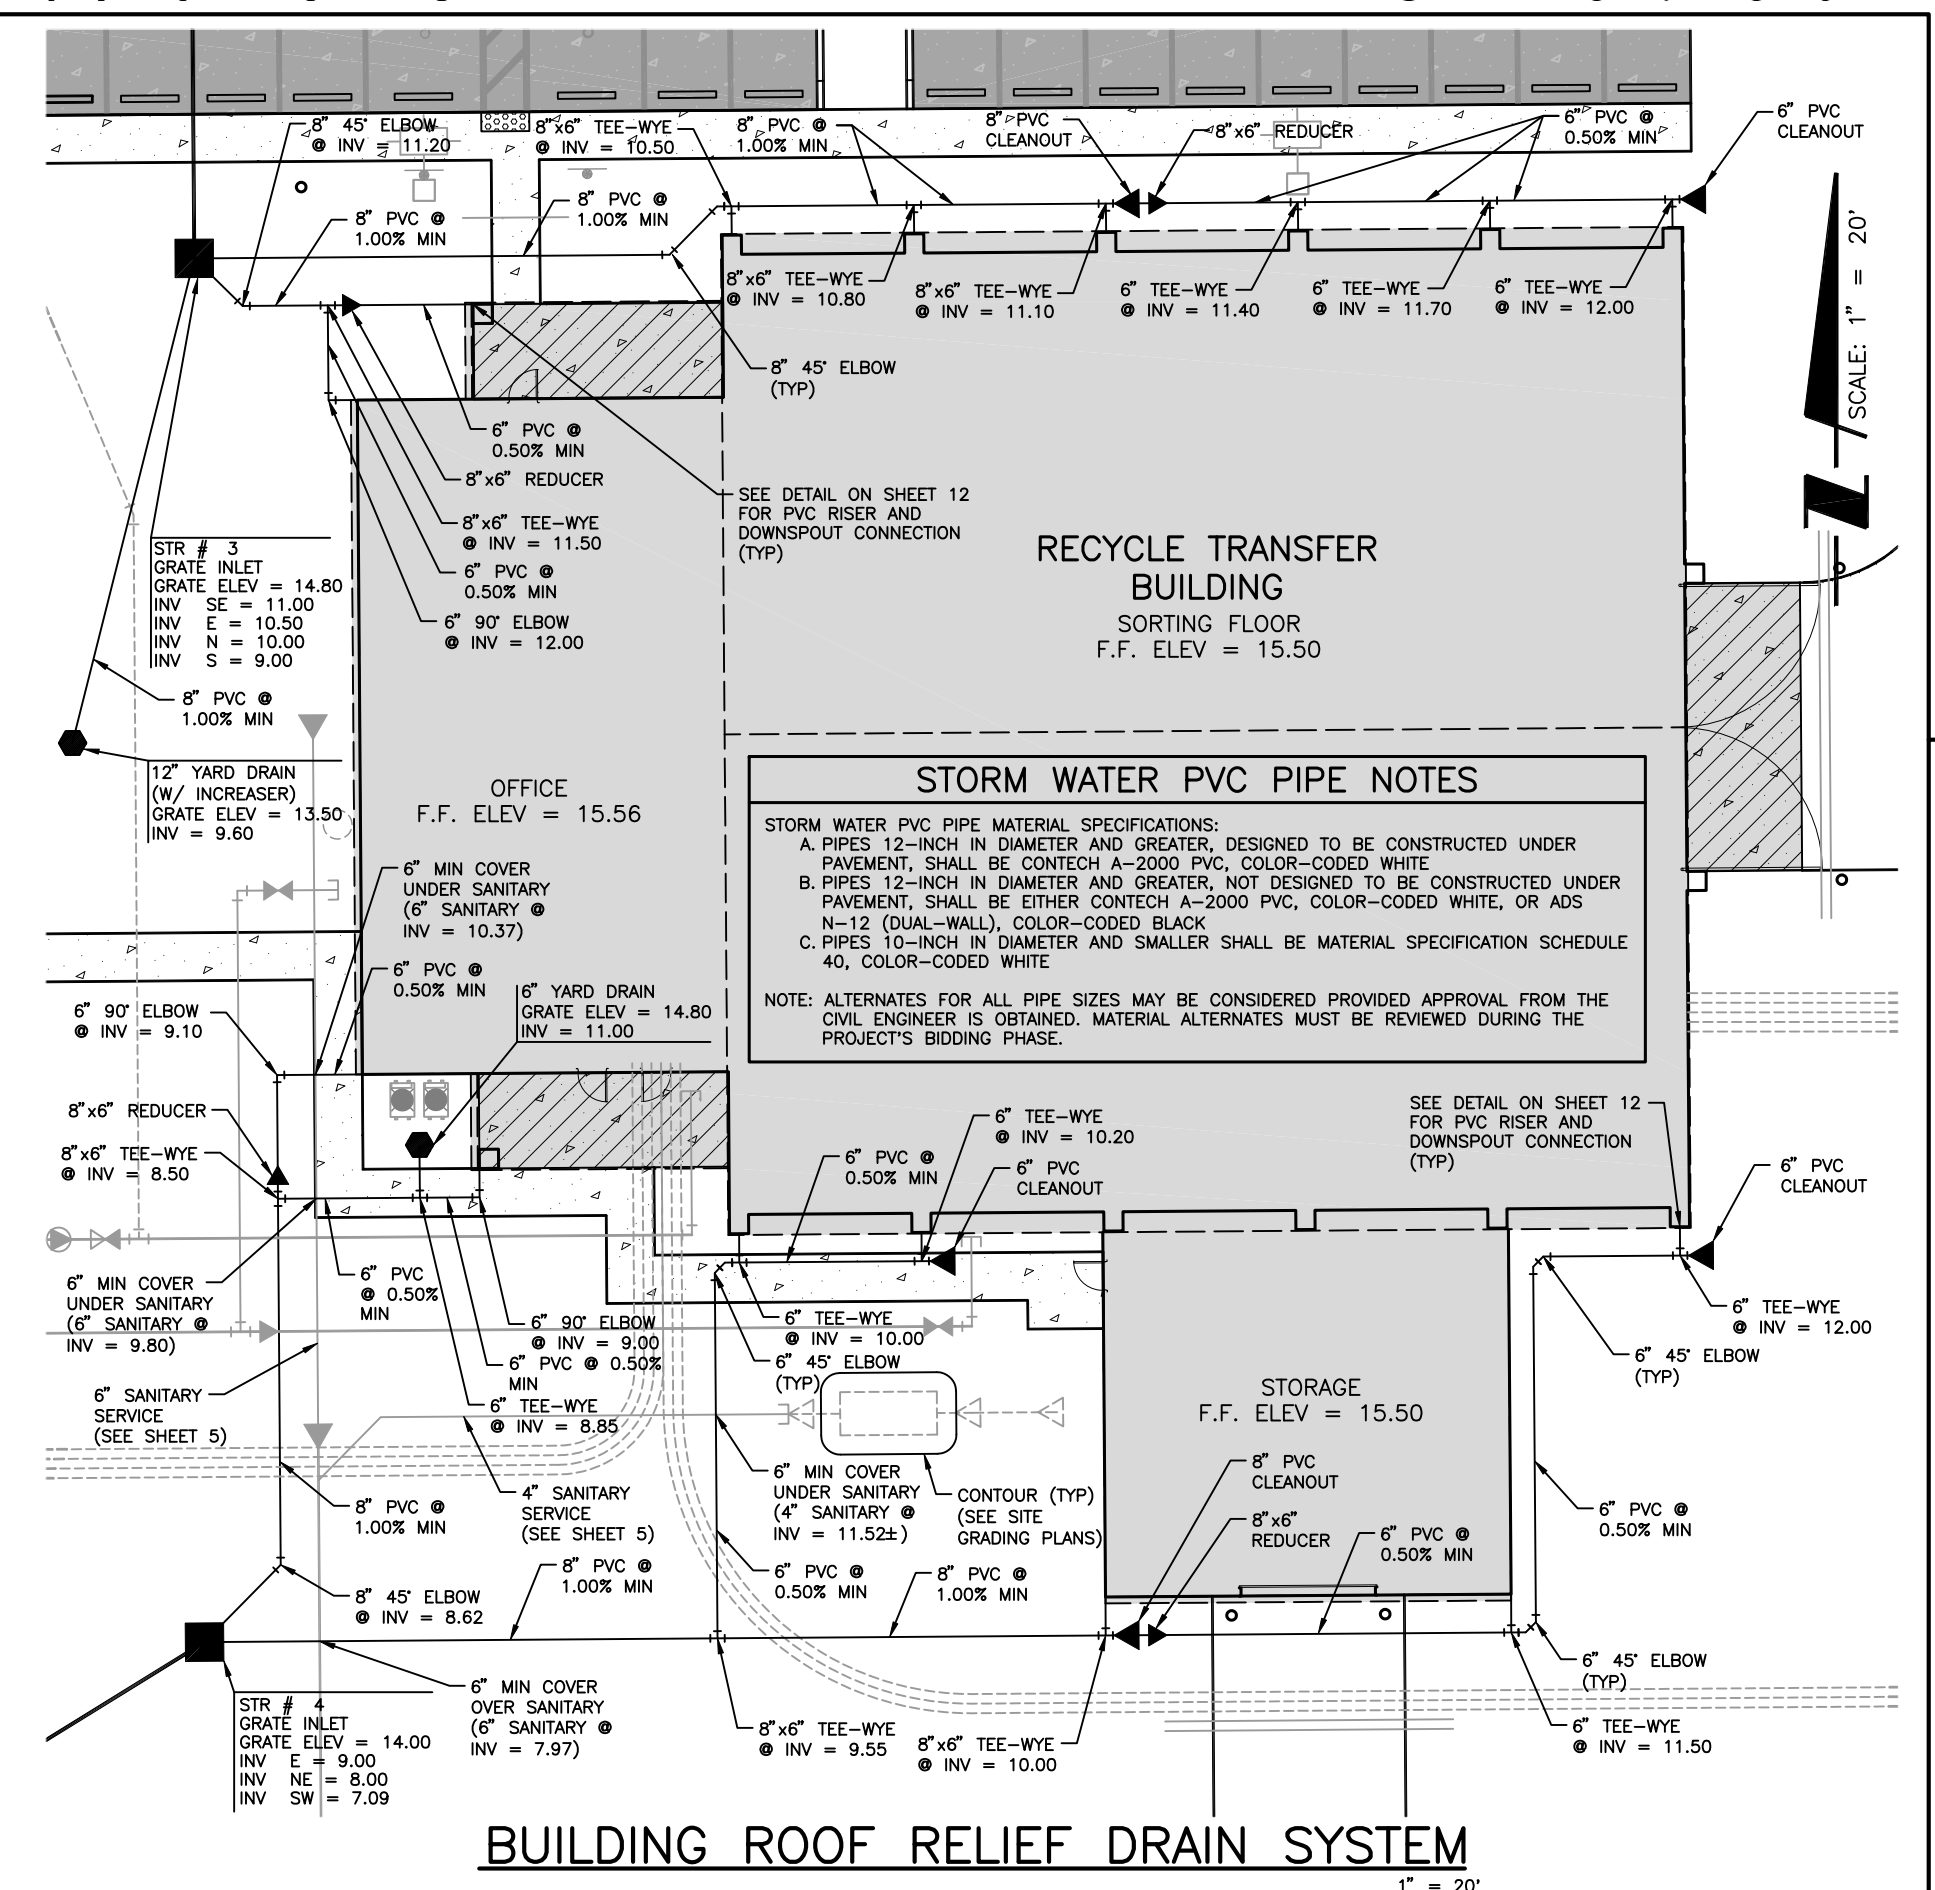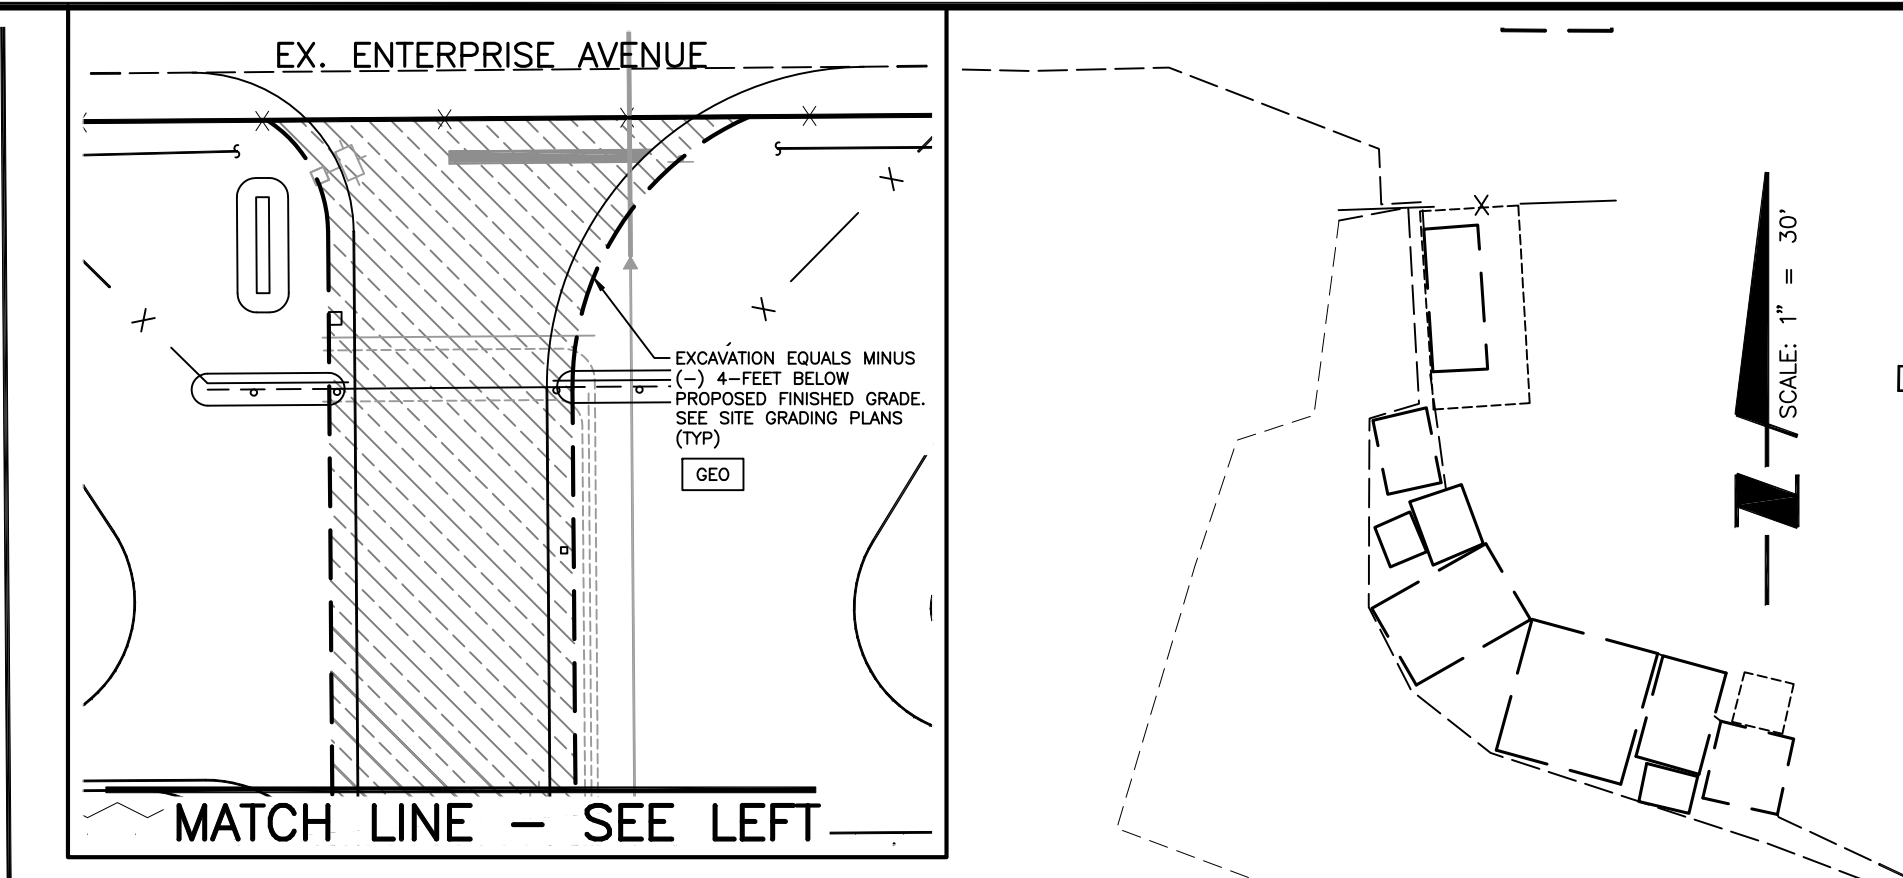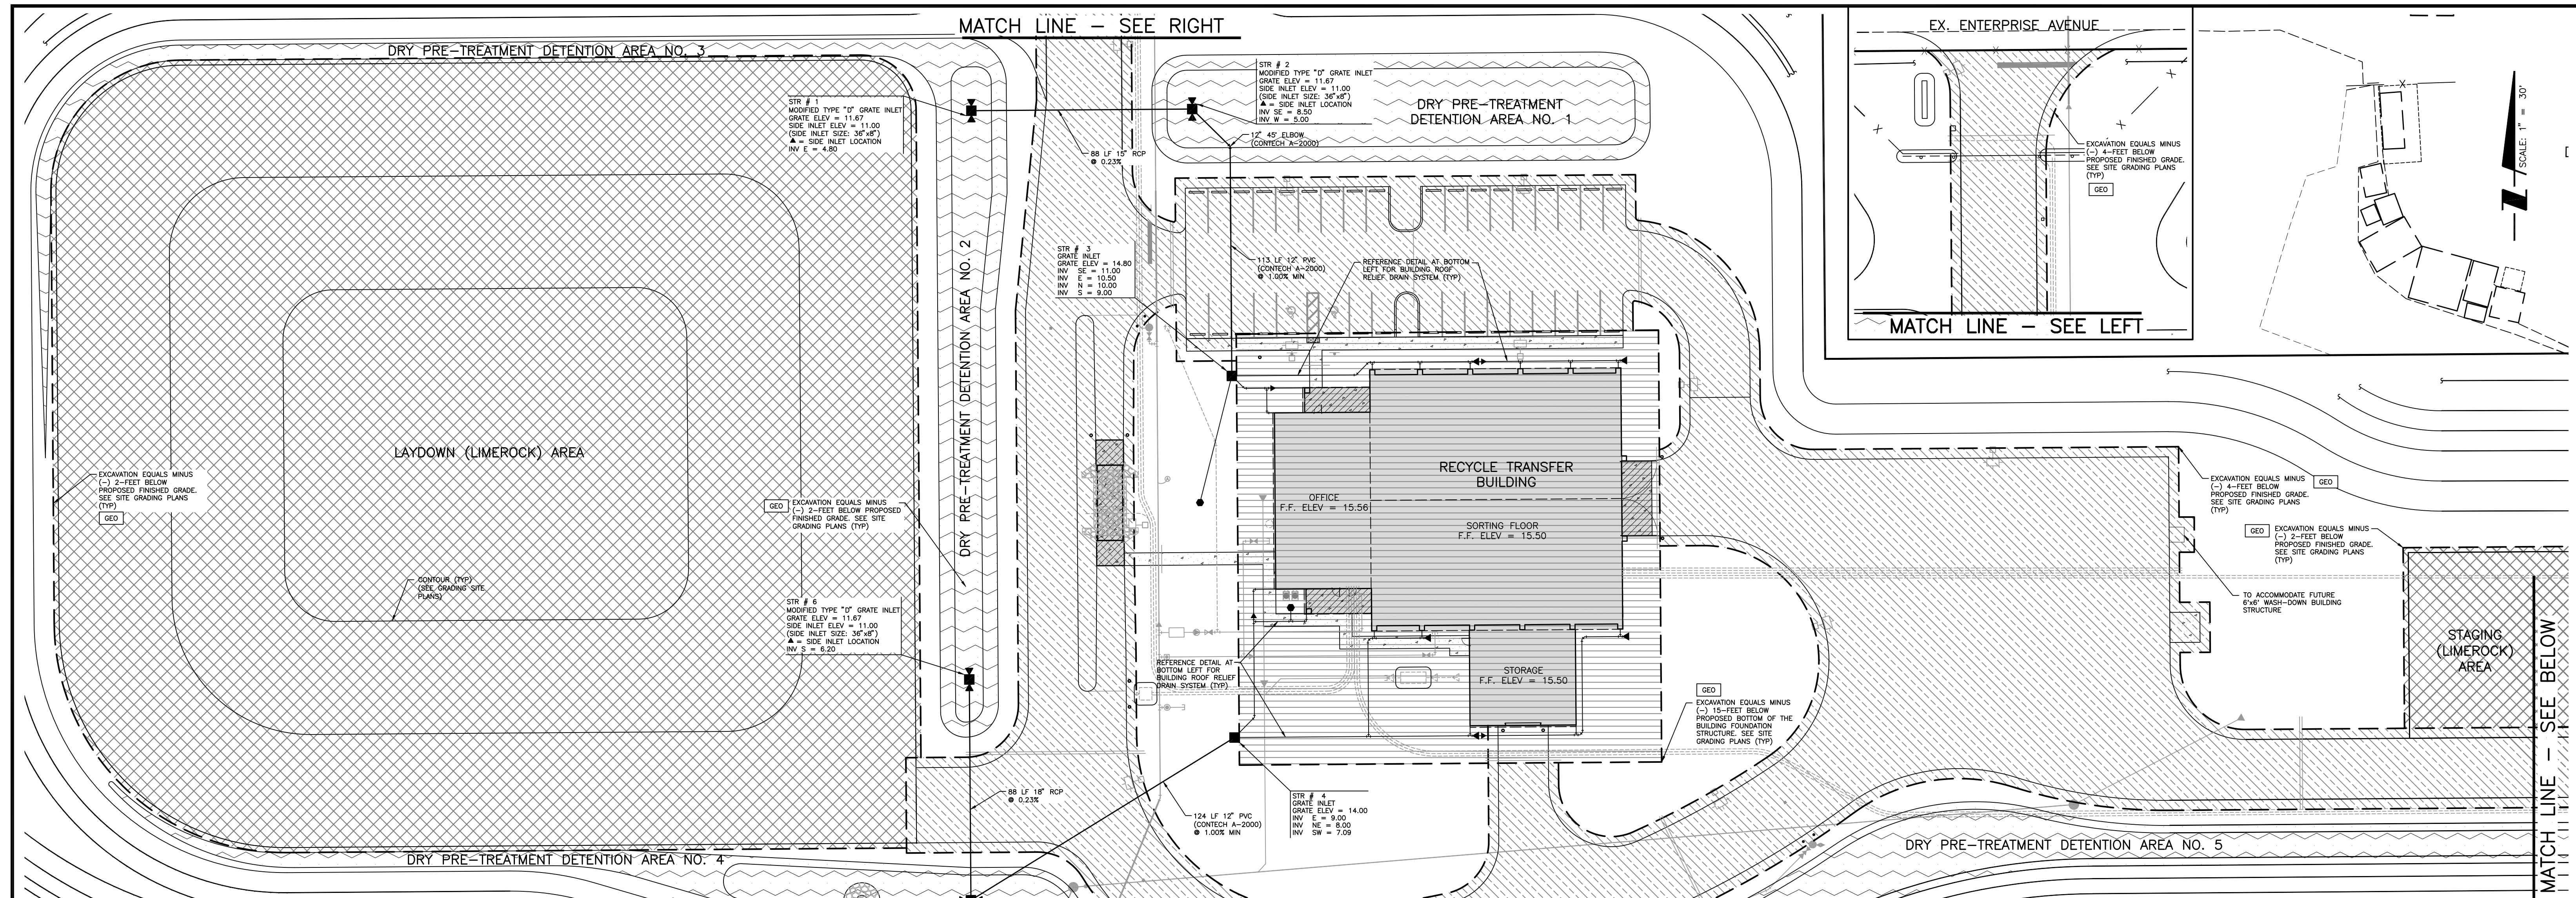A. PIPES 12-INCH IN DIAMETER AND GREATER, DESIGNED TO BE CONSTRUCTED UNDER PAVEMENT, SHALL BE CONTECH A-2000 PVC, COLOR-CODED WHITE.

B. PIPES 12-INCH IN DIAMETER AND GREATER, NOT DESIGNED TO BE CONSTRUCTED UNDER PAVEMENT, SHALL BE EITHER CONTECH A-2000 PVC, COLOR-CODED WHITE, OR A-12 (DUAL-WALL), COLOR-CODED BLACK.


C. PIPES 10-INCH IN DIAMETER AND SMALLER SHALL BE MATERIAL SPECIFICATION SCHEDULE 40, COLOR-CODED WHITE.

NOTE: ALTERNATES FOR ALL PIPE SIZES MAY BE CONSIDERED PROVIDED APPROVAL FROM THE CIVIL ENGINEER IS OBTAINED. MATERIAL ALTERNATES MUST BE REVIEWED DURING THE PROJECT'S BIDDING PHASE.

**UNDERCUT AREAS LEGEND**

[Symbol]	ADMINISTRATION/SORTING/STORAGE BUILDING FOUNDATION STRUCTURE UNDERCUT AREA. REF. SITE DESIGN AND COORDINATION NOTE # 7.0 ON SHEET 3 AND SECTION DETAIL ON SHEET 13.
[Symbol]	VEHICULAR USE AND PARKING ASLE/STALL AND FUTURE WASH-DOWN BUILDING FOUNDATION UNDERCUT AREAS. REF. SITE DESIGN AND COORDINATION NOTE # 7.0 ON SHEET 3 AND SECTION DETAIL ON SHEET 13.
[Symbol]	VEHICULAR STAGING AND LAYDOWN UNDERCUT AREAS. REF. SITE DESIGN AND COORDINATION NOTE # 7.0 ON SHEET 3 AND SECTION DETAIL ON SHEET 13.
[Symbol]	WATER MANAGEMENT DRY PRE-TREATMENT DETENTION UNDERCUT AREAS. REF. SITE DESIGN AND COORDINATION NOTE # 7.0 ON SHEET 3 AND SECTION DETAIL ON SHEET 13.

REFERENCE GEOTECHNICAL ENGINEER'S PLANS AND REPORTS FOR DETAILS AND SPECIFICATIONS. COORDINATION WITH GEOTECHNICAL ENGINEER IS REQUIRED.

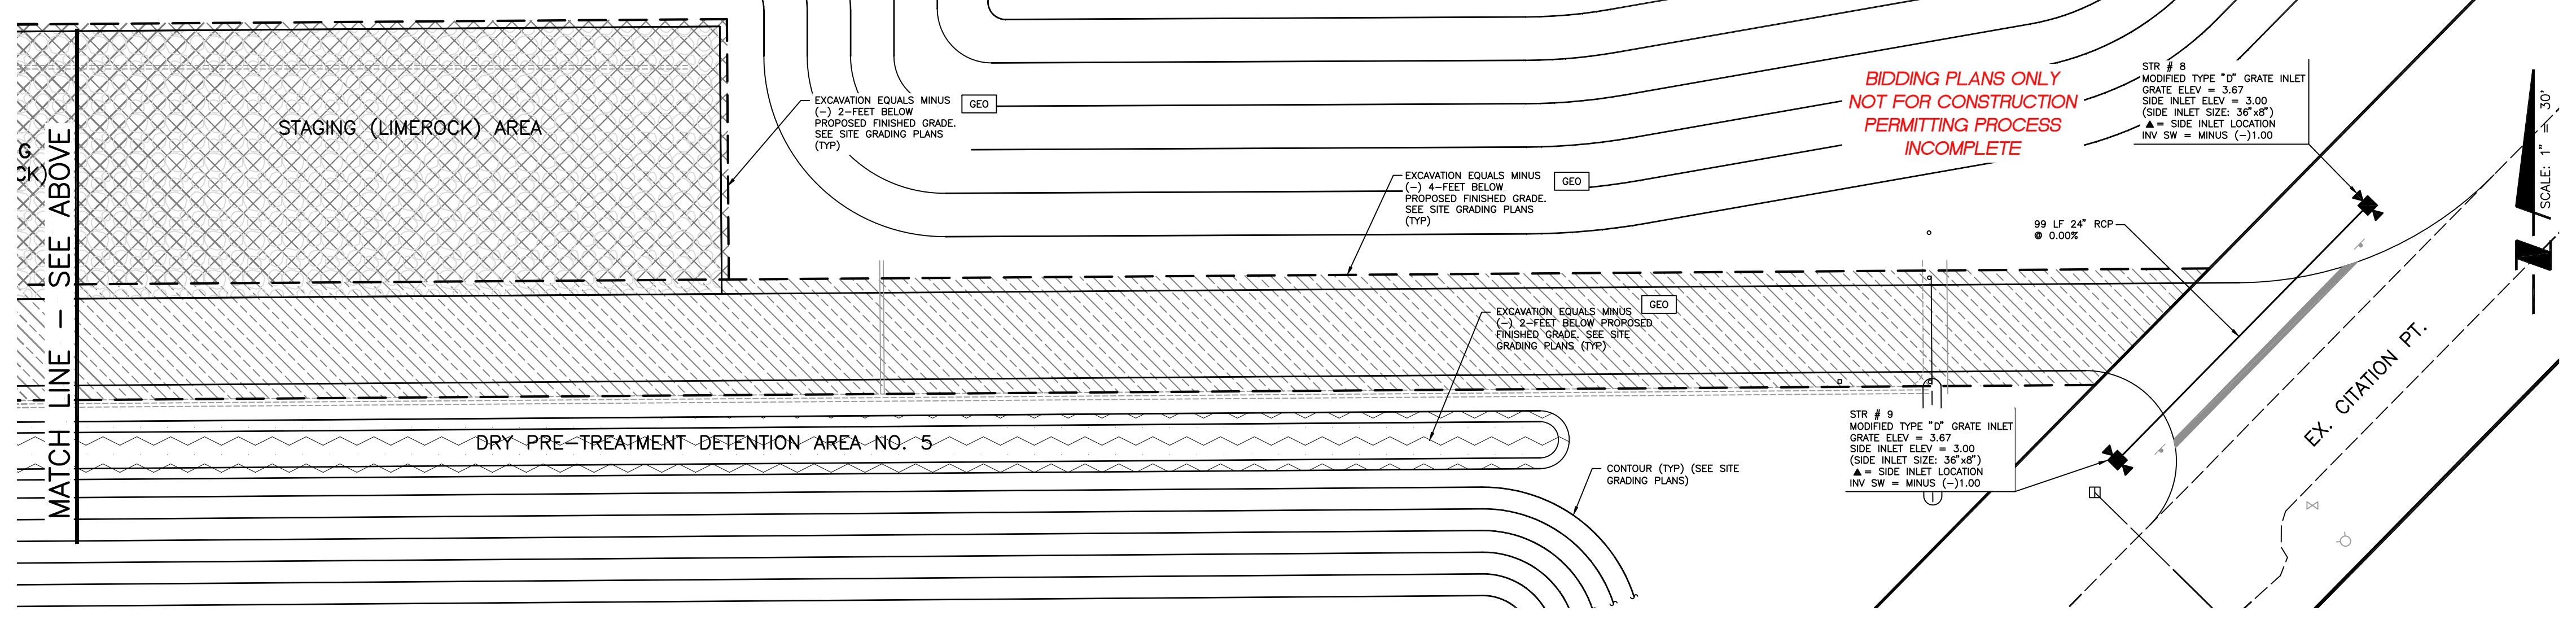


<p>DATE: 2.505.25E</p> <p>ISSUE DATE: 2.505.25E</p> <p>ISSUE DESCRIPTION: 2.505.25E</p> <p>LEAD DESIGNER: CMW\89458</p> <p>LEAD TECHNICIAN: CMW\89458</p>	<p>CLIENT: CITY OF NAPLES</p> <p>PROJECT: CITY OF NAPLES RECYCLE TRANSFER FACILITY</p> <p>PROJ. START DATE: MAY 2012</p> <p>HORIZONTAL SCALE: AS SHOWN</p> <p>VERTICAL SCALE: N/A</p> <p>CROSS REF. NUMBER: ---</p> <p>WILSONMILLER PROJECT NUMBER: 215610640</p>	<p>TITLE: SITE PLAN - DRAINAGE AND UNDERCUT EXCAVATION</p> <p>INDEX NUMBER: 215610640c-006dm</p> <p>SHEET NUMBER: 6 OF 17</p> <p>PRELIMINARY</p>
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**GENERAL PLAN NOTES**

- 1) ALL INVERTS AND ELEVATIONS ARE SHOWN IN FEET AND BASED ON NORTH AMERICAN VERTICAL DATUM 1988 (NAVD=88). HOWEVER, TO CONVERT TO NATIONAL GEODETIC VERTICAL DATUM 1929 (NGVD), ADD 1.272 FEET TO EACH ELEVATION. SINCE THE CONVERSION FACTOR MAY VARY SLIGHTLY, IT IS RECOMMENDED THAT A PROFESSIONAL LAND SURVEYOR, LICENSED AND REGISTERED IN THE STATE OF FLORIDA, RECALCULATE THE CONVERSION FACTOR PRIOR TO THE START OF CONSTRUCTION.
- 2) CONTRACTOR SHALL GRADE ALL OPEN SPACE AREAS TO ALLOW FOR POSITIVE DRAINAGE FLOW TO PROPOSED YARD DRAINS AND/OR CATCH BASINS, OR AS DESIGNATED BY THE "GENERALIZED SURFACE FLOW DIRECTION" FLOW ARROWS WITHIN THE SITE PLAN.
- 3) ALL PROPOSED ELEVATIONS FOR OPEN SPACE AREAS SHALL REPRESENT FINAL FINISHED GRADE, I.E. TOP-OF-SOIL, TOP-OF-MULCH, TOP-OF-RIP-RAP, ETC.
- 4) THE LOCATION OF EXISTING UTILITIES AND STORM SEWER SHOWN WITHIN THESE CONSTRUCTION DOCUMENTS HAVE BEEN PREPARED FROM AVAILABLE RECORD DRAWINGS AND SURVEY INFORMATION. IT IS THE RESPONSIBILITY OF THE CONTRACTOR TO DETERMINE THE EXACT LOCATIONS PRIOR TO CONSTRUCTION AND PROVIDE IN WRITING ANY DISCREPANCIES TO THE DESIGNER OR ENGINEER OF RECORD. IT IS THE RESPONSIBILITY OF THE CONTRACTOR TO REPAIR OR REPLACE ANY INFRASTRUCTURE DAMAGED DURING CONSTRUCTION TO EXISTING CONDITIONS OR BETTER.
- 5) THESE CONSTRUCTION DOCUMENTS ARE NOT INTENDED TO BE ALL INCLUSIVE OF EXISTING FACILITIES OR MATERIALS TO BE REMOVED. IT IS THE RESPONSIBILITY OF THE CONTRACTOR TO VISIT THE EXISTING CONDITIONS WITH REGARDS TO THE BUILDING AND SITE MODIFICATIONS NECESSARY TO ACCOMMODATE THE PROPOSED IMPROVEMENTS.
- 6) ALL ITEMS TO BE REMOVED SHALL BECOME THE PROPERTY OF THE CONTRACTOR AND SHALL BE INCLUDED AT THE EXPENSE OF THE CONTRACTOR, INCLUDING REMOVAL AND DUMPING FEES, MATERIALS, LABOR, ETC., ASSOCIATED WITH THE RESTORATION.
- 7) CONTRACTOR SHALL CONSTRUCT ALL SIDEWALKS SO THAT LONGITUDINAL SLOPES DO NOT EXCEED 1:20 (UNLESS HANDRAILS ARE PROVIDED). CROSS-SLOPES DO NOT EXCEED 1:50 (2% MAX) AND ALL LANDINGS OR TURN-AROUND AREAS (5' SQUARE MIN) SHALL NOT EXCEED 1:50 (2% MAX) SLOPE IN ALL DIRECTIONS PER A.D.A.
- 8) STORM WATER PVC PIPE MATERIAL SPECIFICATIONS:
  - A. PIPES 12-INCH IN DIAMETER AND GREATER, DESIGNED TO BE CONSTRUCTED UNDER PAVEMENT, SHALL BE CONTECH A-2000 PVC, COLOR-CODED WHITE.
  - B. PIPES 12-INCH IN DIAMETER AND GREATER, NOT DESIGNED TO BE CONSTRUCTED UNDER PAVEMENT, SHALL BE EITHER CONTECH A-2000 PVC, COLOR-CODED WHITE, OR ADS 8-12 (QUAL-WALL), COLOR-CODED BLACK.
  - C. PIPES 10-INCH IN DIAMETER AND SMALLER SHALL BE MATERIAL SPECIFICATION SCHEDULE 40, COLOR-CODED WHITE.
 NOTE: ALTERNATES FOR ALL PIPE SIZES MAY BE PROVIDED PROVIDED APPROVAL FROM THE CIVIL ENGINEER IS OBTAINED. MATERIAL ALTERNATES MUST BE REVIEWED DURING THE PROJECT'S BIDDING PHASE.

**LEGEND**

- BUILDING
- WATER MANAGEMENT DETENTION AREA
- CONCRETE SIDEWALK/PAD (REFERENCE SECTION DETAILS)
- CONCRETE PAVEMENT/APRON (BY OTHERS)
- CONCRETE ENTRY/SIDEWALK (BY OTHERS)
- LAYDOWN (LIMEROCK) AREA
- RIP-RAP
- DIRECTION OF DRAINAGE FLOW
- DIRECTION OF SWALE FLOW
- CITY
- REFERENCE ARCHITECT'S PLANS PREPARED BY DISNEY ASSOCIATES, P.A. FOR FINAL LOCATION, SIZE, DETAILS AND SPECIFICATIONS
- REFERENCE ARCHITECT'S MECHANICAL, ELECTRICAL OR PLUMBING (MEP) ENGINEERING PLANS FOR FINAL LOCATION, SIZE, MATERIALS, DETAILS AND SPECIFICATIONS. COORDINATION WITH ARCHITECT'S MEP IS REQUIRED.
- REFERENCE FIRE SPRINKLER CONTRACTOR'S PLANS FOR FINAL LOCATION, SIZE, MATERIALS, DETAILS AND SPECIFICATIONS. COORDINATION WITH ARCHITECT'S MEP IS REQUIRED.
- BUILDING CONTRACTOR'S POINT-OF-CONNECTION REFERENCE ARCHITECT'S MEP PLANS FOR CONNECTION DETAILS AND SPECIFICATIONS
- REFERENCE GEOTECHNICAL ENGINEER'S PLANS AND REPORTS FOR DETAILS AND SPECIFICATIONS. COORDINATION WITH GEOTECHNICAL ENGINEER IS REQUIRED.
- REFERENCE FLORIDA POWER & LIGHT'S DESIGN FOR FINAL LOCATION, SIZE, DETAILS, AND SPECIFICATIONS
- CONTRACTOR SHALL COORDINATE WITH THE PROPERTY OWNER FOR MATERIALS AND SPECIFICATIONS REQUIRED FOR BIDDING AND CONSTRUCTION. IRRIGATION CONTRACTOR SHALL PROVIDE FINAL DESIGN, MATERIALS, DETAILS AND SPECIFICATIONS
- REFERENCE LANDSCAPE ARCHITECT'S PLANS FOR CODE REQUIRED MATERIALS AND GROUND COVER SPECIFICATIONS

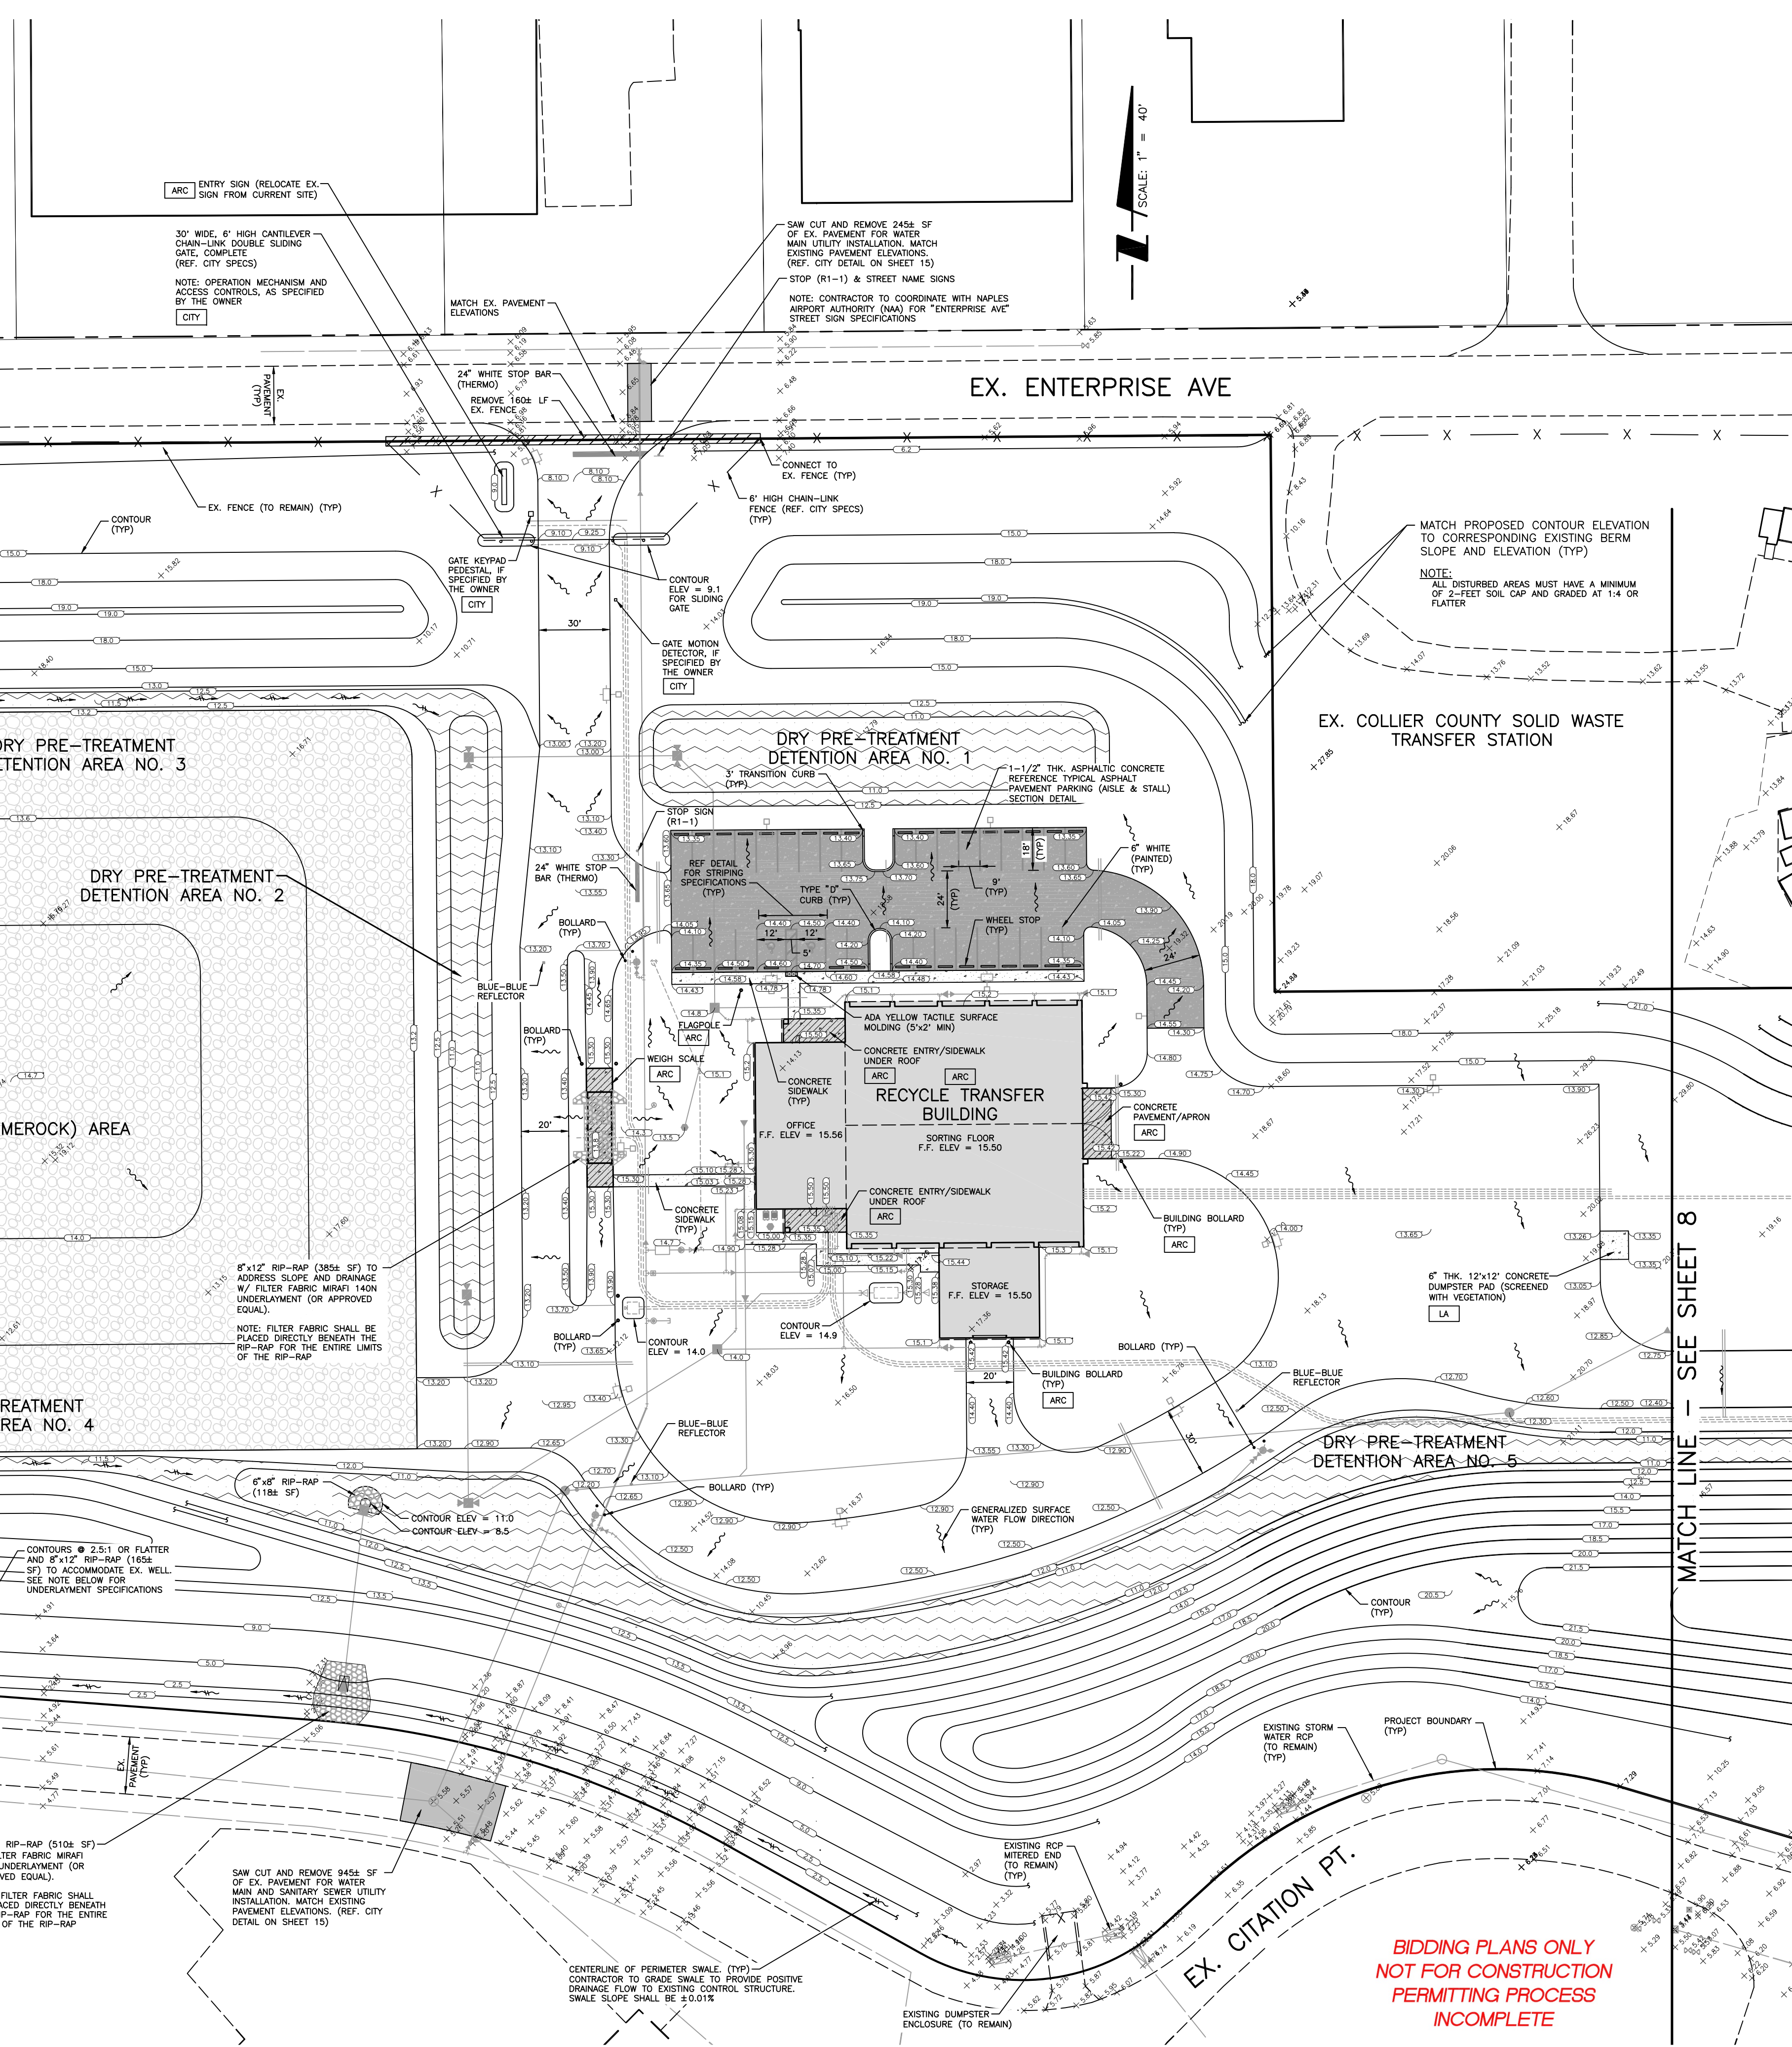


**EX. FLIGHT DR**

MATCH PROPOSED CONTOUR ELEVATION TO CORRESPONDING EXISTING BERM SLOPE AND ELEVATION (TYP)

NOTE: ALL DISTURBED AREAS MUST HAVE A MINIMUM OF 2-FEET SOIL CAP AND GRADED AT 1:4 OR FLATTER

REFERENCE DETAIL AT BOTTOM LEFT FOR EX. CONTROL STRUCTURE RIP-RAP DETAIL (TYP)

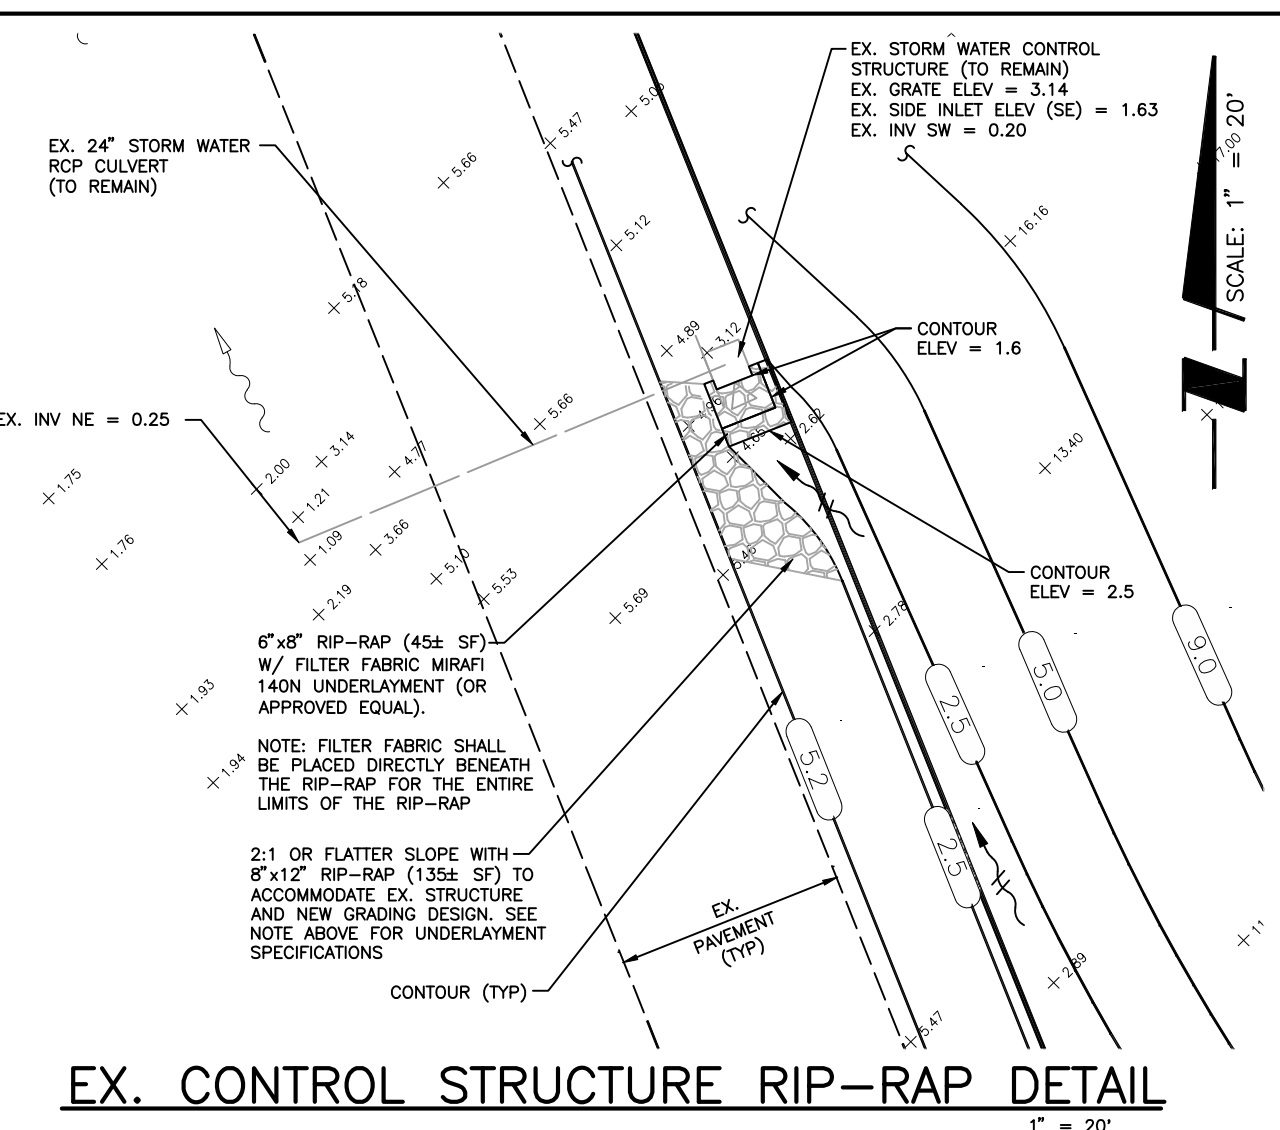


**PERIMETER SWALE (PROJECT OUTFALL) NOTE:**  
 THE PERIMETER SWALE SHOWN, WHICH SERVES AS THE PERMANENT OUTFALL FOR THE PROPOSED PROJECT IS EXISTING, BUT IS BEING MODIFIED AS A RESULT OF THE SURROUNDING SITE DEVELOPMENT IMPROVEMENTS FOR THE PROPOSED PROJECT. THE PERIMETER SWALE DOES NOT SERVE AS THE OUTFALL FOR EXISTING SITE DEVELOPMENT'S UPSTREAM. IT SHALL BE THE RESPONSIBILITY OF THE CONTRACTOR TO MAINTAIN THIS PERIMETER SWALE THROUGHOUT THE DURATION OF CONSTRUCTION, AND PROVIDE TEMPORARY MEASURES, WITH ADEQUATE CAPACITY, DURING ITS MODIFICATION.

**BIDDING PLANS ONLY NOT FOR CONSTRUCTION PERMITTING PROCESS INCOMPLETE**

MATCH LINE - SEE SHEET 8

<p>REV. NO. REVISION DESCRIPTION</p>		<p>CITY: COLLIER</p>		<p>ISSUE DATE: 2.505.25E</p>		<p>PROJECT: CITY OF NAPLES RECYCLE TRANSFER FACILITY</p>		<p>PROJ. START DATE: MAY 2012</p>		<p>TITLE: SITE PLAN - PAVING AND GRADING (WEST)</p>		<p>PRELIMINARY</p>	
<p>2.505.25E</p>		<p>LEAD DESIGNER: CMW/89458</p>		<p>LEAD TECHNICIAN: CMW/89458</p>		<p>3200 Bailey Lane, Suite 200 Naples, FL 34105-8507                  800.643.4336 • 239.649.4040 • F 239.643.5716                  Certificate of Authorization #43 • FL Lic. # LC 000170 • www.wilsonmiller.com</p>		<p>INDEX NUMBER: 215610640c-007sd</p>		<p>SHEET NUMBER: 7 OF 17</p>		<p>WILSONMILLER PROJECT NUMBER: 215610640</p>	

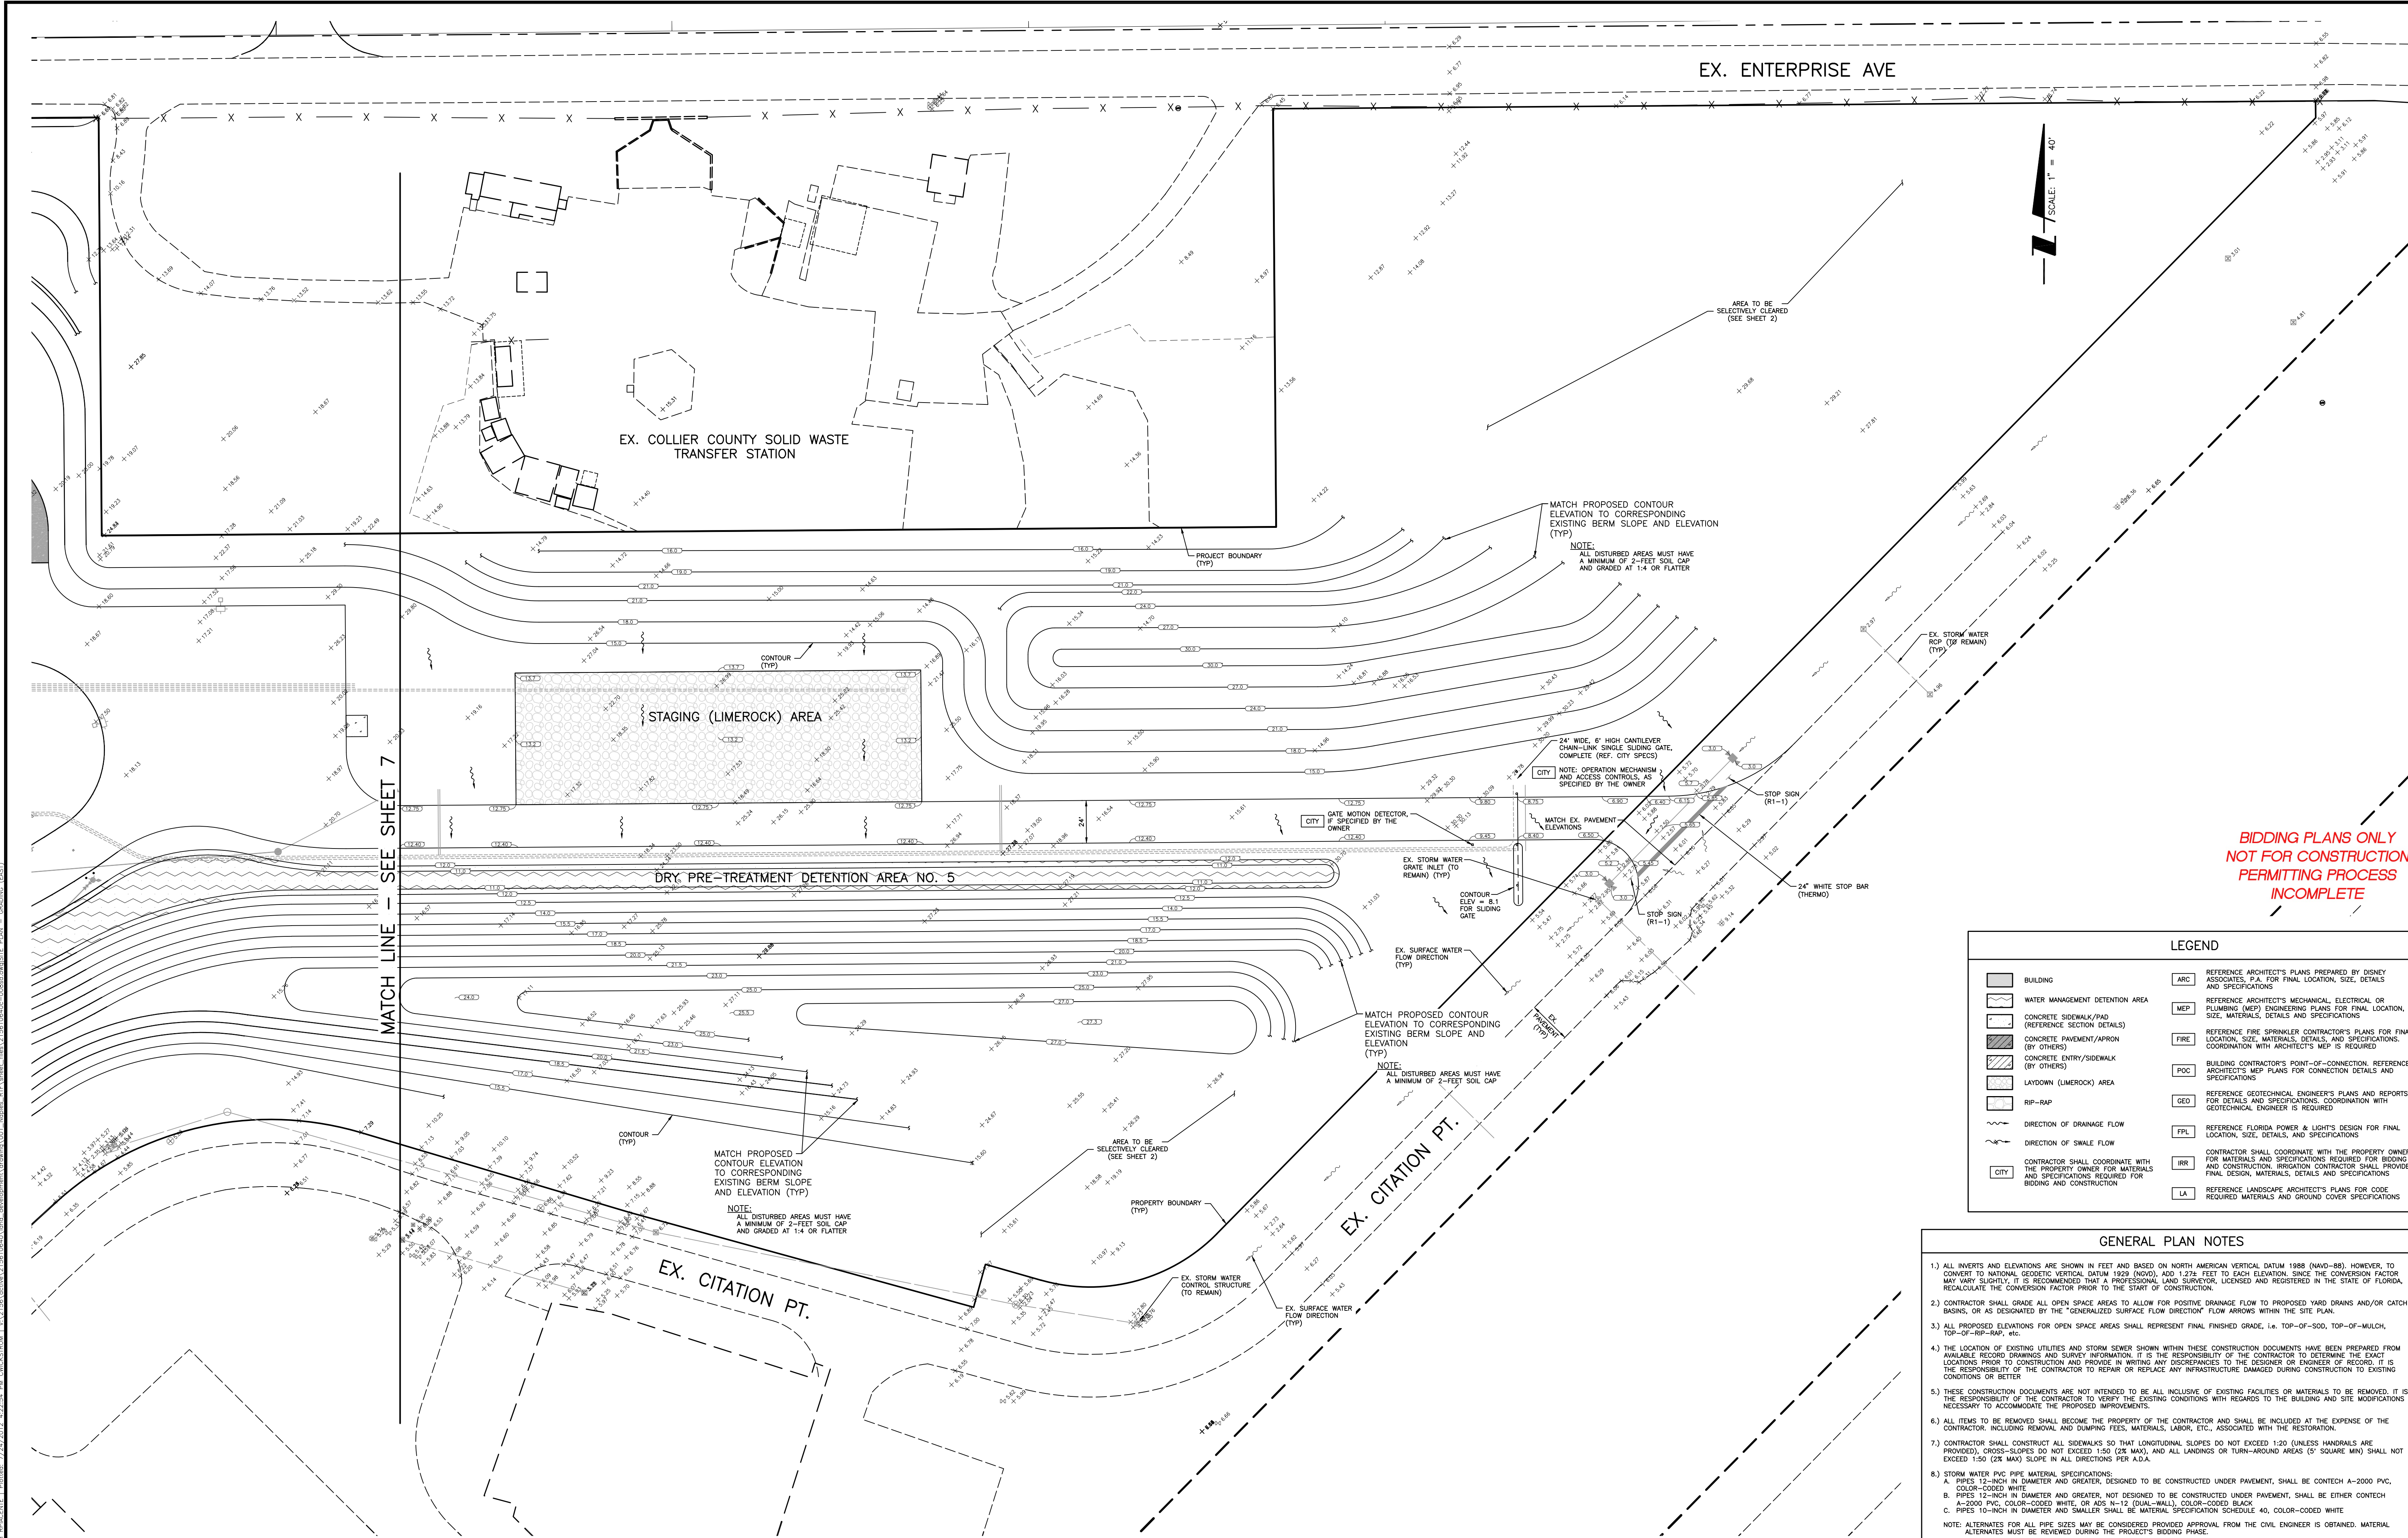

EX. ENTERPRISE AVE

EX. COLLIER COUNTY SOLID WASTE TRANSFER STATION

STAGING (LIMEROCK) AREA

DRY PRE-TREATMENT DETENTION AREA NO. 5

EX. CITATION PT.

MATCH LINE - SEE SHEET 7





BIDDING PLANS ONLY  
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LEGEND	
	BUILDING
	WATER MANAGEMENT DETENTION AREA
	CONCRETE SIDEWALK/PAD (REFERENCE SECTION DETAILS)
	CONCRETE PAVEMENT/APRON (BY OTHERS)
	CONCRETE ENTRY/SIDEWALK (BY OTHERS)
	LAYDOWN (LIMEROCK) AREA
	RIP-RAP
	DIRECTION OF DRAINAGE FLOW
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	CITY
	REFERENCE ARCHITECT'S PLANS PREPARED BY DISNEY ASSOCIATES, P.A. FOR FINAL LOCATION, SIZE, DETAILS AND SPECIFICATIONS
	REFERENCE ARCHITECT'S MECHANICAL, ELECTRICAL OR PLUMBING (MEP) ENGINEERING PLANS FOR FINAL LOCATION, SIZE, MATERIALS, DETAILS AND SPECIFICATIONS
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- GENERAL PLAN NOTES**
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  - STORM WATER PVC PIPE MATERIAL SPECIFICATIONS:
    - PIPES 12-INCH IN DIAMETER AND GREATER, DESIGNED TO BE CONSTRUCTED UNDER PAVEMENT, SHALL BE CONTECH A-2000 PVC, COLOR-CODED WHITE.
    - PIPES 12-INCH IN DIAMETER AND GREATER, NOT DESIGNED TO BE CONSTRUCTED UNDER PAVEMENT, SHALL BE EITHER CONTECH A-2000 PVC, COLOR-CODED WHITE, OR ADS N-12 (DUAL-WALL), COLOR-CODED BLACK.
    - PIPES 10-INCH IN DIAMETER AND SMALLER SHALL BE MATERIAL SPECIFICATION SCHEDULE 40, COLOR-CODED WHITE.
 NOTE: ALTERNATES FOR ALL PIPE SIZES MAY BE CONSIDERED PROVIDED APPROVAL FROM THE CIVIL ENGINEER IS OBTAINED. MATERIAL ALTERNATES MUST BE REVIEWED DURING THE PROJECT'S BIDDING PHASE.

PROJECT: CITY OF NAPLES CITY OF NAPLES RECYCLE TRANSFER FACILITY		CLIENT: CITY OF NAPLES PROJECT: CITY OF NAPLES RECYCLE TRANSFER FACILITY		PROJECT START DATE: MAY 2012 HORIZONTAL SCALE: 1" = 40' VERTICAL SCALE: N/A Copyright: WilsonMiller Inc. 2009		TITLE: SITE PLAN - PAVING AND GRADING (EAST) INDEX NUMBER: 215610640c-008sd SHEET NUMBER: 8 OF 17		PRELIMINARY	
CITY: COLLIER ISSUE DATE: 2.505.25E LEAD DESIGNER: CMW\89458 LEAD TECHNICIAN: CMW\89458	3200 Bailey Lane, Suite 200 Naples, FL 34105-8507 800.643.4336 • 239.649.4040 • F 239.643.5716 Certificate of Authorization #43 • FL Lic. # LC-0000170 • www.stantec.com	WILSONMILLER PROJECT NUMBER: 215610640		CROSS REF. NUMBER:		WILSONMILLER PROJECT NUMBER: 215610640		SHEET NUMBER: 8 OF 17	







**BIDDING PLANS ONLY  
NOT FOR CONSTRUCTION  
PERMITTING PROCESS  
INCOMPLETE**

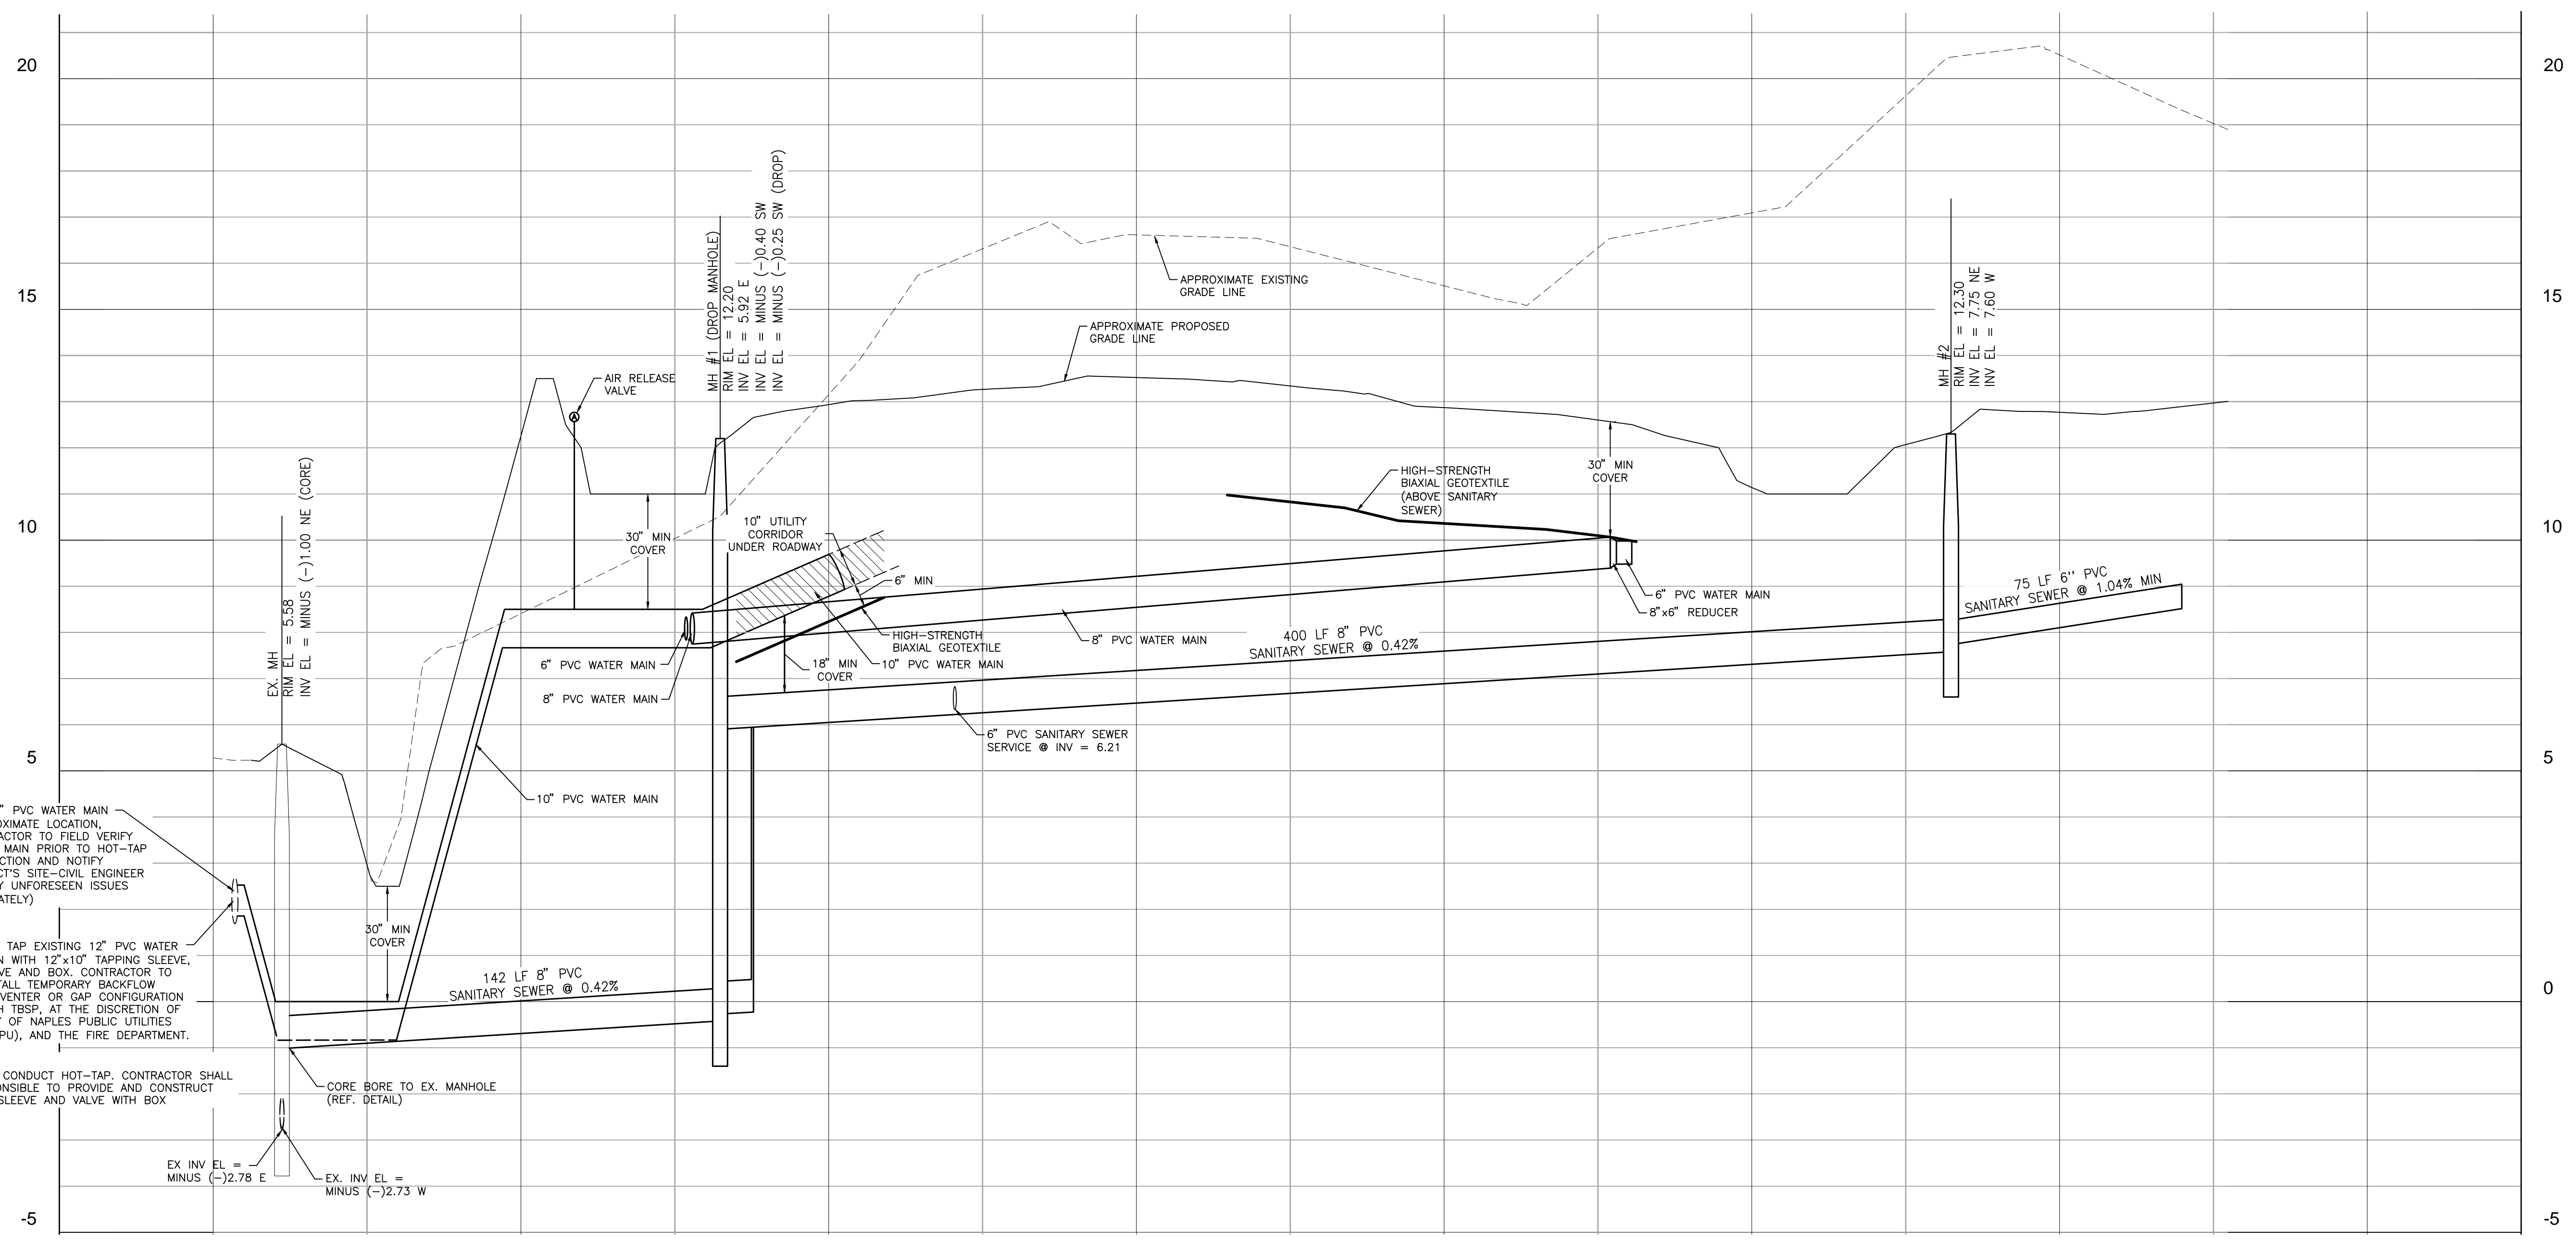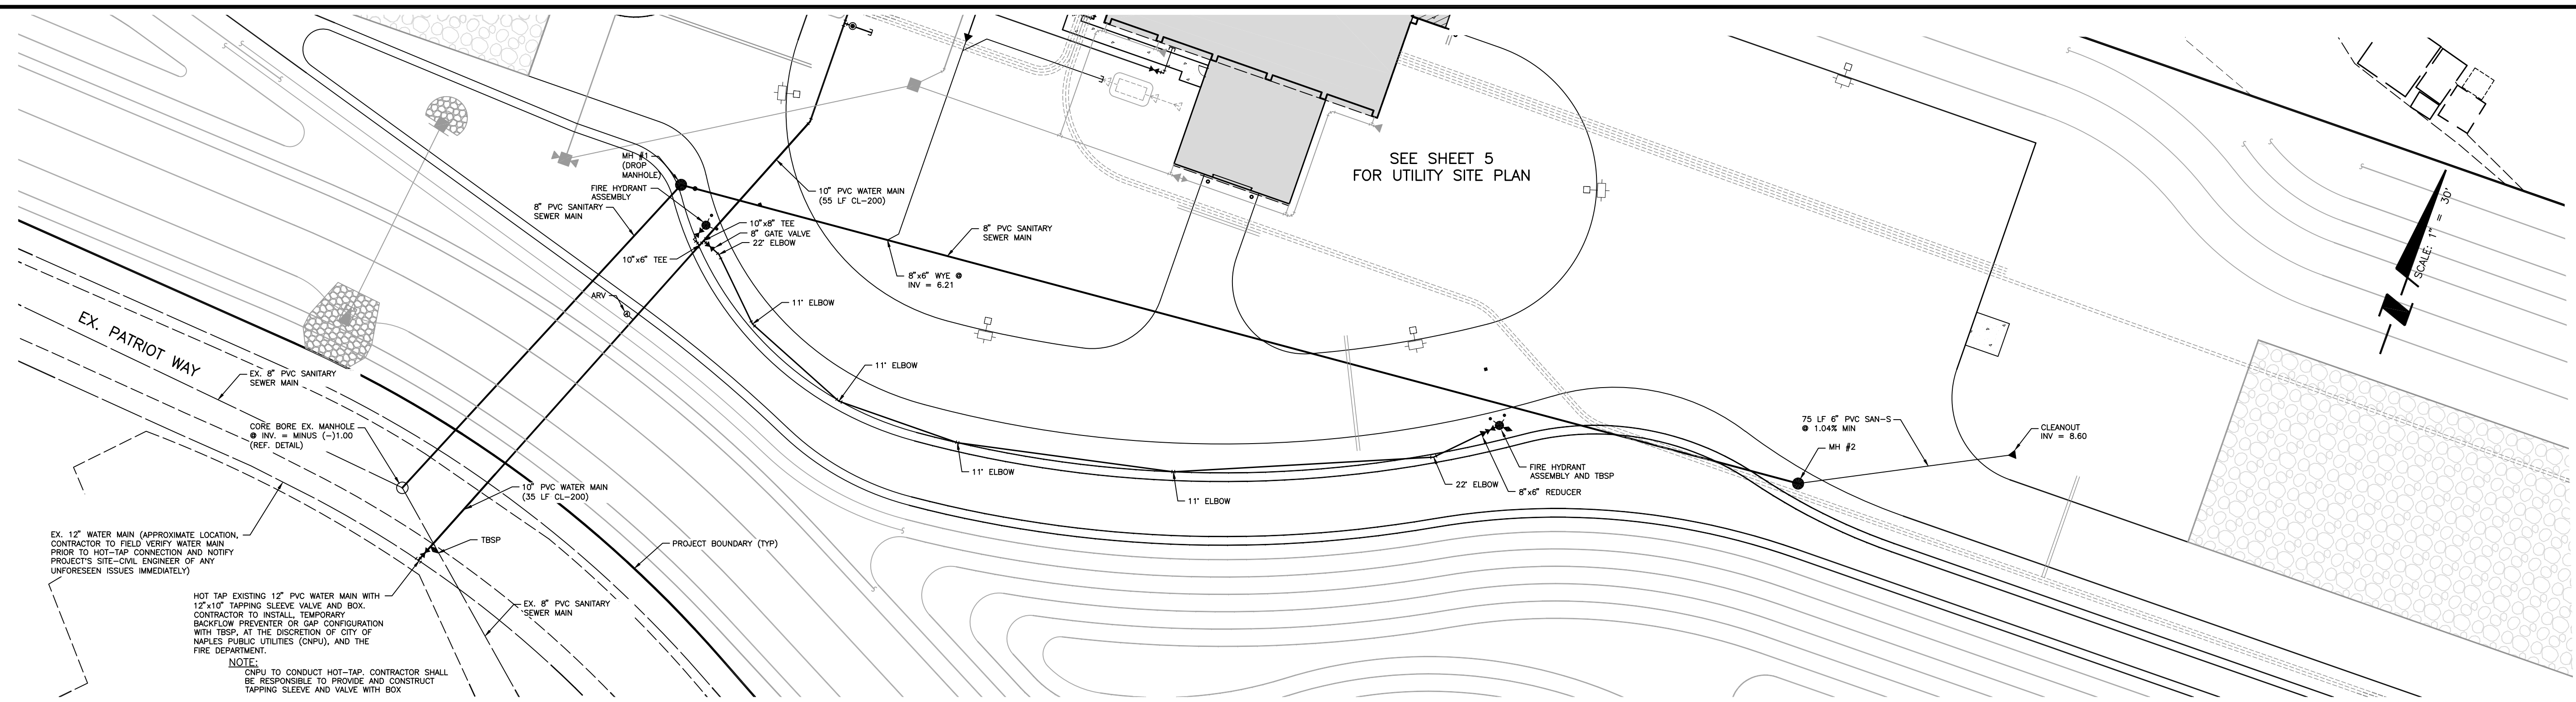Sheet: 7/24/2012 11:00:21 AM BRH42001E I:\Projects\7/24/2012 4:23:12 PM CONSTRUCTION 1\A\2156\util\215610640c-009st.dwg User: daniel.schmitt Date: 7/24/2012 Time: 11:00:21 AM




<b>WilsonMiller Stantec</b> <small>3200 Bailey Lane, Suite 200 Naples, FL 34105-8507        800.643.4336 • 239.649.4040 • F 239.643.5716        Certificate of Authorization #43 • FL Lic. # LC-0000170 • www.stantec.com</small>		CLIENT: CITY OF NAPLES PROJECT: CITY OF NAPLES RECYCLE TRANSFER FACILITY	PROJ. START DATE: MAY 2012 HORIZONTAL SCALE: 1" = 30' VERTICAL SCALE: 1" = 2' Copyright WilsonMiller Inc. 2009	TITLE: PLAN AND PROFILE EX. MH TO MH #2	INDEX NUMBER: 215610640c-009st SHEET NUMBER: 9 OF 17
CMTY: COLLIER ISSUE DATE: ISSUE DESCRIPTION: LEAD DESIGNER: CMW\89458 LEAD TECHNICIAN: CMW\89458	DATE: 2.505.25E SEC-TWP-RGE: DRAWN BY / EMP. NO.: SEC-TWP-RGE:	REV. NO. / DESCRIPTION:	CROSS REF. NUMBER:	WILSONMILLER PROJECT NUMBER: 215610640	SHEET NUMBER: 9 OF 17

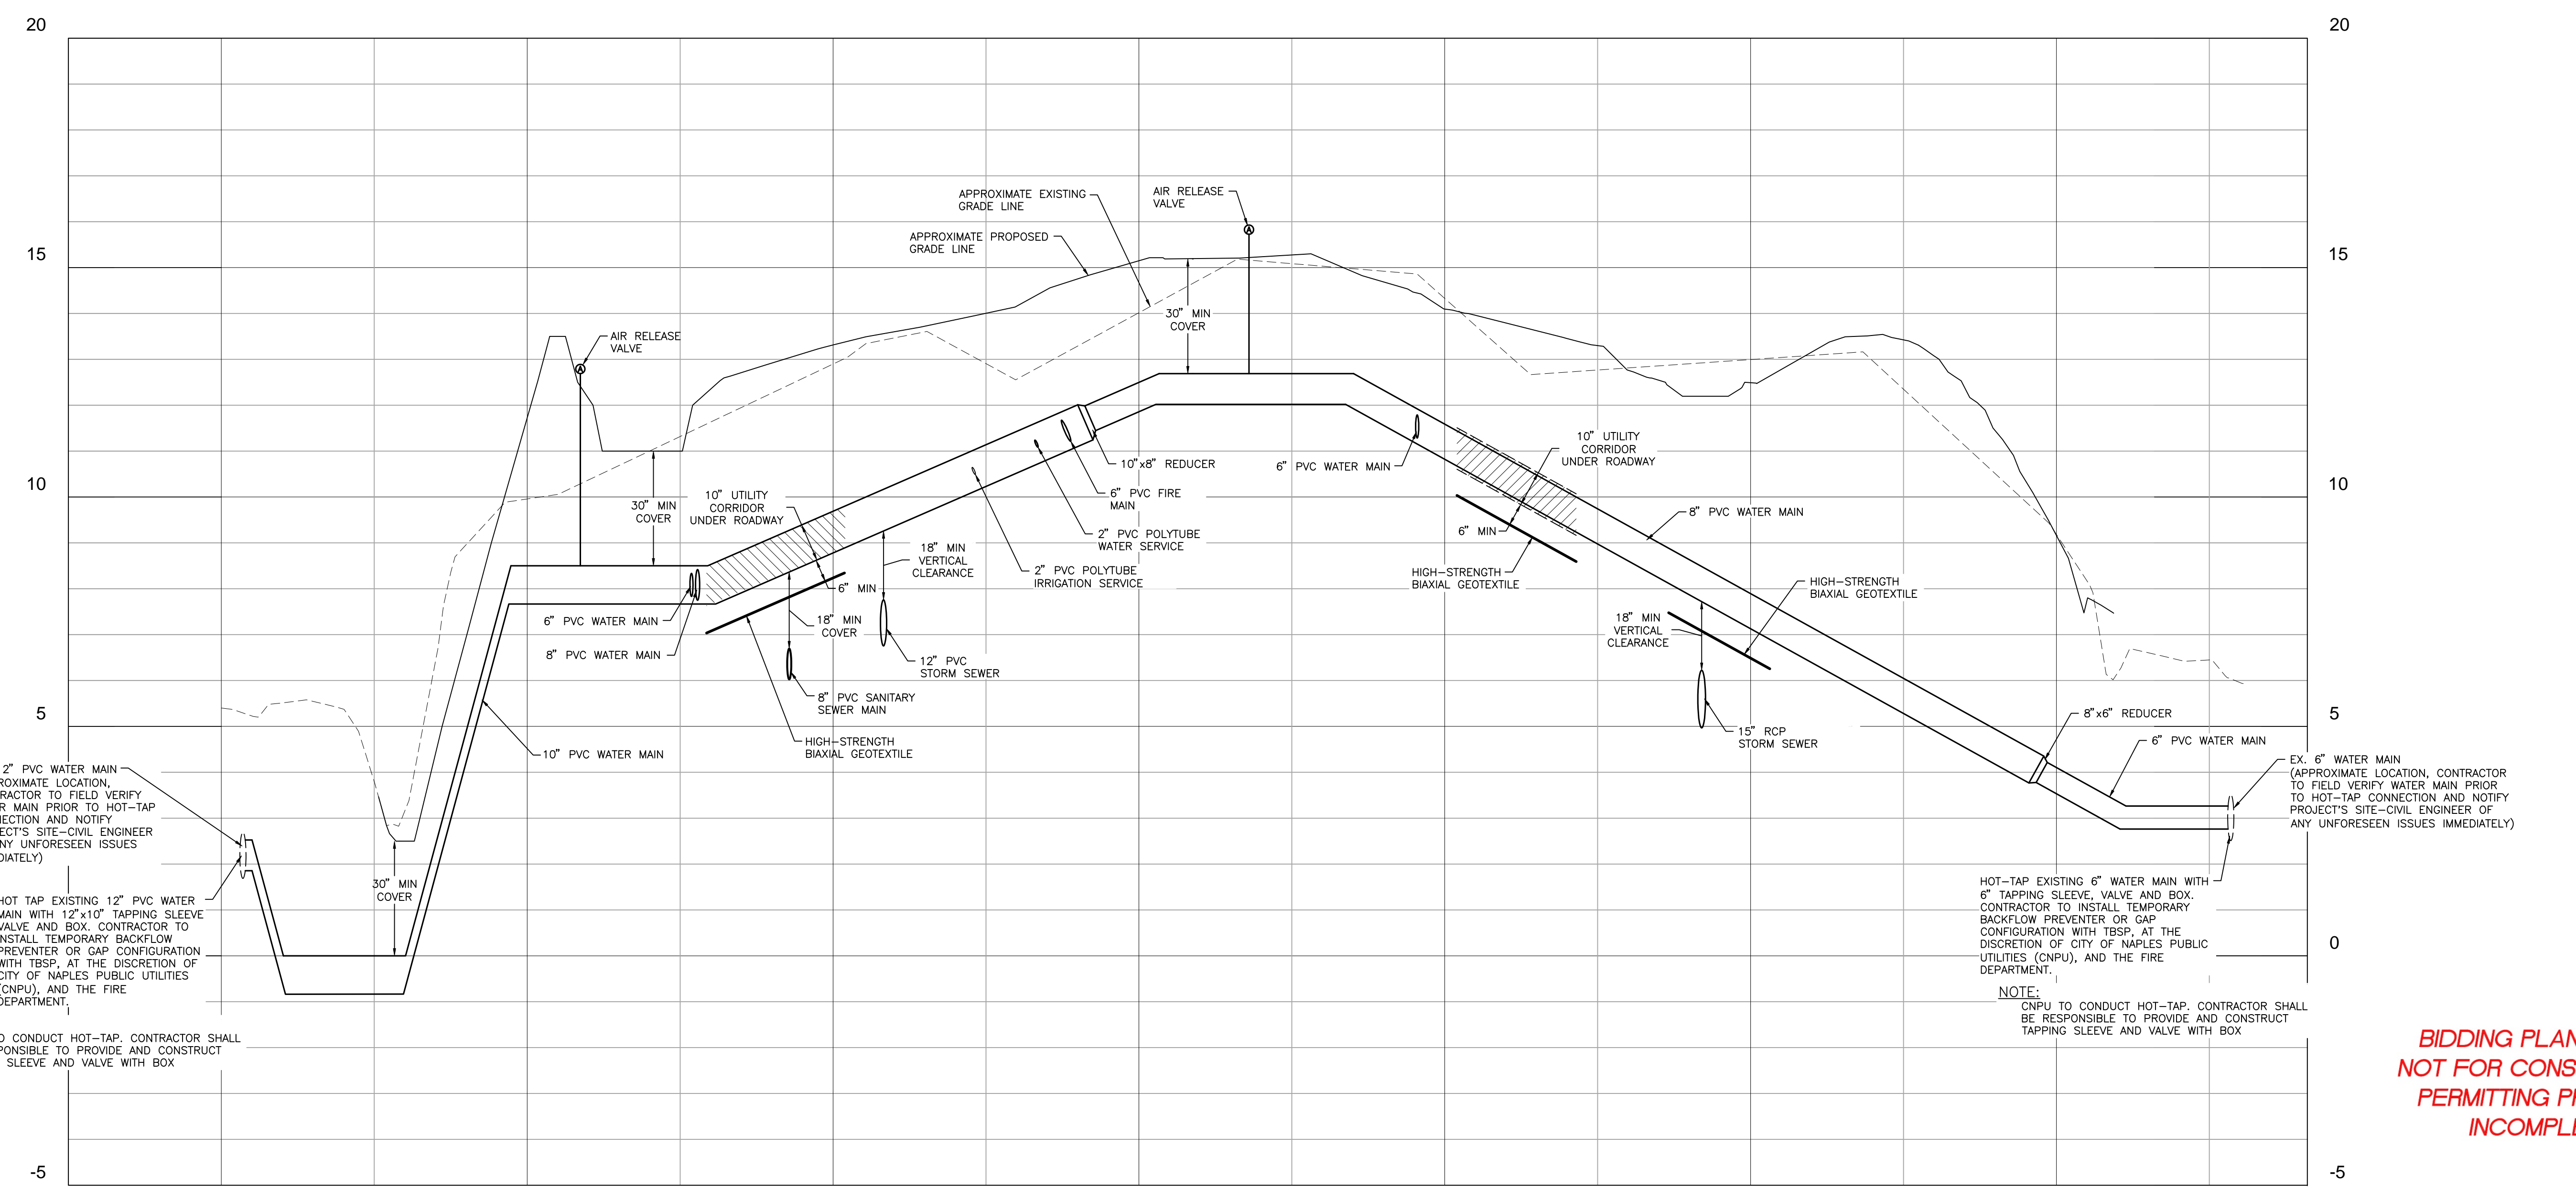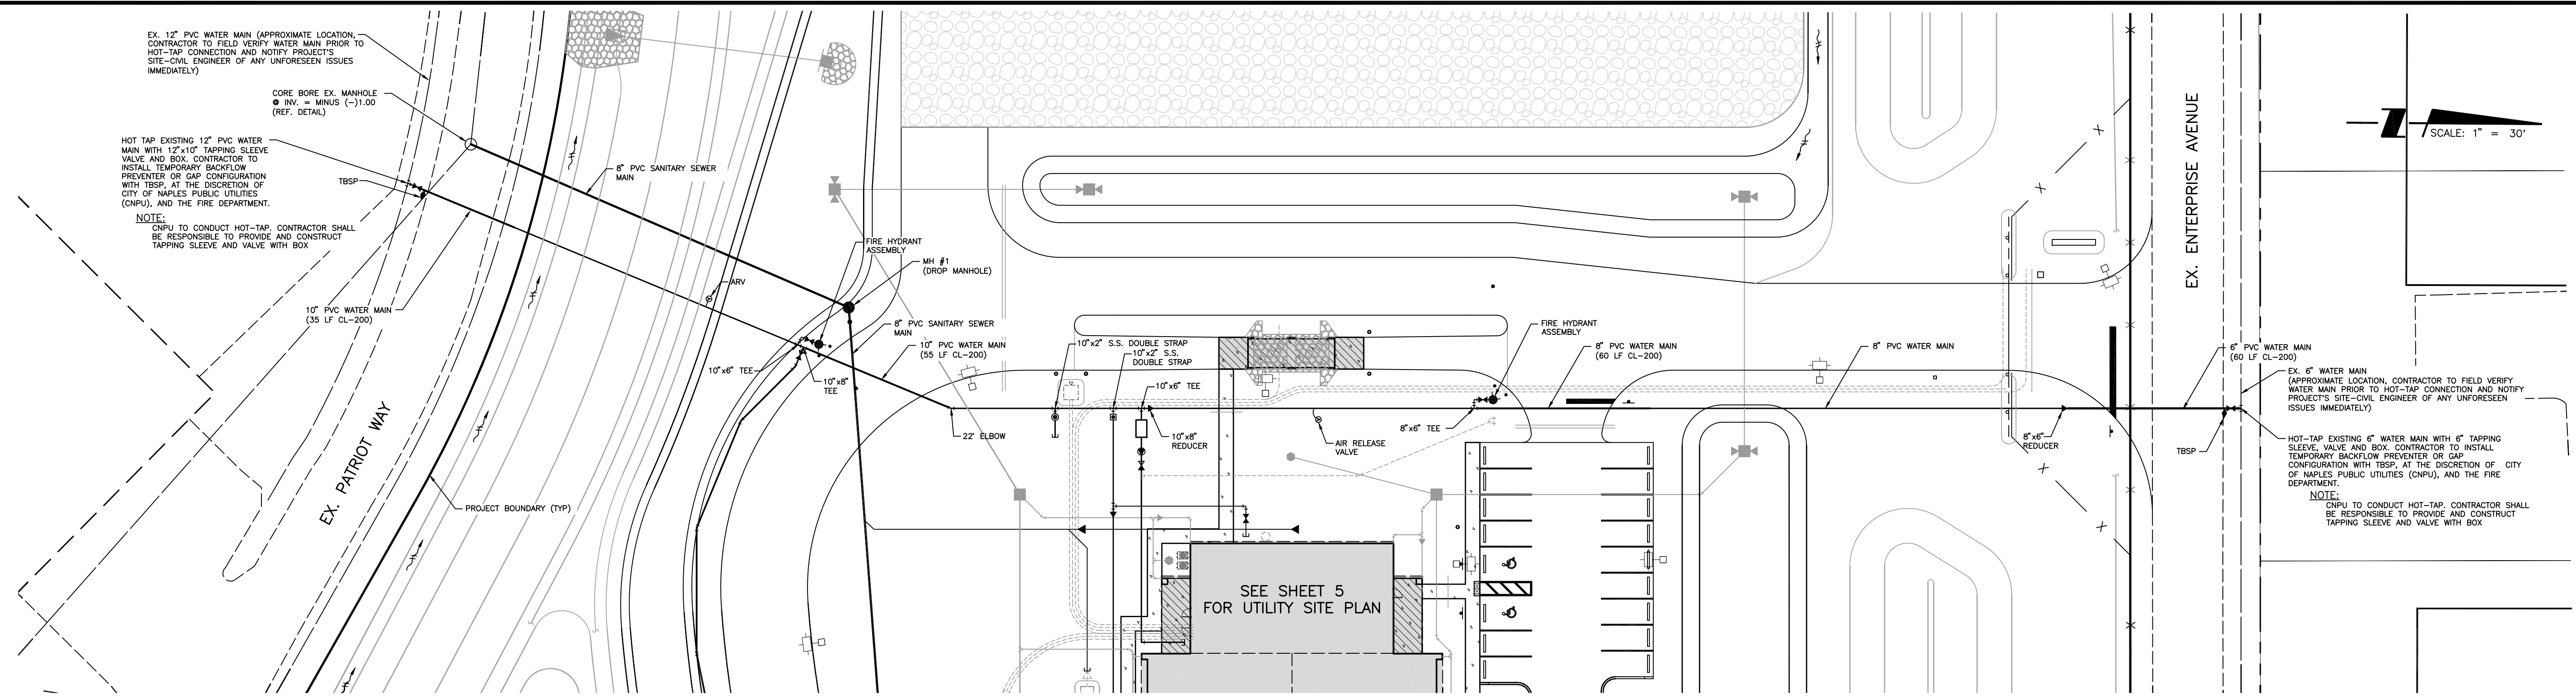

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2/24/2012 11:01:16 AM B:\PROJECTS\110116 AM BIDDING\110116\110116.dwg (User: daniel) 2/24/2012 4:23:28 PM C:\CADD\DWG\110116.dwg (User: daniel) 2/24/2012 4:23:28 PM C:\CADD\DWG\110116.dwg (User: daniel)

REVISION NO.    REVISION DESCRIPTION		DATE    DRAWN BY / EMP. NO.		SEC.    TWP.    RGE.		CITY:    COLLIER		ISSUE DATE:		ISSUE DESCRIPTION:				CLIENT:		PROJECT:		PROJ. START DATE:		TITLE:							
												2, 505, 25E		LEAD DESIGNER: CMW/89458		LEAD TECHNICIAN: CMW/89458		3200 Bailey Lane, Suite 200 Naples, FL 34105-8507 800.643.4336 • 239.649.4040 • F 239.643.5716 Certificate of Authorization # 43 • FL Lic. # LC-0000170 • www.wilsonmiller.com		CITY OF NAPLES CITY OF NAPLES RECYCLE TRANSFER FACILITY		MAY 2012 HORIZONTAL SCALE: 1" = 30' VERTICAL SCALE: 1" = 2' Copyright WilsonMiller Inc. 2009		PLAN AND PROFILE WATER MAIN		PRELIMINARY	
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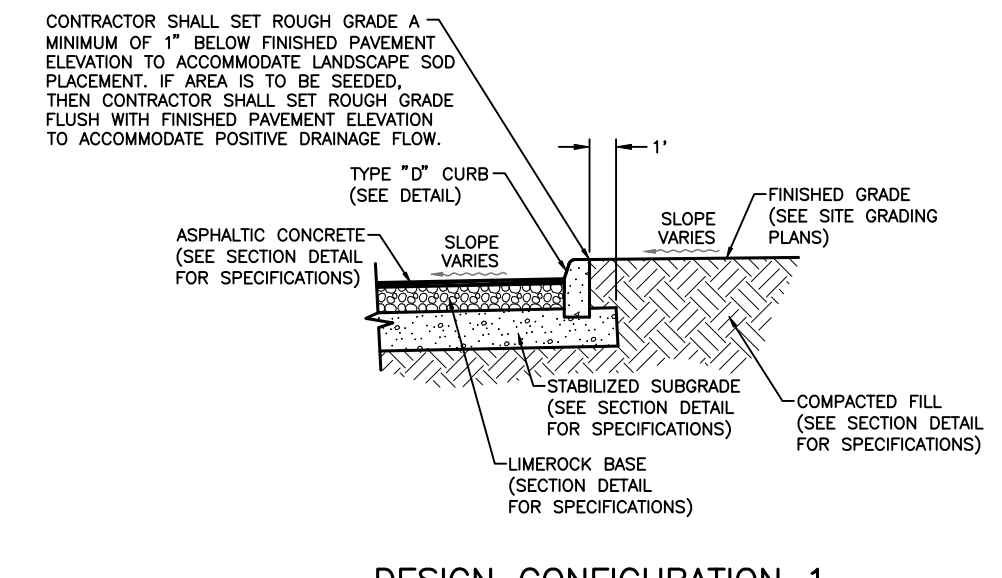


- GENERAL CROSS SECTION NOTES**
- 1) REFERENCE SITE DESIGN AND COORDINATION NOTES ON SHEET 3.
  - 2) ALL DISTURBED OR PROPOSED LANDSCAPE AREAS SHALL BE COVERED WITH A SUITABLE GROUND COVER, REFERENCE LANDSCAPE ARCHITECT'S PLANS FOR DESIGN, DETAILS AND SPECIFICATIONS.
  - 3) REFERENCE TYPICAL EDGE OF PAVEMENT/CURB SECTION DETAILS FOR LIMEROCK AND STABILIZED SUBGRADE SPECIFICATIONS.
  - 4) REFERENCE TYPICAL EDGE OF CURB AND EDGE OF SIDEWALK SECTION DETAILS FOR GRADING INTERFACE SPECIFICATIONS.
  - 5) ELEVATIONS SHOWN ARE IN FT-NAVD-88.
- NOTE:  
IT IS RECOMMENDED THAT A PROFESSIONAL LAND SURVEYOR, LICENSED AND REGISTERED IN THE STATE OF FLORIDA, RECALCULATE THE CONVERSION FACTOR PRIOR TO CONSTRUCTION.

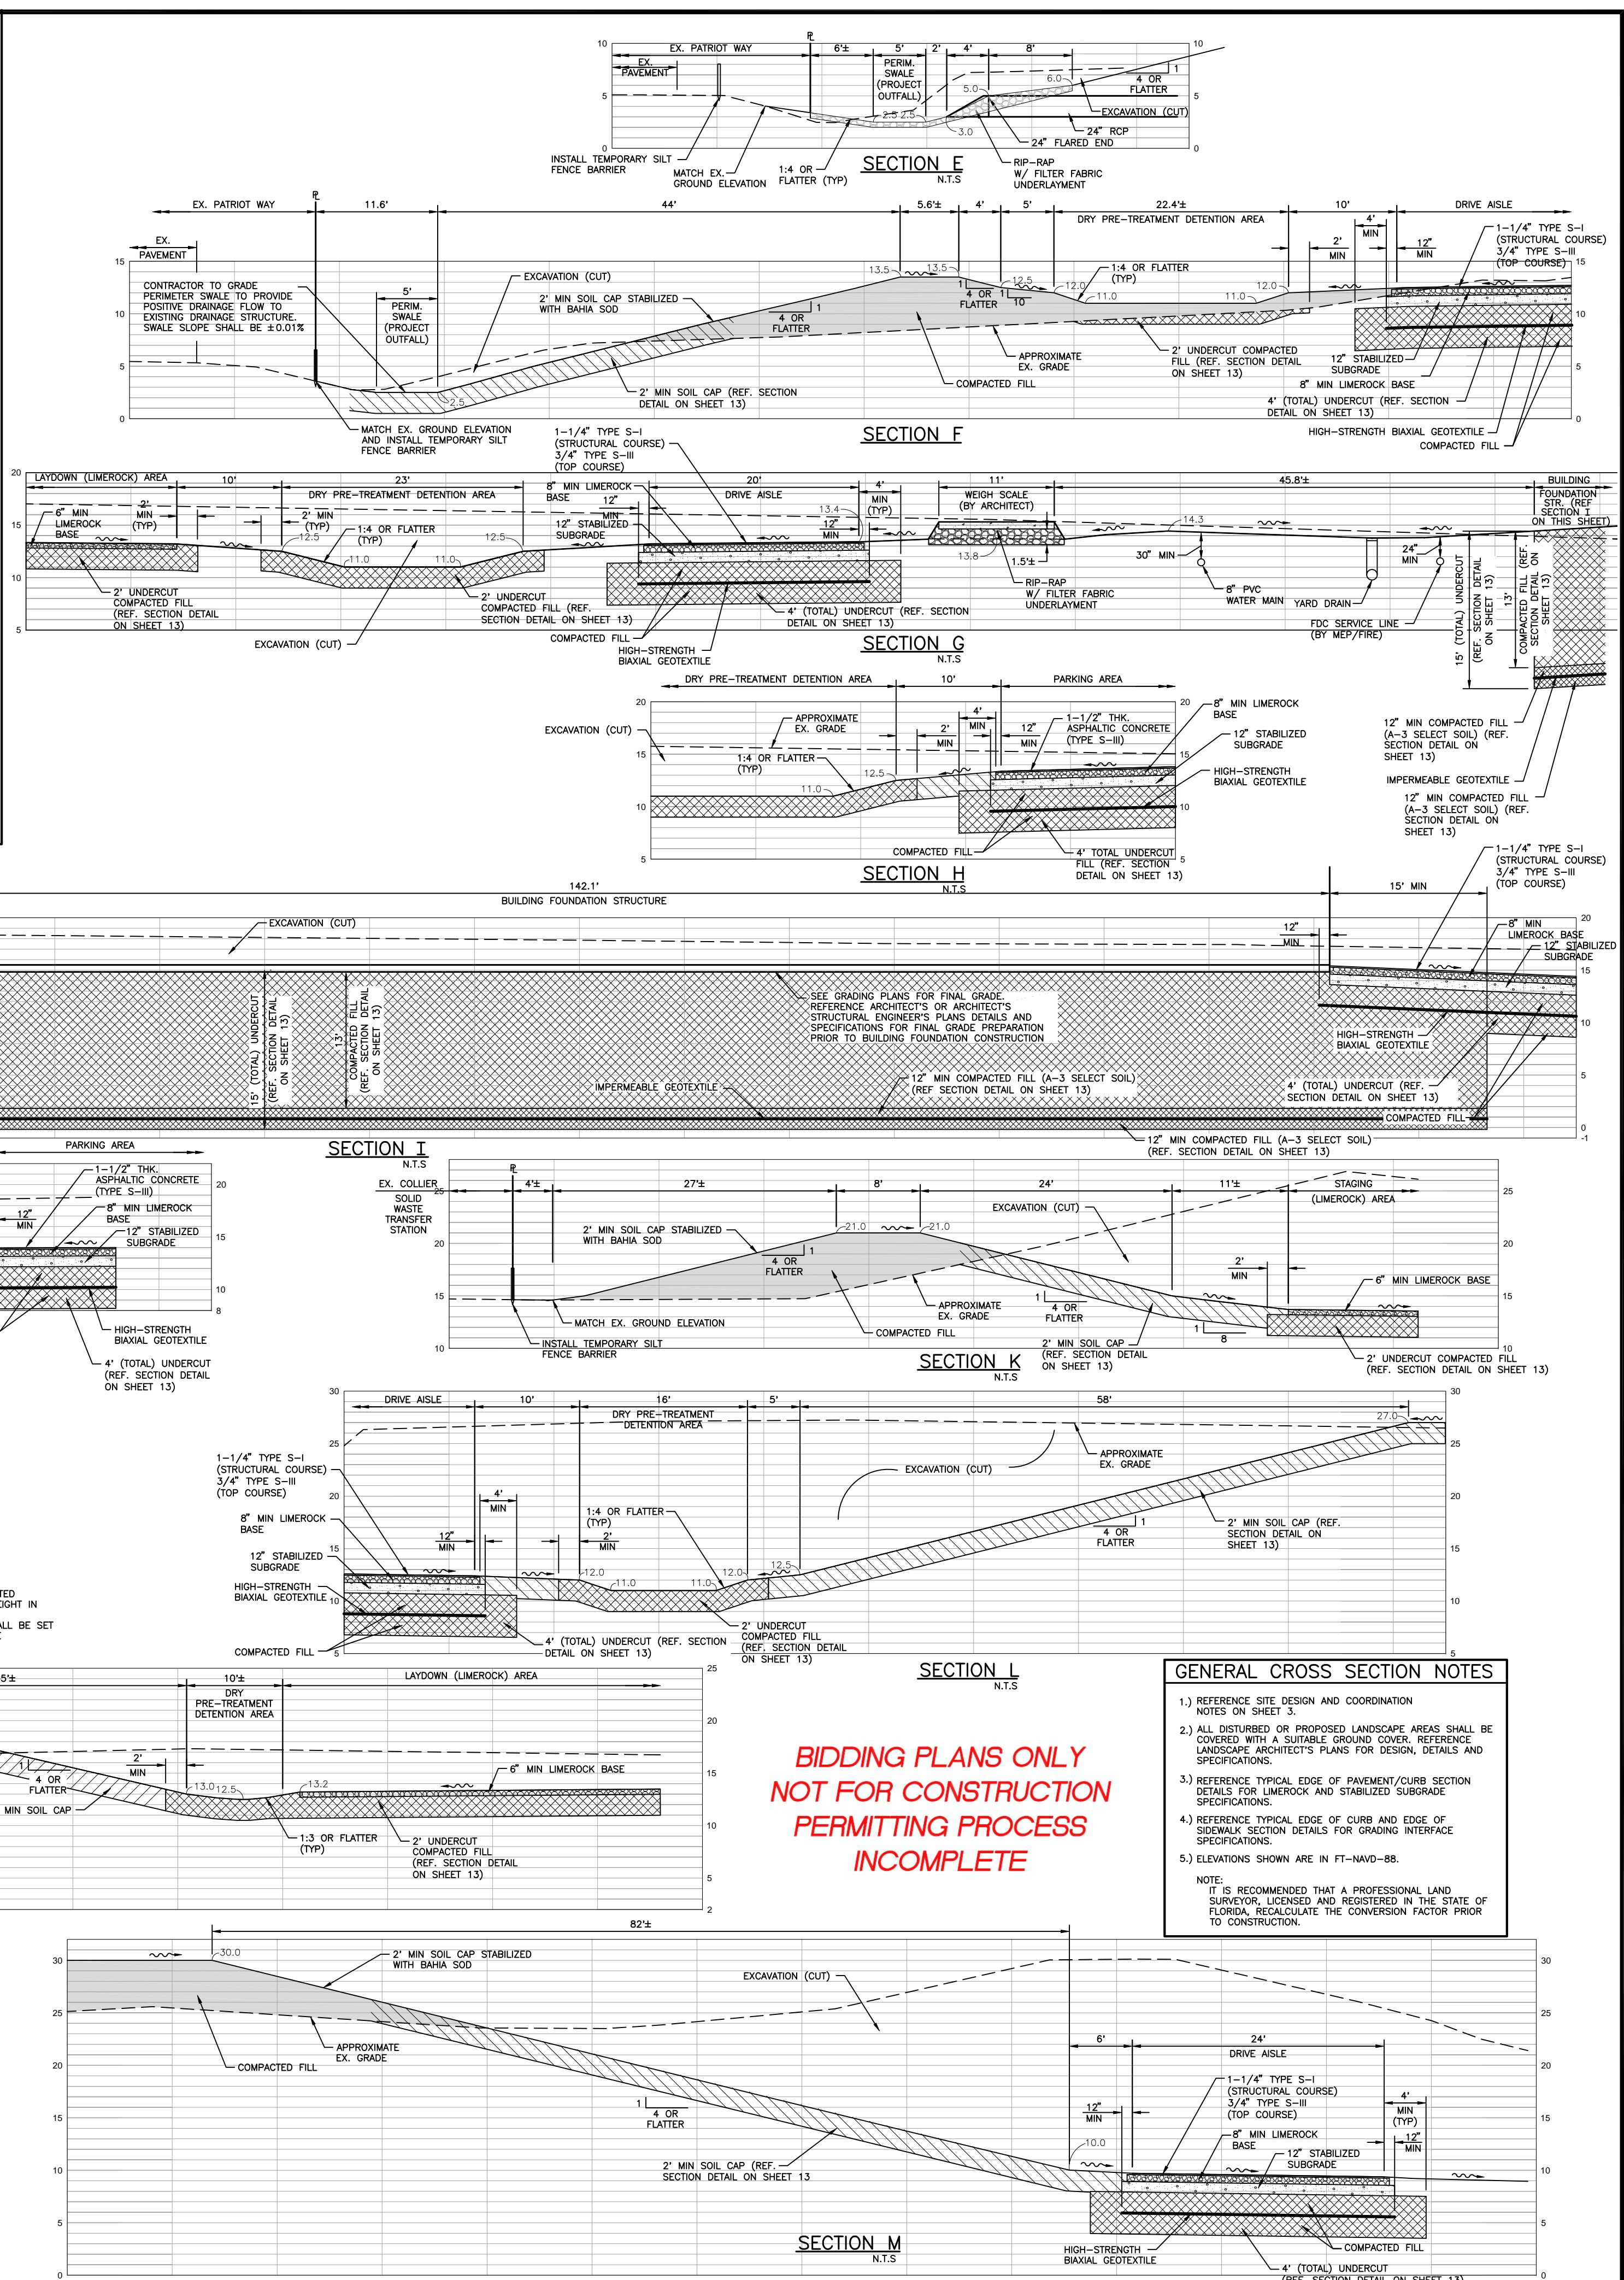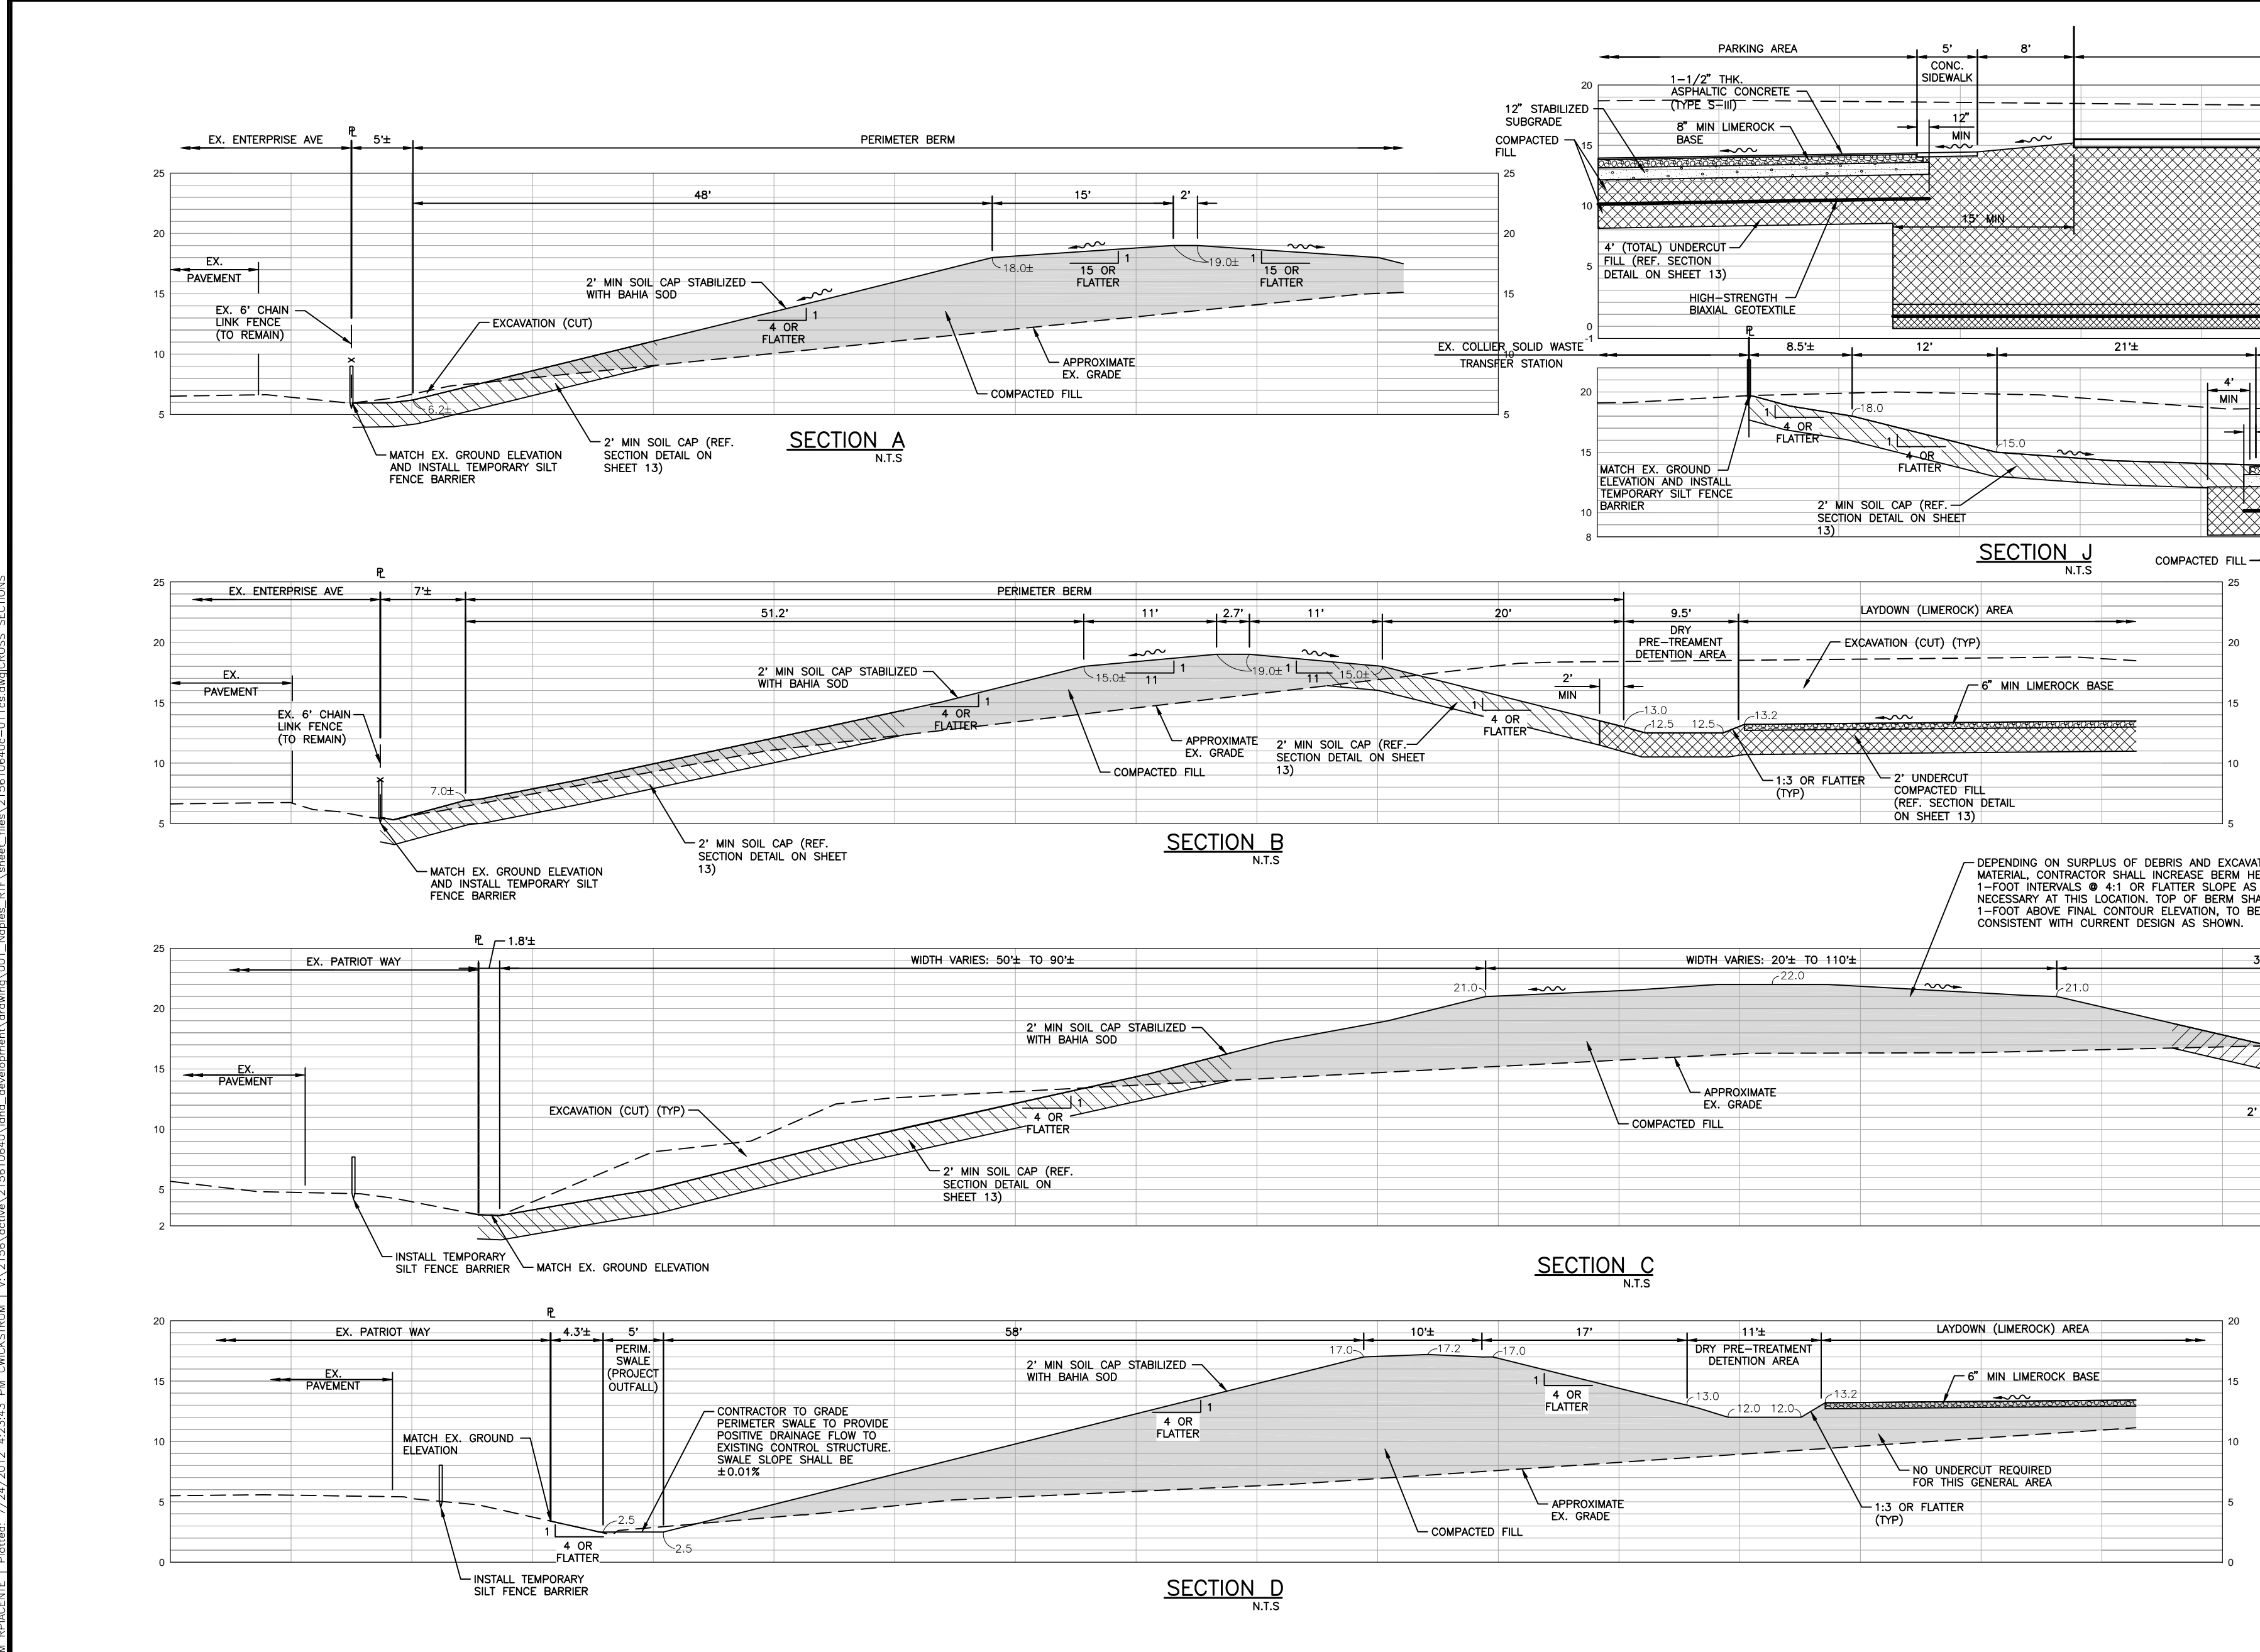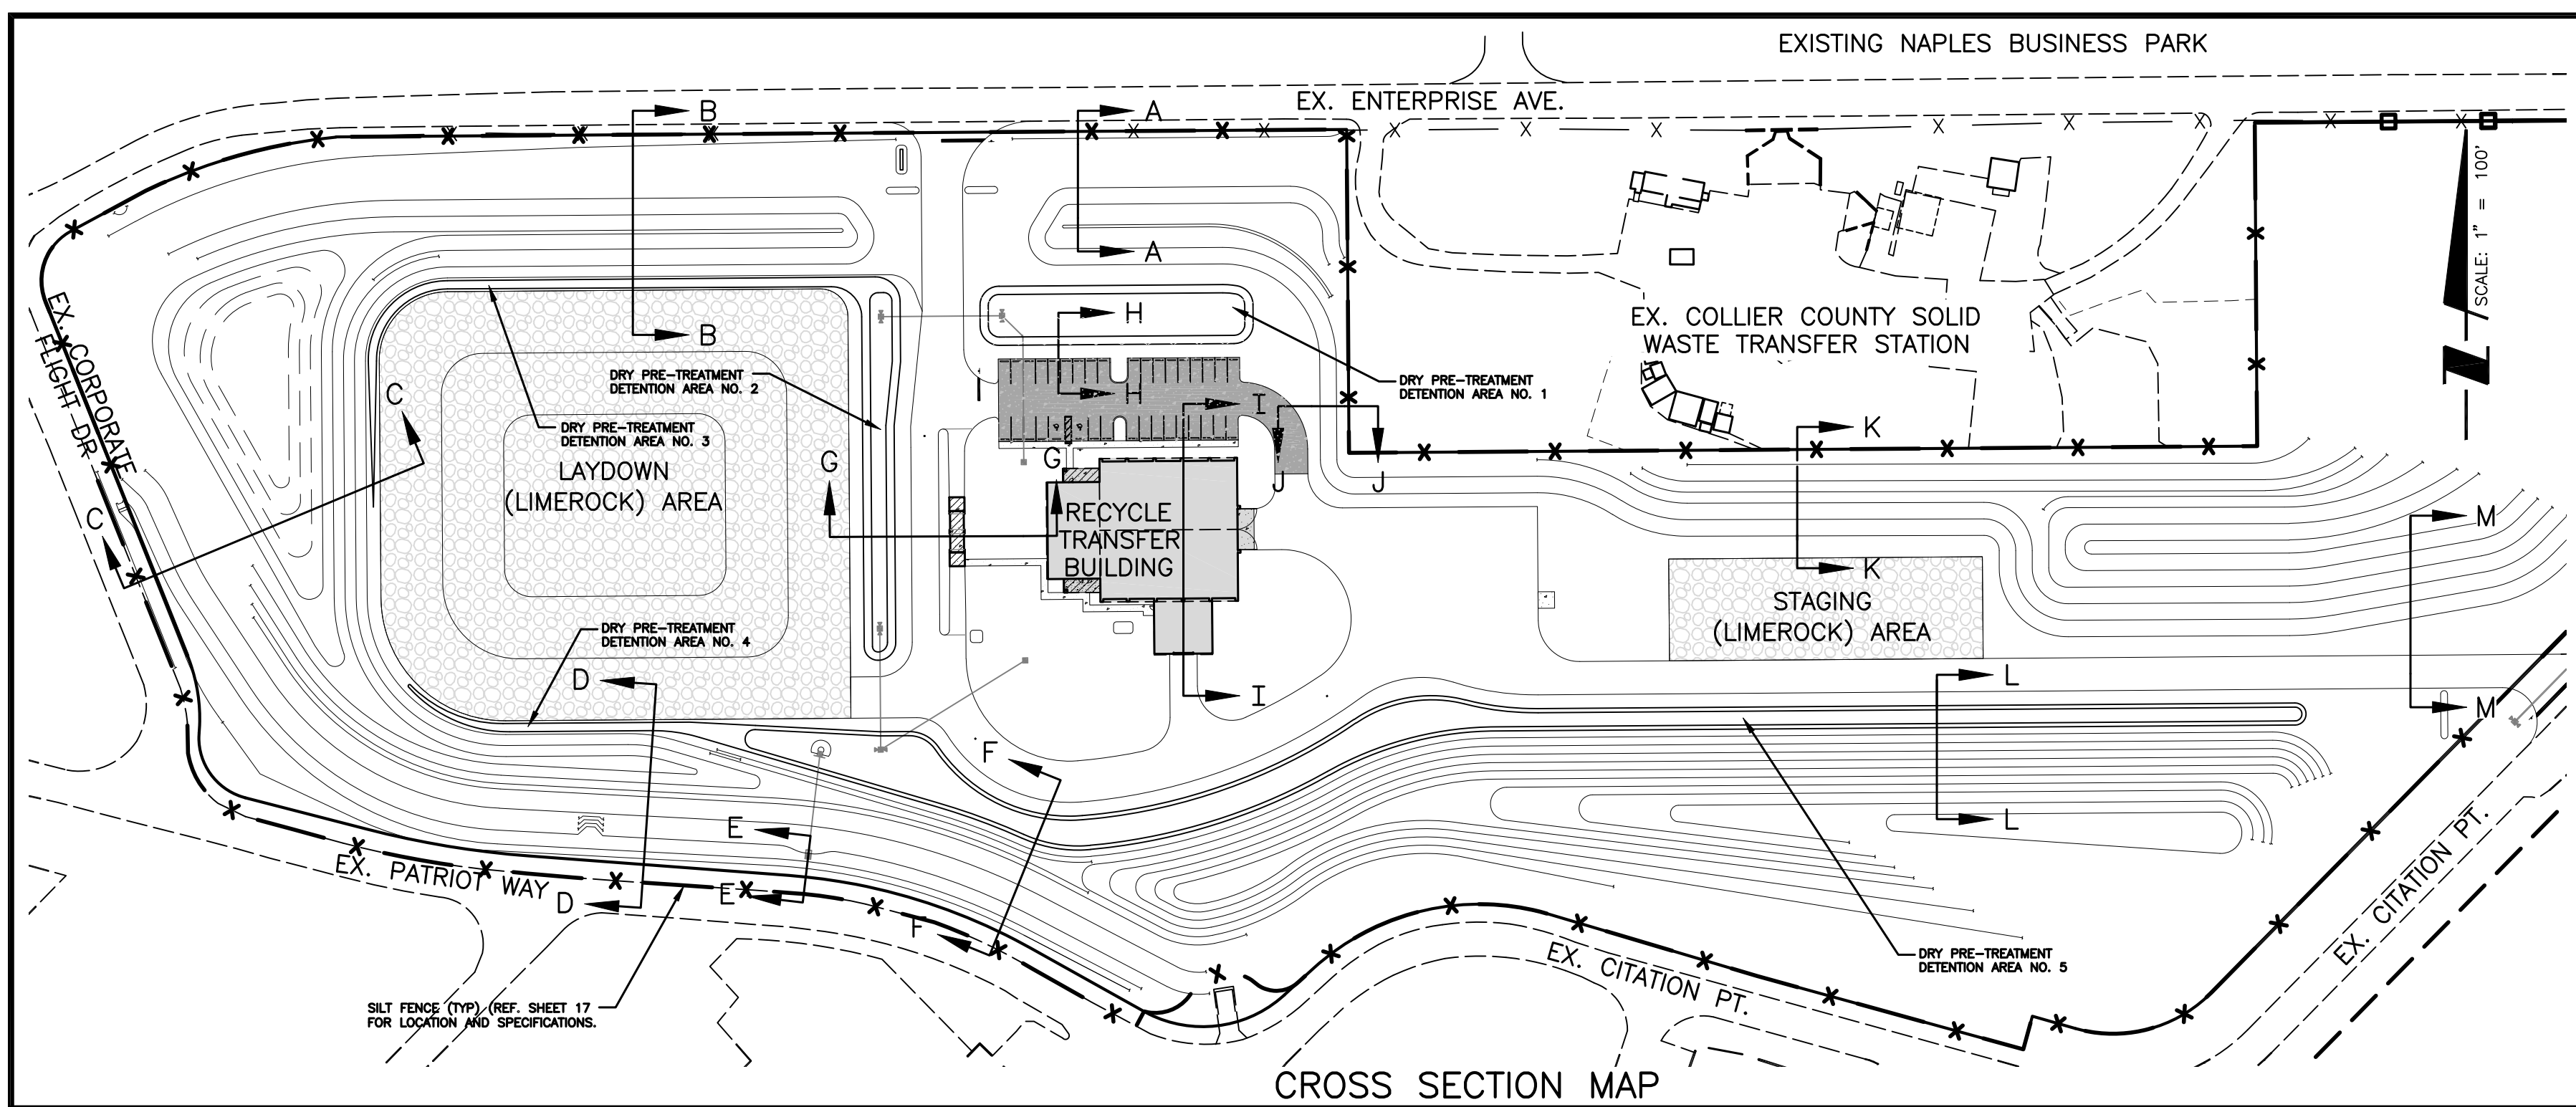
**BIDDING PLANS ONLY  
NOT FOR CONSTRUCTION  
PERMITTING PROCESS  
INCOMPLETE**

PROJECT: CITY OF NAPLES RECYCLE TRANSFER FACILITY CLIENT: CITY OF NAPLES PROJECT: CITY OF NAPLES RECYCLE TRANSFER FACILITY		ISSUE DATE: MAY 2012 ISSUE DESCRIPTION: DRY PRE-TREATMENT DETENTION AREA LEAD DESIGNER: CMW 89458 LEAD TECHNICIAN: CMW 89458		PROJECT NUMBER: 215610640-011cs SHEET NUMBER: 11 OF 17	
2, 505, 25E SEC-TWP-RGE		3200 Bailey Lane, Suite 200 Naples, FL 34105-8507 800.643.4336 • 239.649.4040 • F 239.643.5716 Certificate of Authorization #43 • FL Lic. # LC-0000170 • www.stantec.com		PROJECT NUMBER: 215610640 SHEET NUMBER: 11 OF 17	







DESIGN CONFIGURATION 1

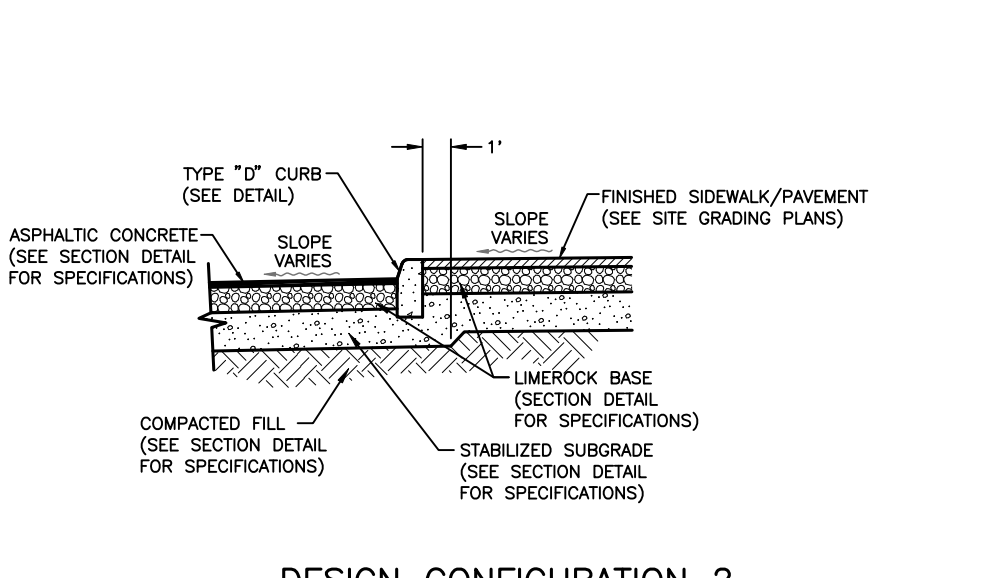

DESIGN CONFIGURATION 2

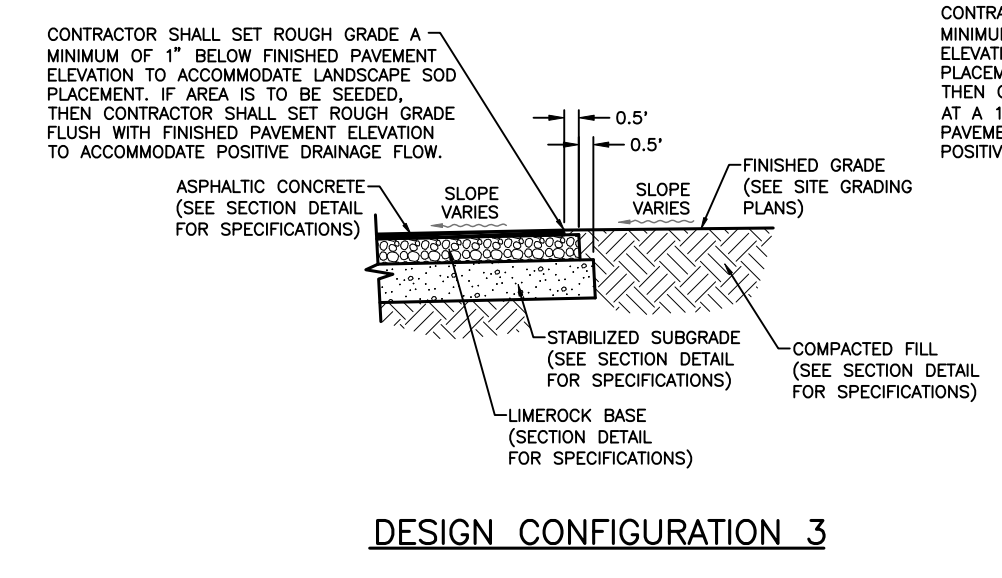


DESIGN CONFIGURATION 3

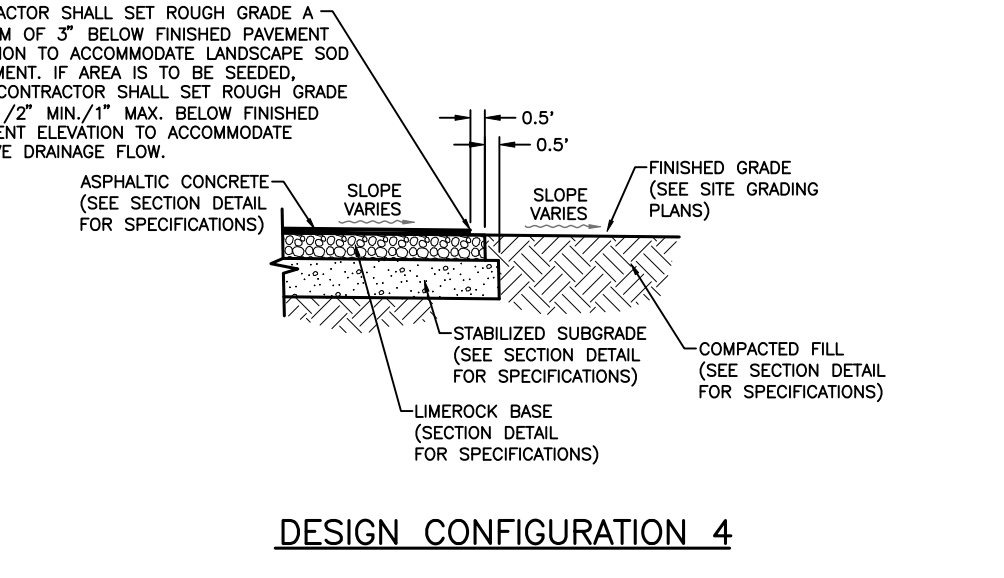


DESIGN CONFIGURATION 4

**TYPICAL EDGE OF PAVEMENT/CURB SECTION DETAILS**

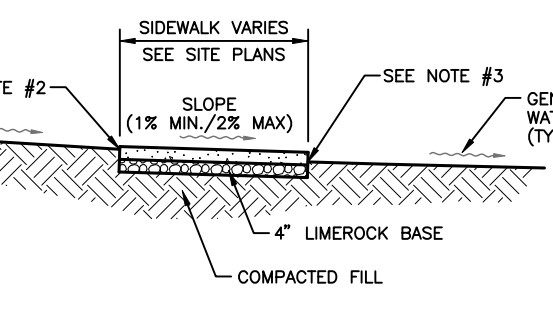


**TYPICAL CONCRETE DUMPSTER PAD & FUTURE WASH-DOWN BUILDING STRUCTURE FOUNDATION UNDERCUT SECTION DETAIL**

**TYPICAL ASPHALT PAVEMENT PARKING (AISLE & STALL) SECTION DETAIL**


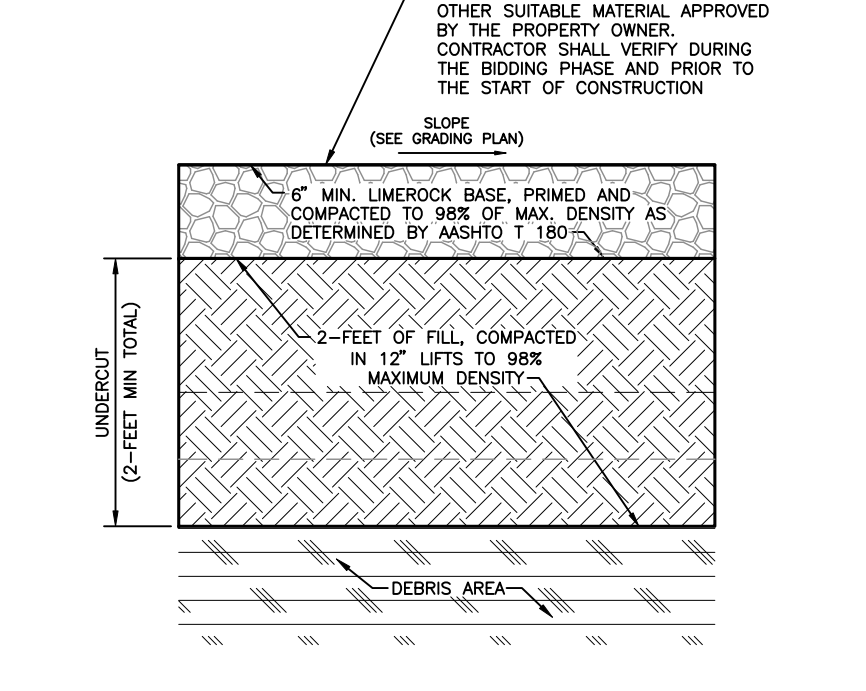


**TYPICAL BUILDING FOUNDATION STRUCTURE UNDERCUT SECTION DETAIL**

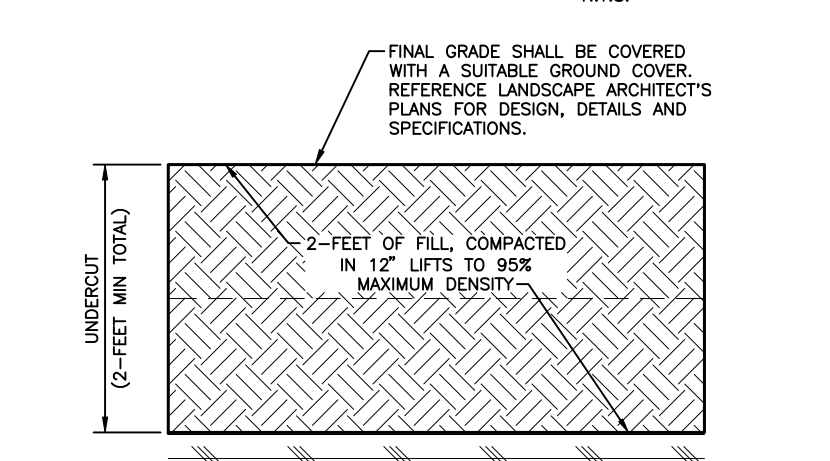


GROUP	LAYER TYPE	LAYER COEFFICIENT	LAYER THICKNESS (INCHES)	SN
FRICITION COURSE	NONE	N/A	0	0
STRUCTURAL COURSE (TOP COURSE)	TYPE S-II (SP 9.5)	0.44	7.5	0.33
STRUCTURAL COURSE (TOP COURSE)	TYPE S-I (SP 12.5)	0.44	1.25	0.55
BASE COURSE	LIMEROCK (LBR 100)	1.18	8	1.44
STABILIZATION	TYPE B (LBR 40)	0.08	12	0.96
SUBGRADE	NONE	N/A	N/A	0
TOTAL SN				3.28

**TYPICAL ASPHALT PAVEMENT VEHICULAR USE (ROAD & ACCESS WAY) SECTION DETAIL**

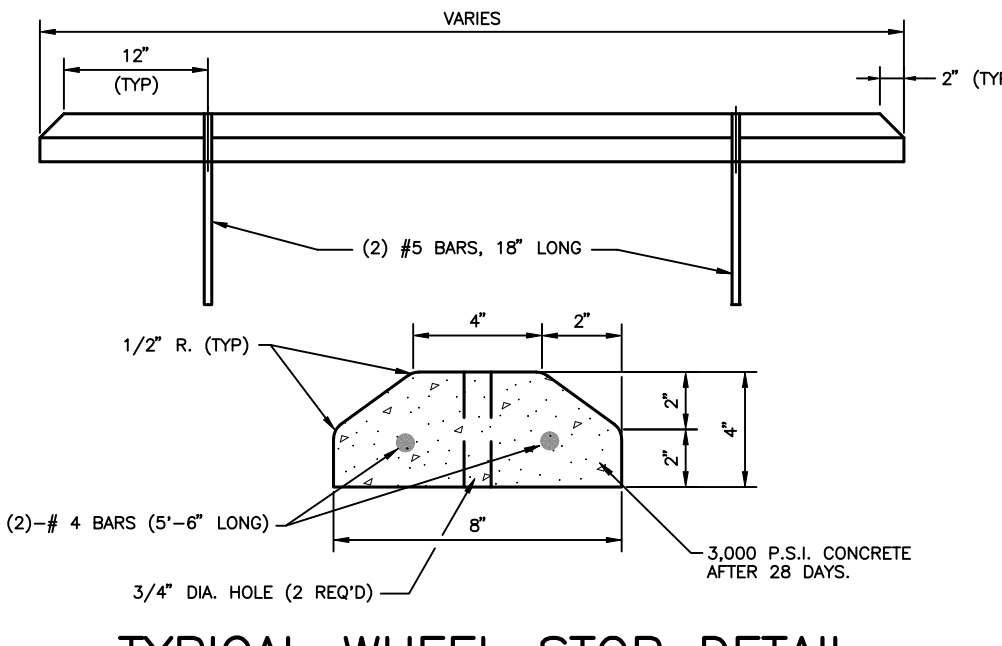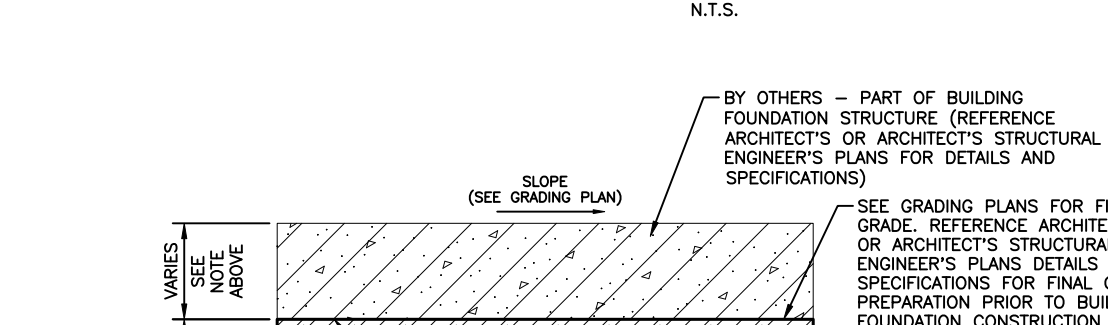


TYPICAL WHEEL STOP DETAIL


**TYPICAL EDGE OF SIDEWALK SECTION DETAILS**

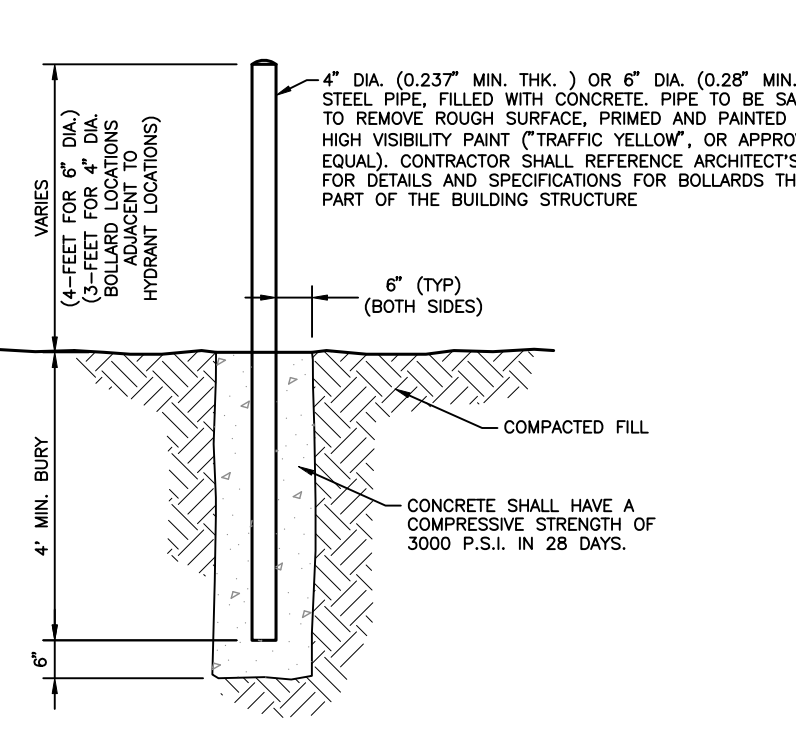


**TYPICAL CONCRETE SIDEWALK OR PAD SECTION DETAIL**

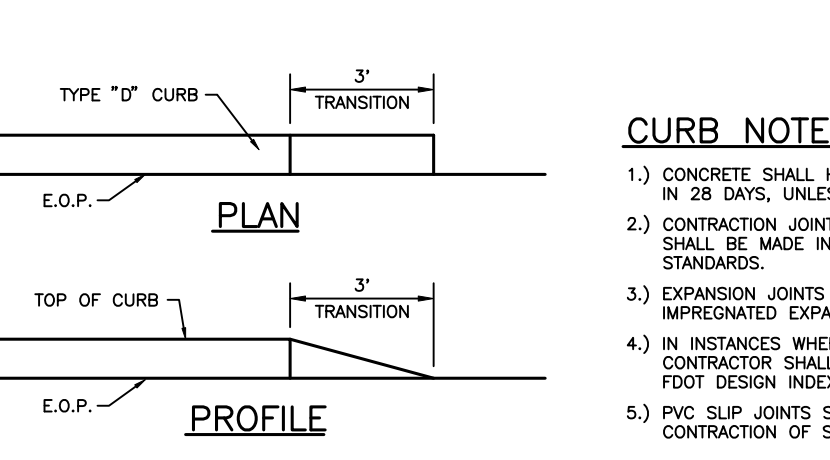



**TYPICAL LIMEROCK BASE VEHICULAR STAGING & LAYDOWN AREA SECTION DETAIL**

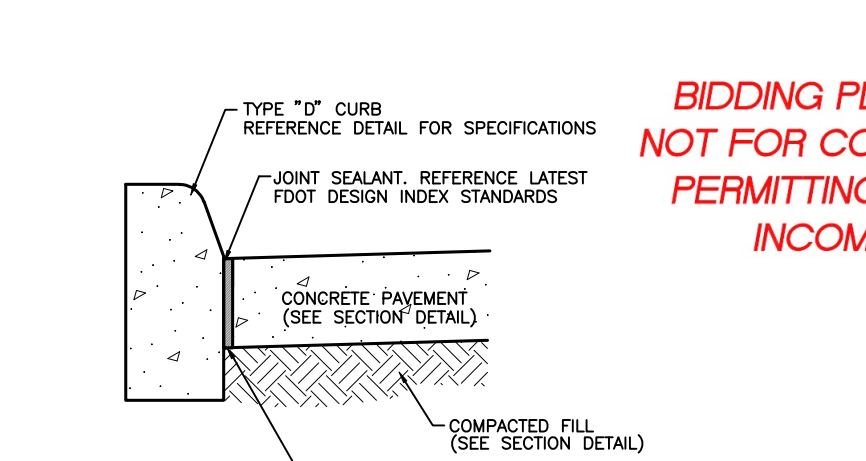


**TYPICAL WATER MANAGEMENT DETENTION AREA UNDERCUT SECTION DETAIL**

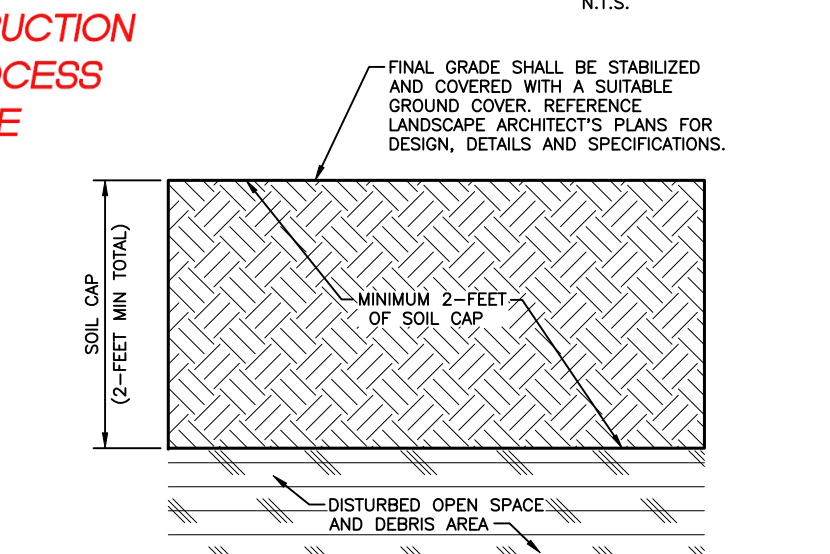


**TYPICAL CONCRETE PAVEMENT/APRON UNDERCUT SECTION DETAIL**

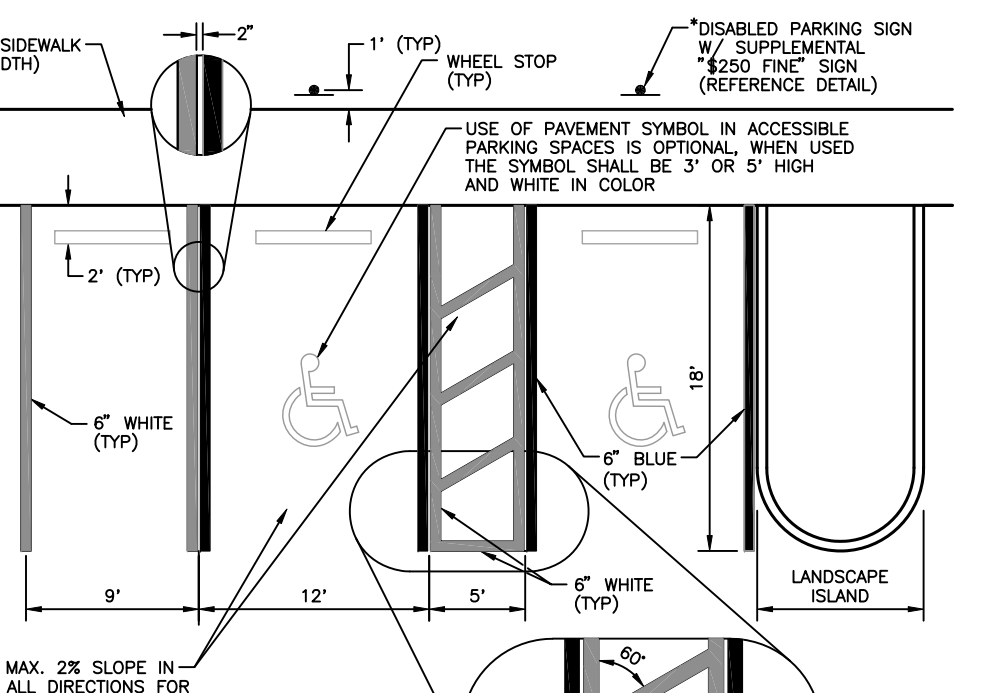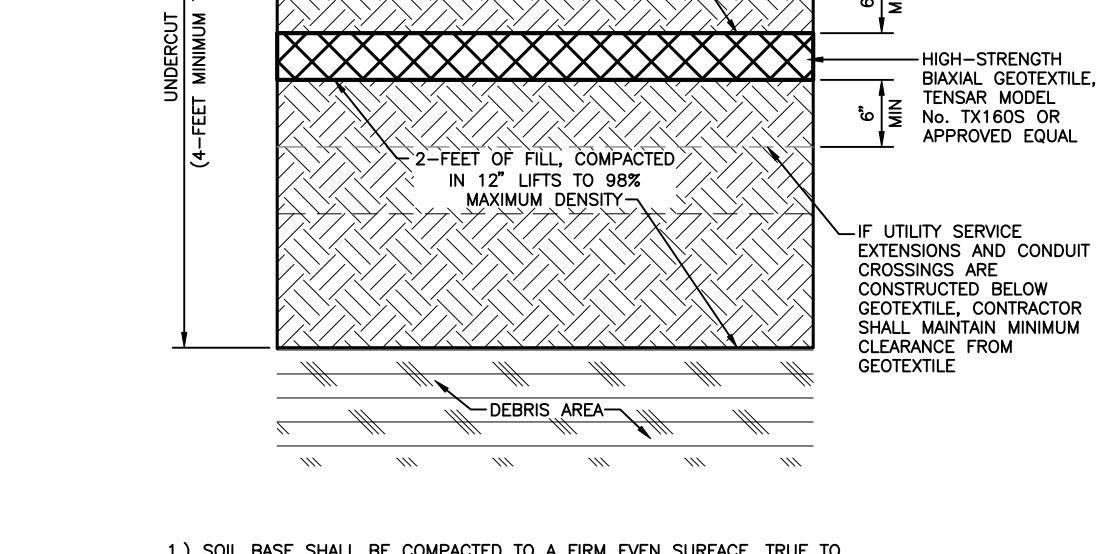


**TYPICAL NON-DECORATIVE BOLLARD (VEHICULAR GUARD POST) DETAIL**

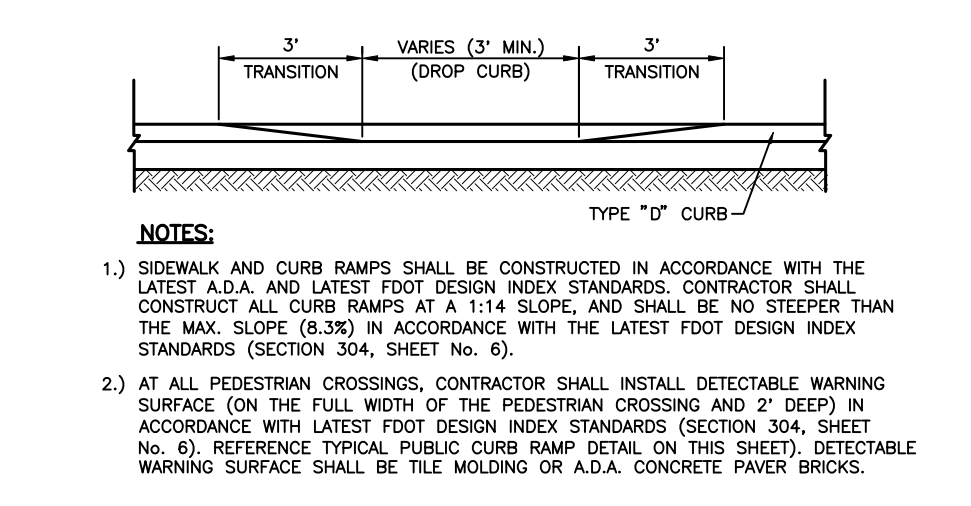


**TYPICAL TYPE "D" TRANSITION CURB DETAIL**

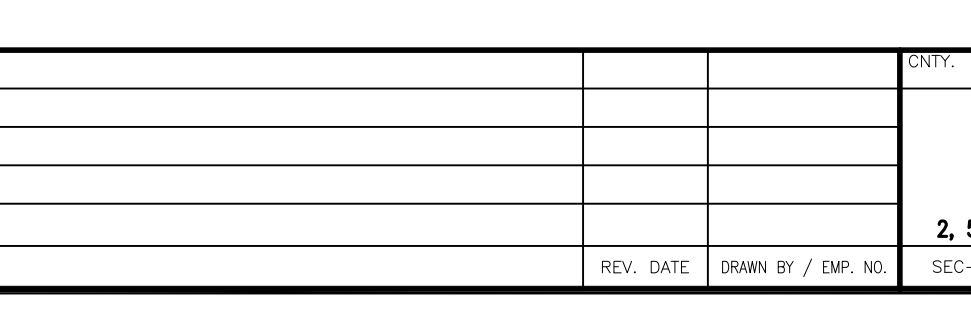


**TYPICAL TYPE "D" TRANSITION CURB DETAIL**

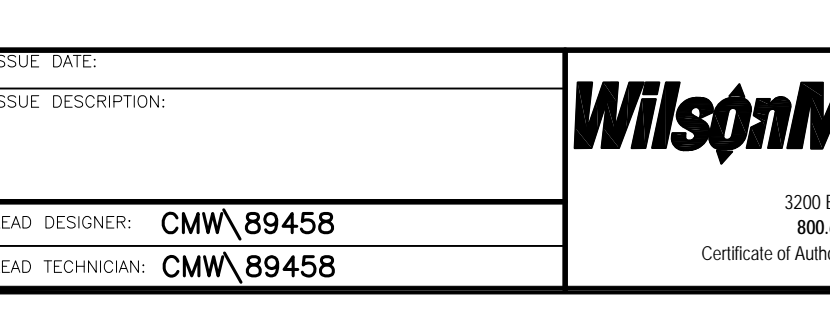



**CONCRETE PAVEMENT/CURB INTERFACE DETAILS**

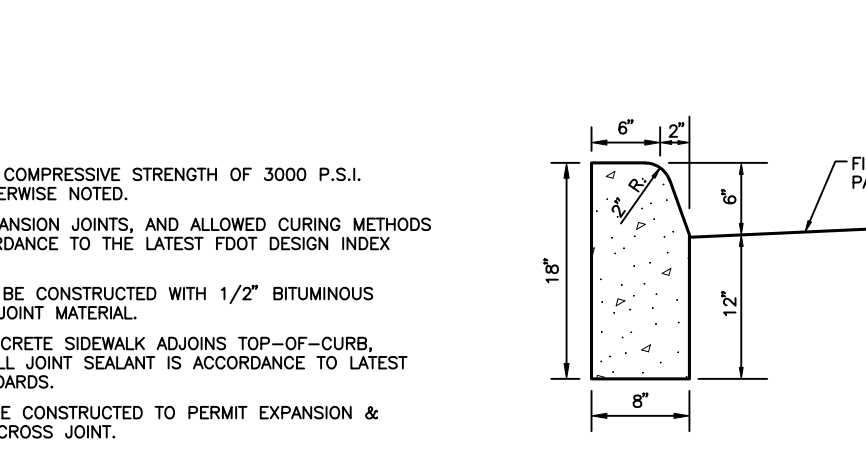

**TYPICAL SOIL CAP (DEBRIS & DISTURBED AREAS) SECTION DETAIL**

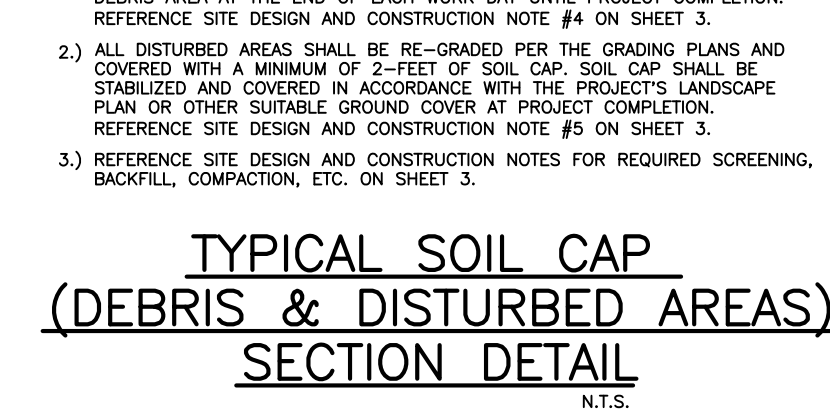


**TYPICAL CONCRETE PAVEMENT/APRON UNDERCUT SECTION DETAIL**

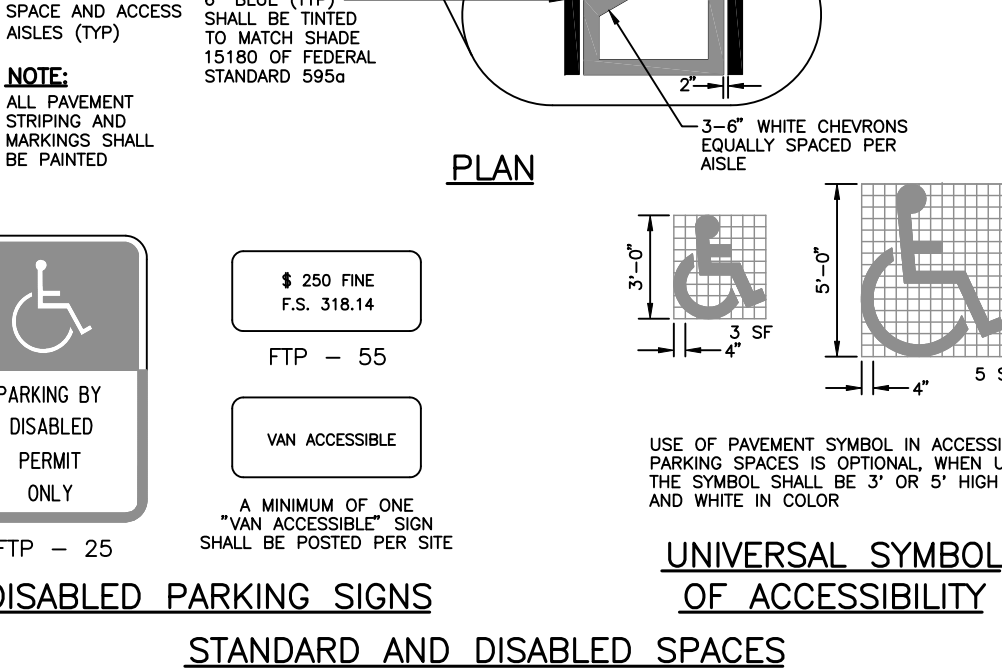
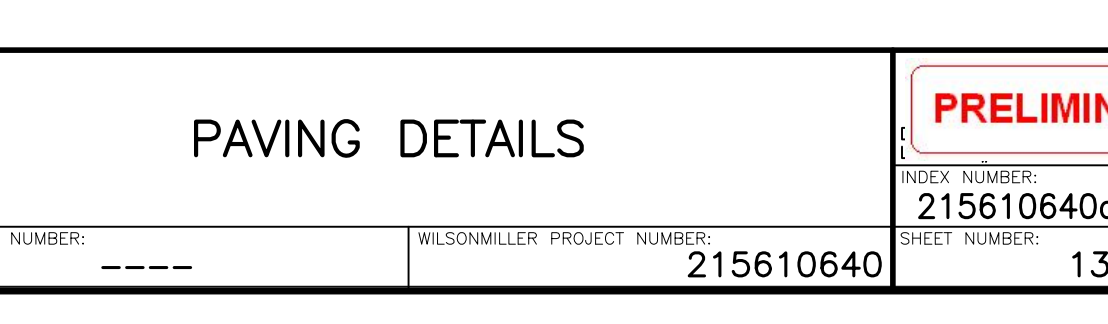


**TYPICAL 90° PARKING SPACE DETAIL**


**TYPICAL DROP CURB FOR A.D.A. ACCESSIBLE RAMP DETAIL**

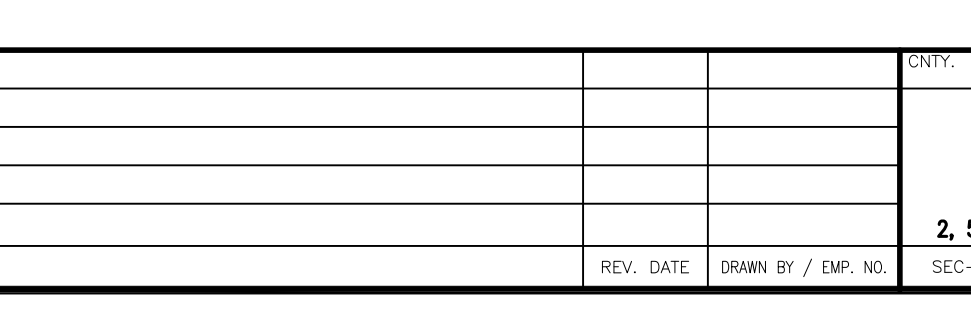


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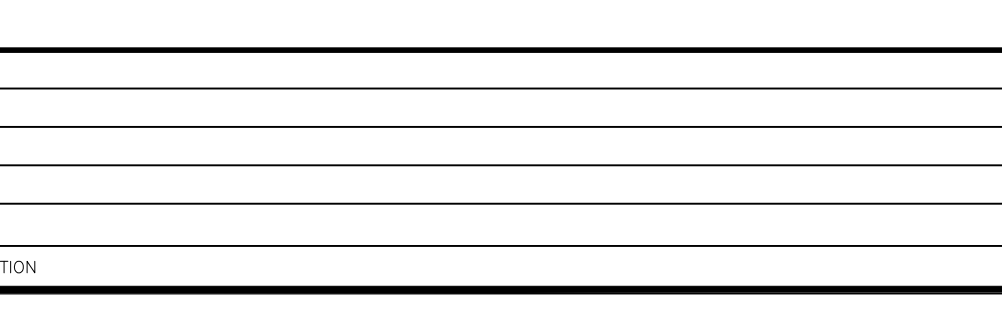
**TYPICAL SOIL CAP (DEBRIS & DISTURBED AREAS) SECTION DETAIL**

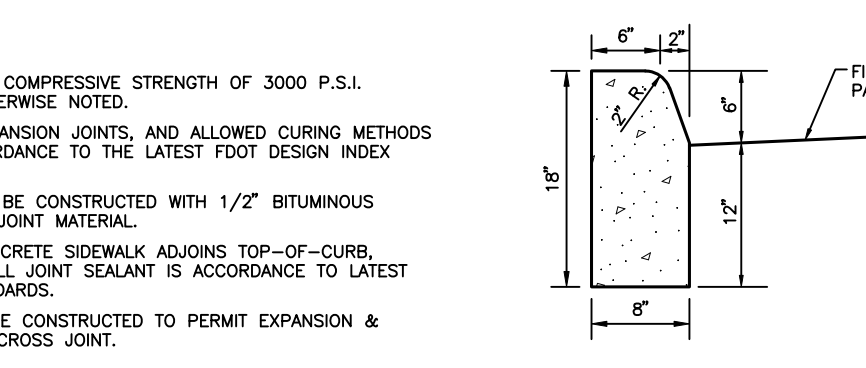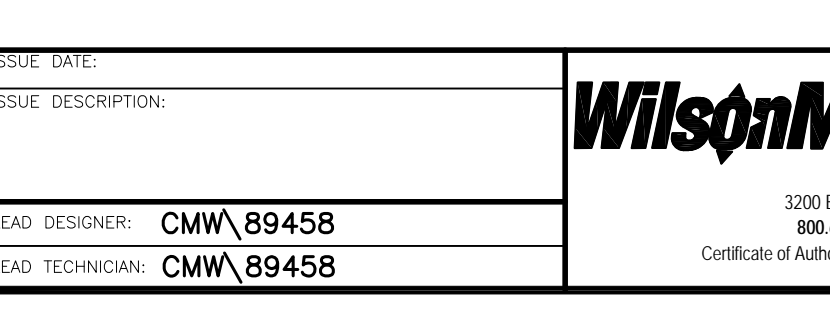


**TYPICAL CONCRETE PAVEMENT/APRON UNDERCUT SECTION DETAIL**

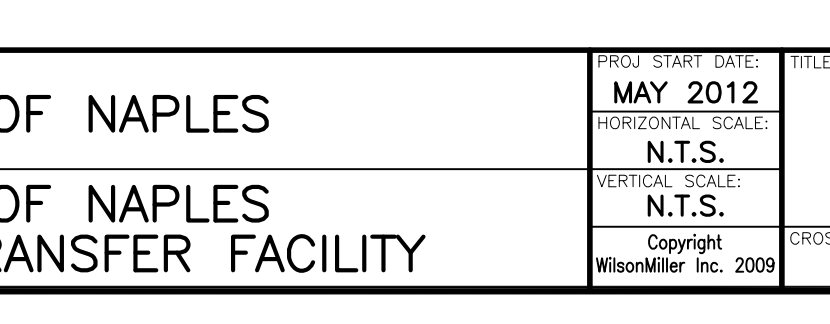



**DISABLED PARKING SIGNS**

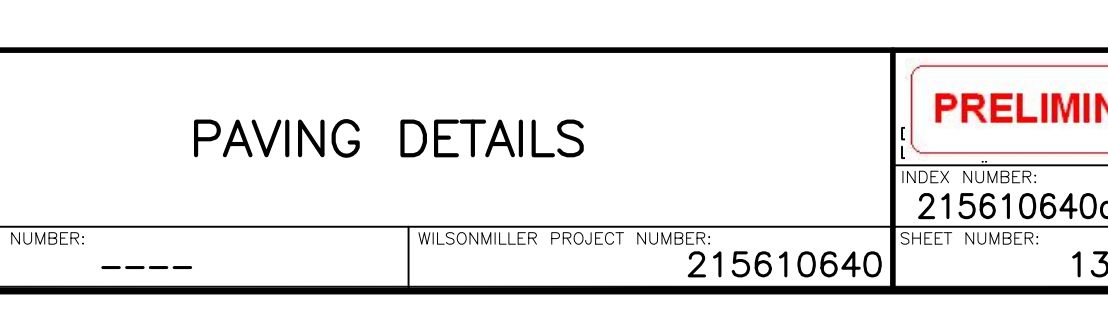


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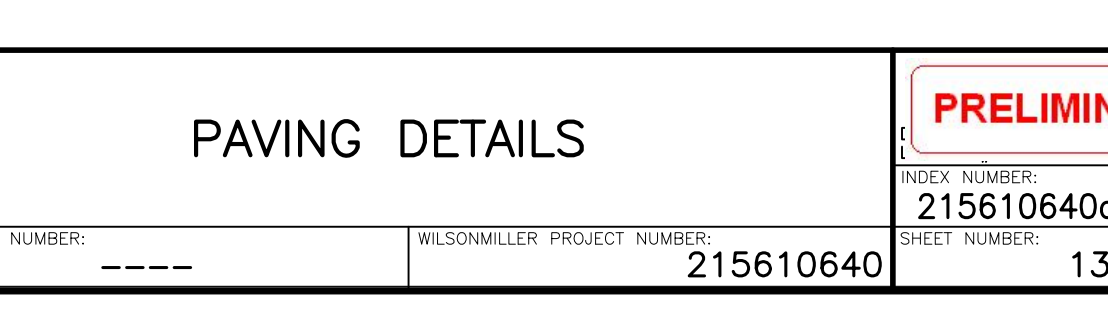
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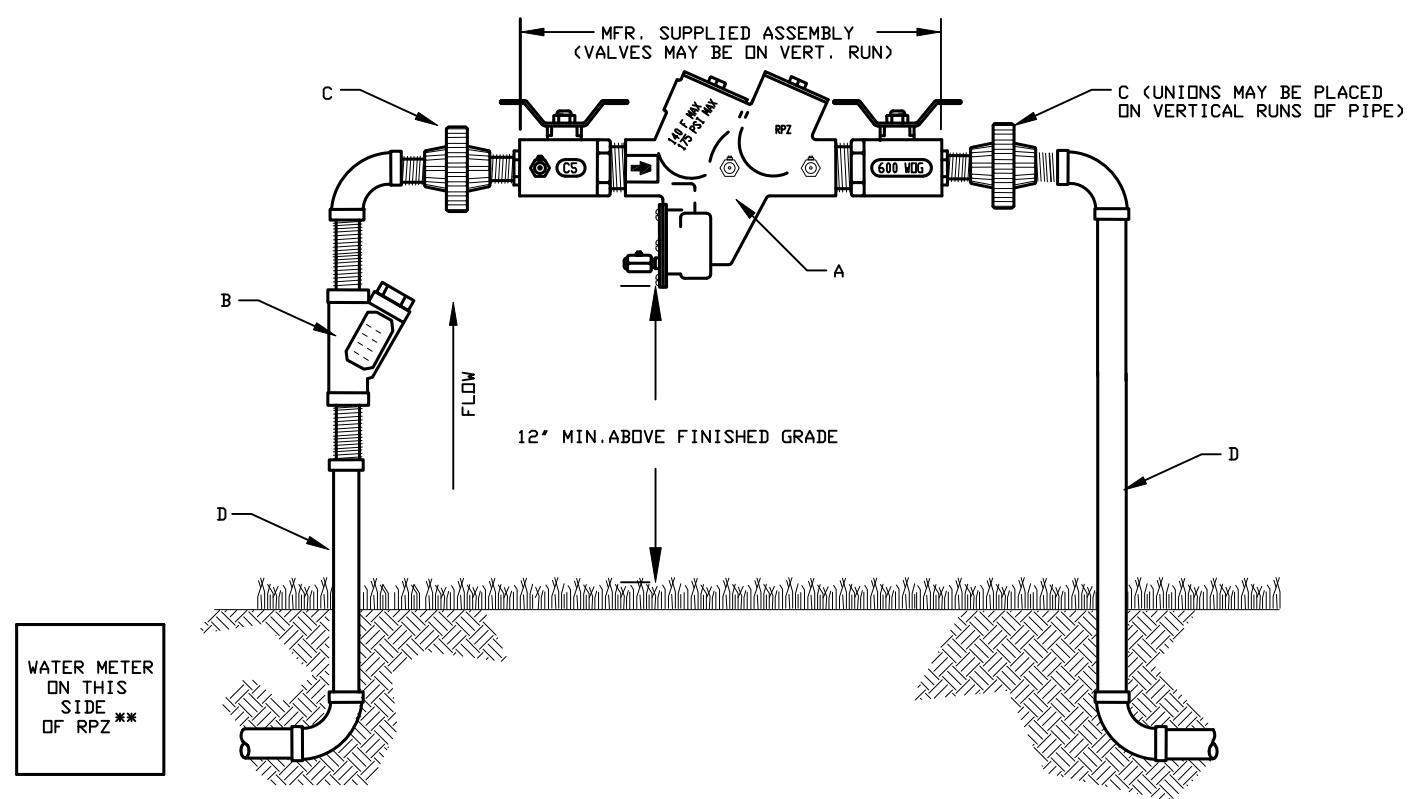


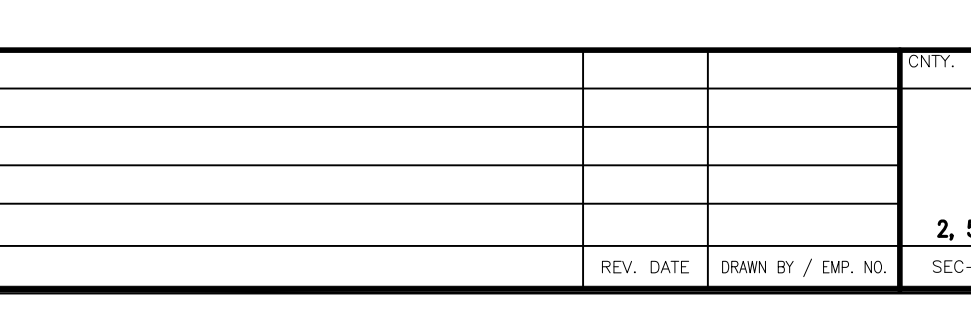**TYPICAL SOIL CAP (DEBRIS & DISTURBED AREAS) SECTION DETAIL**

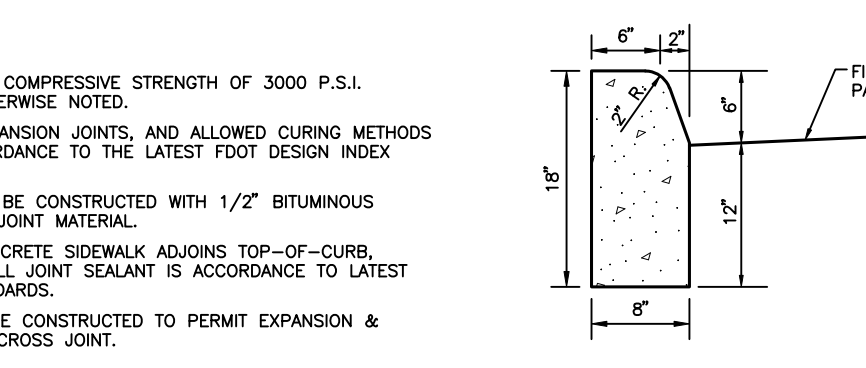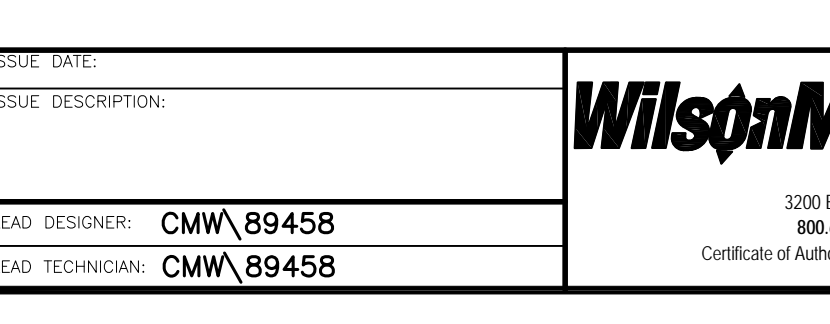



**TYPICAL CONCRETE PAVEMENT/APRON UNDERCUT SECTION DETAIL**



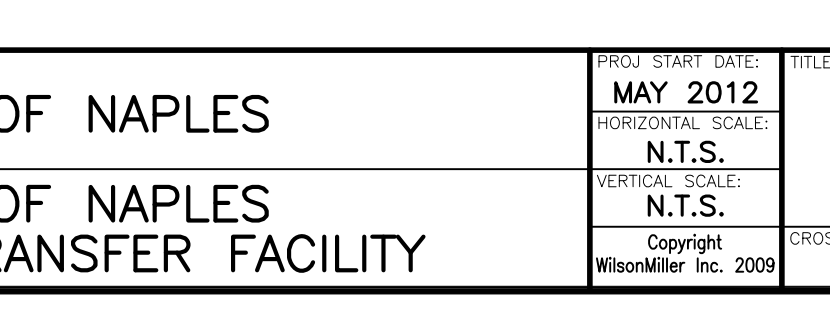



- NOTES:**
- 1) TO BE INSTALLED A MINIMUM OF 12" (INCHES) TO A MAXIMUM OF 30" (INCHES) OVER FINAL FINISHED GRADE, AS MEASURED TO THE LOWEST POINT OF THE RP ASSEMBLY, AND NO CLOSER THAN 12" (INCHES) TO ANY FIXED STRUCTURE.
  - 2) ALL PIPING FOR ASSEMBLY SHALL BE TYPE "K" COPPER OR BRASS.
  - 3) UNPROTECTED CONNECTIONS ARE PROHIBITED BETWEEN BACKFLOW PREVENTER AND METER.
  - 4) ADJUSTABLE PIPE STANDS WHERE REQUIRED.
  - 5) BACKFLOW UNIT REQUIRES INITIAL CERTIFICATION BY CITY OF NAPLES WATER DEPARTMENT (Backflow Division).
  - 6) ALL ABOVE GROUND PIPING INCLUDING ASSEMBLY WILL BE PAINTED RUSTLEUM FEDERAL SAFETY BLUE, OR PER CITY ORDINANCE 66-66H.

**3/4 TO 2" REDUCED PRESSURE BACKFLOW ASSEMBLY**  
W-01

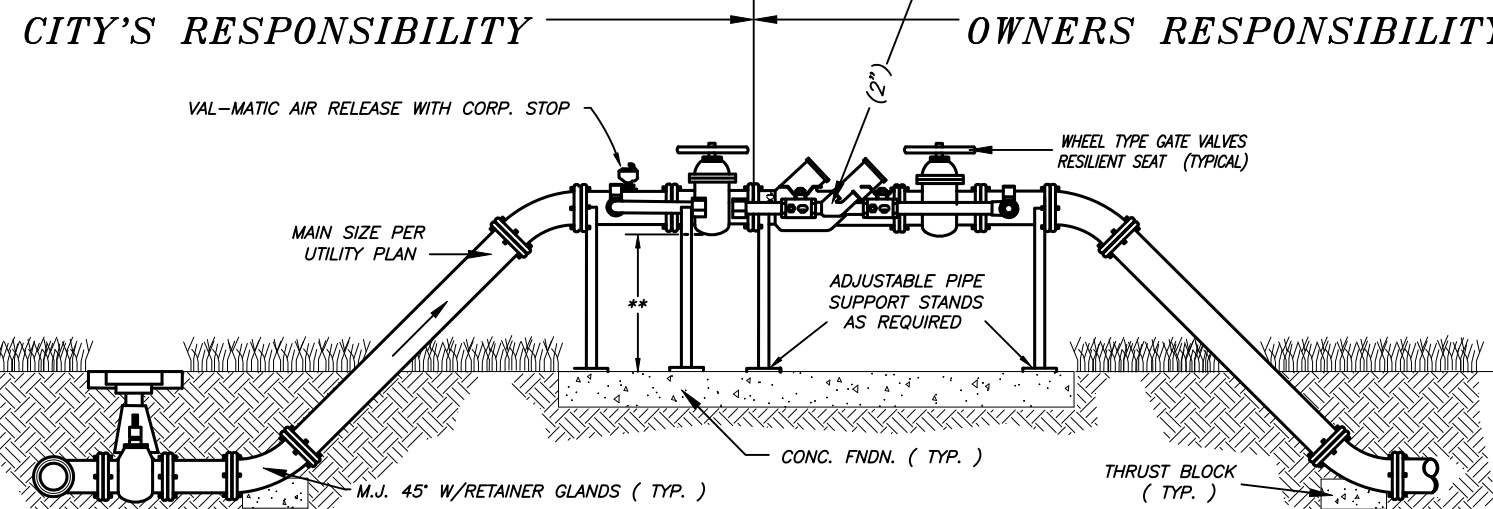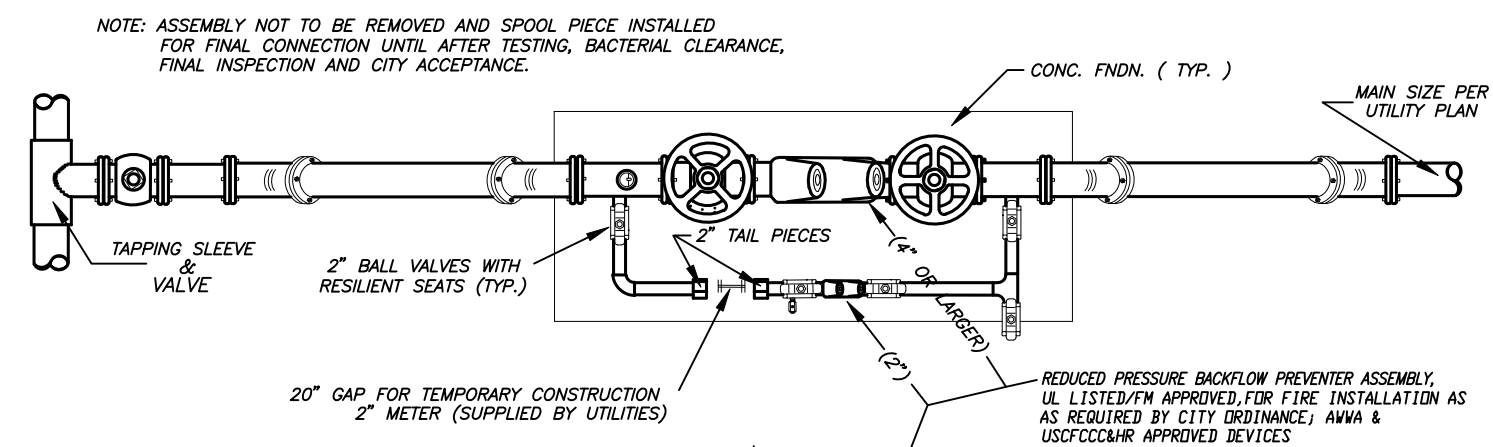


- NOTES:**
1. DO NOT INSTALL JUMPER PIPE & REMOVE BY-PASS UNTIL ALL TESTING & BACTERIAL CLEARANCE HAS BEEN OBTAINED
  2. ALL NEW PIPING SHALL BE PROPERLY RESTRAINED.

**TEMPORARY BACKFLOW PREVENTERS & CONSTRUCTION TIE-IN ASSEMBLY**  
W-05

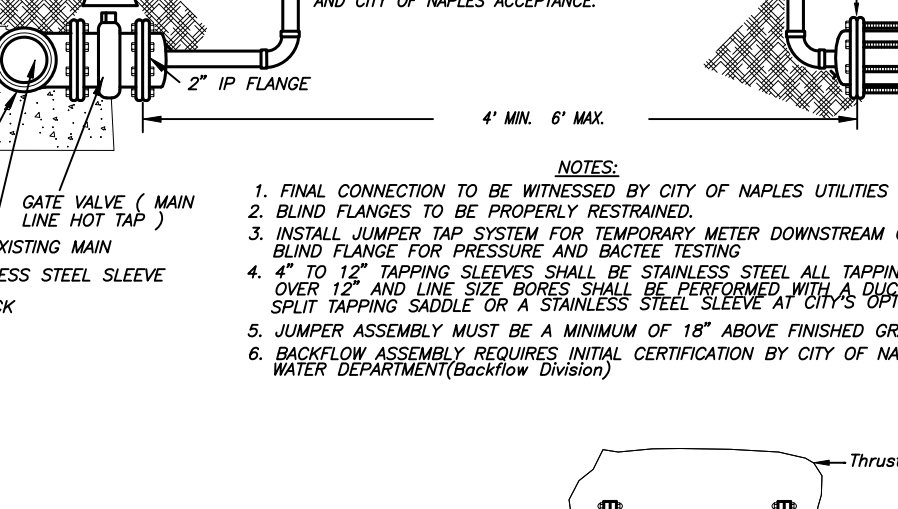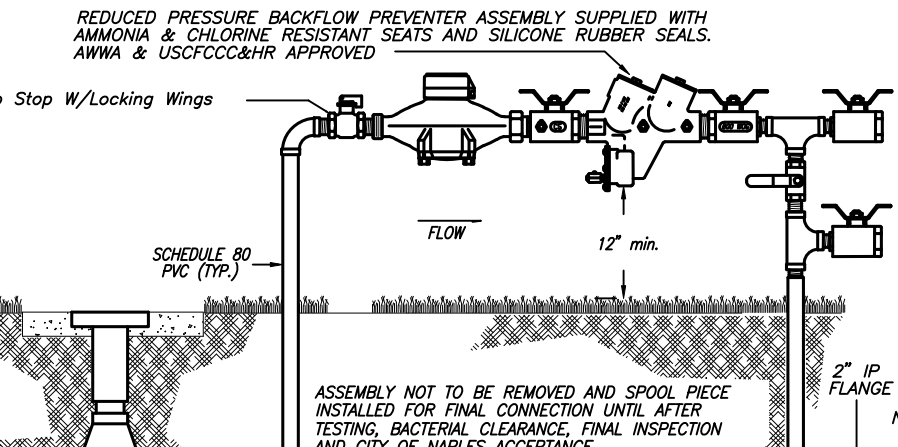


- NOTES:**
1. FINAL CONNECTION TO BE WITNESSED BY CITY OF NAPLES UTILITIES DIVISION.
  2. BLIND FLANGES TO BE PROPERLY RESTRAINED.
  3. INSTALL JUMPER TAP SYSTEM FOR TEMPORARY METER DOWNSTREAM OF BLIND FLANGE FOR PRESSURE AND BACTER TESTING.
  4. 4" TO 12" TAPPING SLEEVES SHALL BE STAINLESS STEEL ALL TAPPING SADDLES OVER 12" AND LINE SIZE BORES SHALL BE PERFORMED WITH A QUALITY IRON SPLIT TAPPING SADDLE ON A STAINLESS STEEL SLEEVE.
  5. JUMPER ASSEMBLY MUST BE A MINIMUM OF 18" ABOVE FINISHED GRADE.
  6. BACKFLOW ASSEMBLY REQUIRES INITIAL CERTIFICATION BY CITY OF NAPLES WATER DEPARTMENT (Backflow Division).

**TEMP. WATER SERVICE - HOTTAP & JUMPER METER CONNECTION**  
W-06



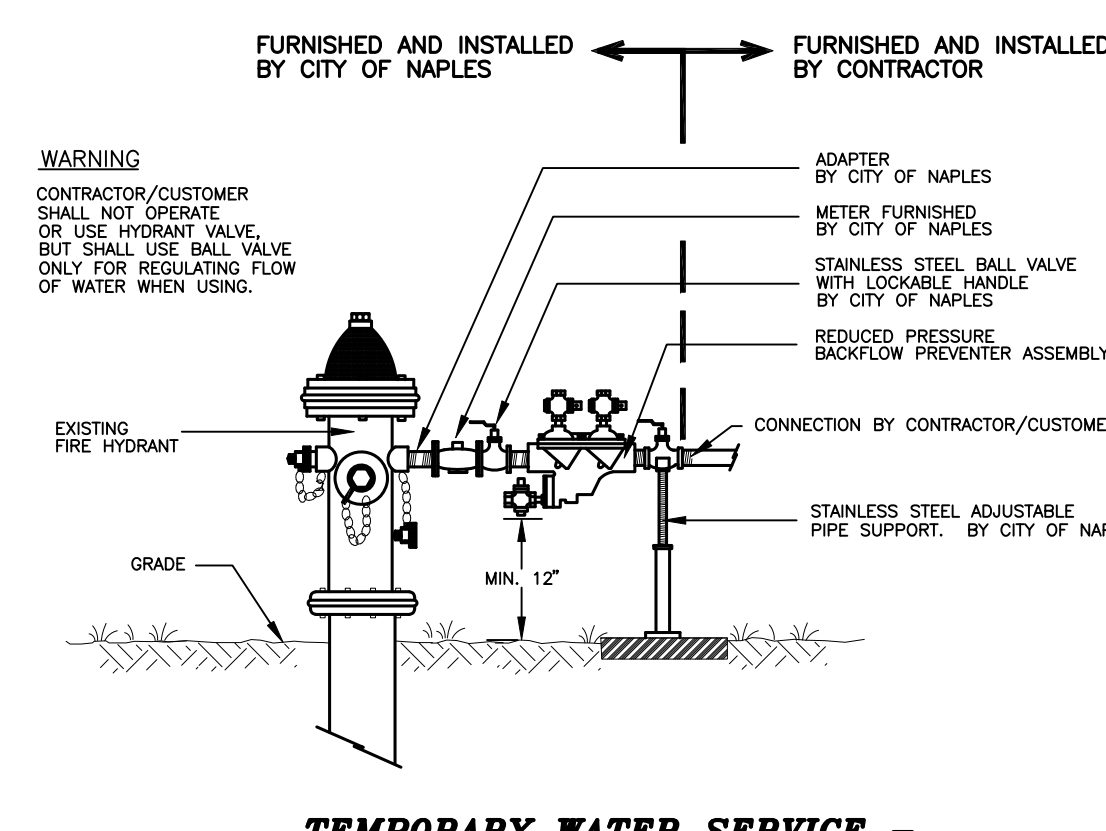


**TEMPORARY WATER SERVICE - FIRE HYDRANT CONNECTION**  
W-07

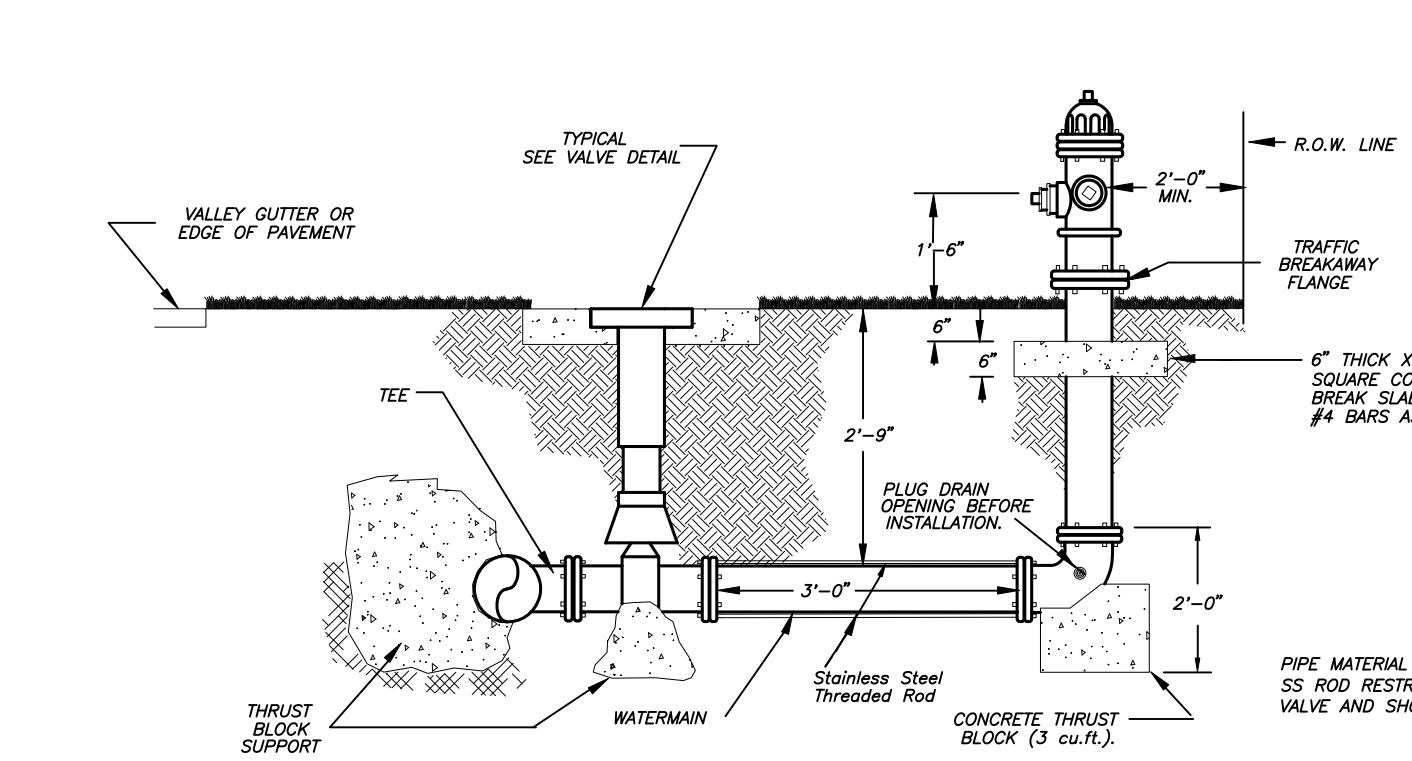


- NOTES:**
- 1) MANUFACTURE YEAR MUST BE CAST ON BARREL.
  - 2) SIX (6") TO 12" TAPPING SADDLE MAY BE EITHER 316 STAINLESS STEEL OR C.I. AT CITY ENGINEERS OPTION. ALL LINE SIZE TAPS AND THOSE OVER 12" SHALL BE C.I.
- CITY OF NAPLES FIRE HYDRANT REQUIREMENTS:**
- 1) All hydrants installed on City Water Mains shall meet AWWA C-502-85 (latest revision) & AWWA Manual M-17 for City Borel Fire Hydrants.
  - 2) All hydrants shall carry AWWA recommendations for uniform color coding as per Federal Standard 595. Fire jurisdiction shall dictate approved colors and paint after F.S.595A has been met. Private hydrants shall be so designated by fire jurisdiction regarding colors and schemes beyond F.S.595A.
  - 3) In addition to meeting AWWA City hydrants shall be UL/FM approved and equipped with (1) 4 1/2" pumper nozzle, (2) 2 1/2" hose nozzle, (3) 5 1/4" strainer main valve. Show interior and exterior shall be coated with a lead epoxy. Pumper nozzle and hose nozzle cap shall be secured with a lock key.
  - 4) Final landscaping/elevation/grade shall be a minimum 18" and maximum of 24" to the centerline of the pumper nozzle. All fencing, or other obstructions shall not be placed closer than 3' from hydrant to allow free unrestricted access.
  - 5) Upon hydrant installation, hydrant shall be flow tested as per AWWA M17 and appropriately color coded per Federal Standard 575A.

**HYDRANT DETAIL**  
W-10

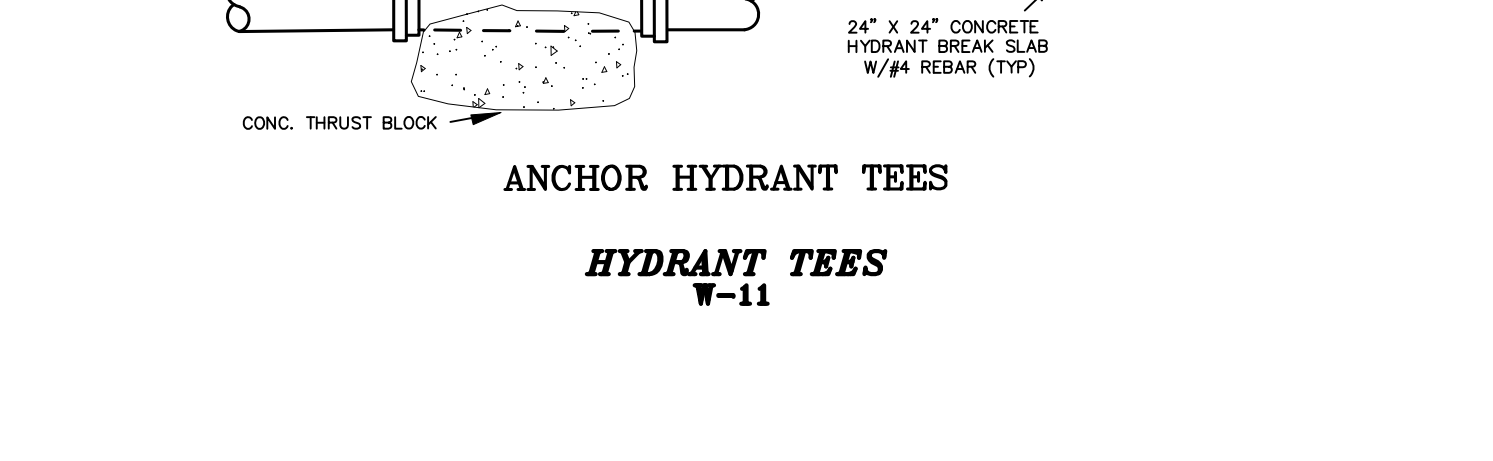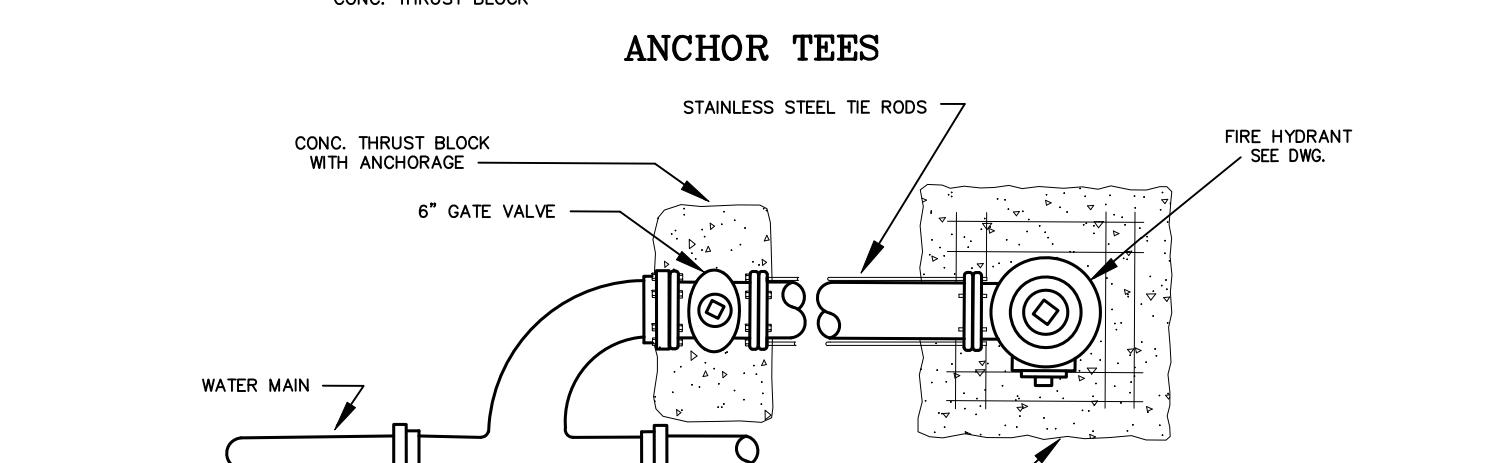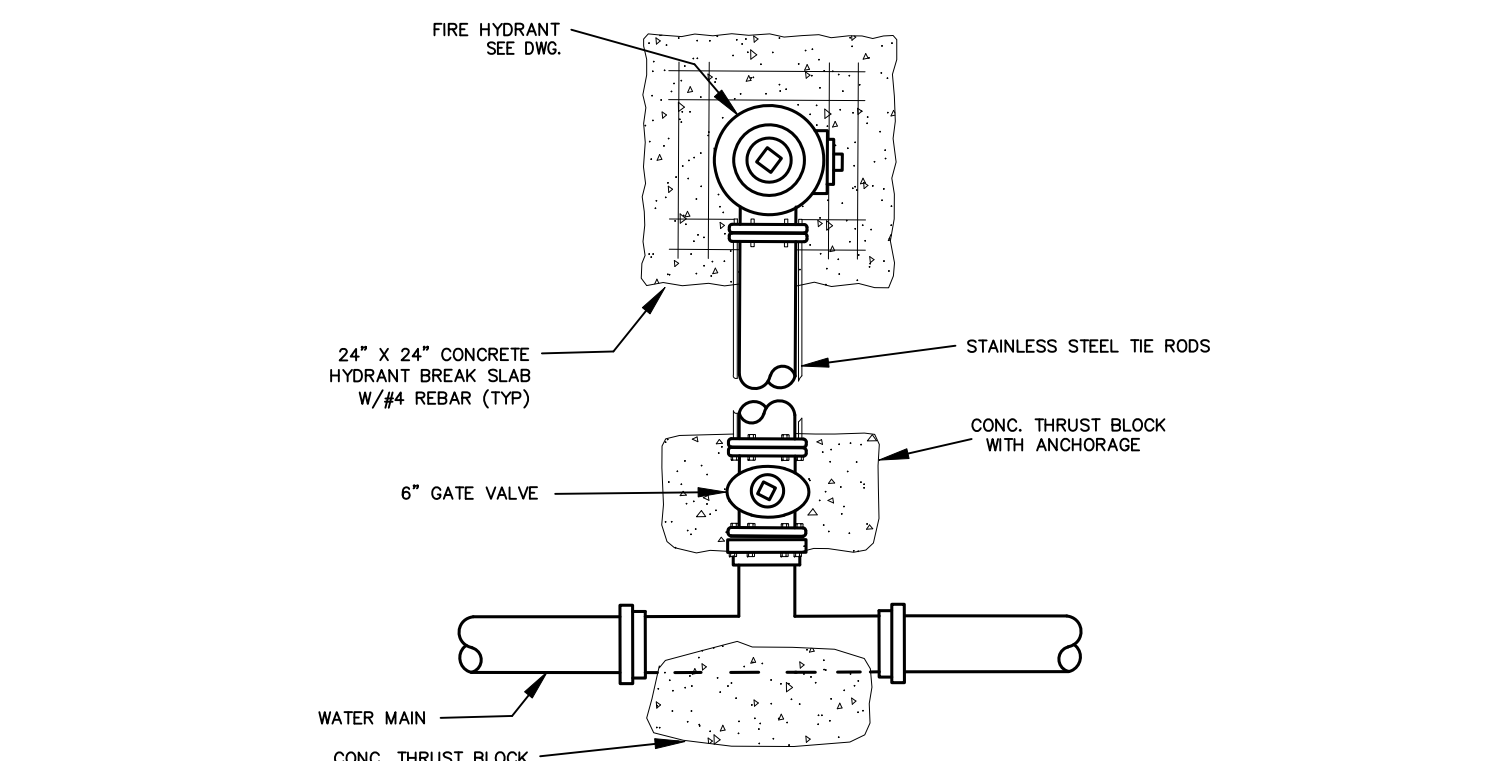

- NOTES:**
- 1) TAPPING SADDLES: Shall be Epoxy Coated Cast Iron with S.S. Straps and Bolts. AWWA approved with 1" or 2" FIP Thread pattern.
  - 2) CORPORATION STOPS: Shall be BRASS = (1" CC THREAD X Pack Joint) (2" Iron Pipe X Pack Joint)
  - 3) CURB STOPS: Shall be BRASS = (1" IRON PIPE X Pack Joint W/Locking Wings) (2" Iron Pipe X Pack Joint W/Locking Wings)
  - 4) TUBING: Shall be POLYETHYLENE, AWWA C-901, PE3408, SDR 9-200 & blue in color. Tubing sizes shall be 2" for long side, 1 1/2" for short side, and 2" for short side if a 1-1/2" or 2" meter exists short side.
  - 5) METER BOXES: 5/8" & 3/4" METERS REQUIRE A BROOKS & CARSON # 1419 PLASTIC METER BOX (MAINLY USED IN NONTRAFFIC AREAS) 5/8" & 3/4" METERS REQUIRE A BROOKS & CARSON #37 CONCRETE BOX W/TRAFFIC RATED LID (USED IN TRAFFIC AREAS) 1" & 1-1/2" METERS REQUIRE A BROOKS CARSON #324 PLASTIC METER BOX (MAINLY USED IN NONTRAFFIC AREAS) 1" METERS REQUIRE A BROOKS CARSON #38 CONCRETE BOX W/TRAFFIC RATED LID (MAINLY USED IN TRAFFIC AREAS) 1-1/2" METERS REQUIRE A BROOKS CARSON #86 CONCRETE BOX W/TRAFFIC RATED LID (USED IN TRAFFIC AREAS) 2" METERS REQUIRE A BROOKS CARSON #1730 PLASTIC METER BOX (MAINLY USED IN NON-TRAFFIC AREAS) 2" METERS REQUIRE A BROOKS CARSON #86 CONCRETE BOX W/TRAFFIC RATED LID (USED IN TRAFFIC AREAS)
- NOTE:** ANY SUBMETERS DOWNSTREAM OF METER DEPICTED ON THIS DWG. SHALL BE OWNED AND MAINTAINED BY DEVELOPER

**TYPICAL METER SETTING DETAIL**  
W-13

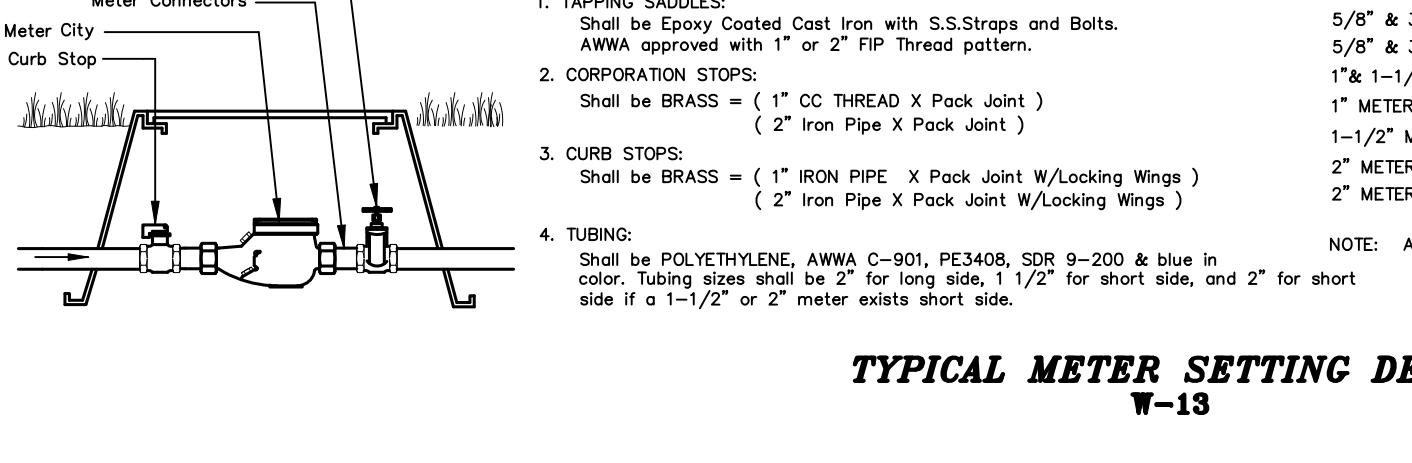

REV. NO.	REVISION DESCRIPTION	REV. DATE	DRAWN BY / EMP. NO.	SEC.-WPG.-RGE.
2	505, 25E			

CITY:	COLLIER	ISSUE DATE:	ISSUE DESCRIPTION:

**Wilson Miller Stantec**


3200 Bailey Lane, Suite 200 Naples, FL 34105-8507  
800.643.4336 • 239.649.4040 • F 239.643.5716  
Certificate of Authorization #43 • FL Lic. # LC-0000170 • www.stantec.com

PROJ. START DATE:	TITLE:
MAY 2012	CITY OF NAPLES WATER UTILITY DETAILS

PROJ. NO.:	PROJ. NAME:	PROJ. LOCATION:
215610640c	RECYCLE TRANSFER FACILITY	WILSONMILLER PROJECT NUMBER: 215610640


INDEX NUMBER:	SHEET NUMBER:
215610640c-014detl	14 OF 17

**BIDDING PLANS ONLY  
NOT FOR CONSTRUCTION  
PERMITTING PROCESS  
INCOMPLETE**

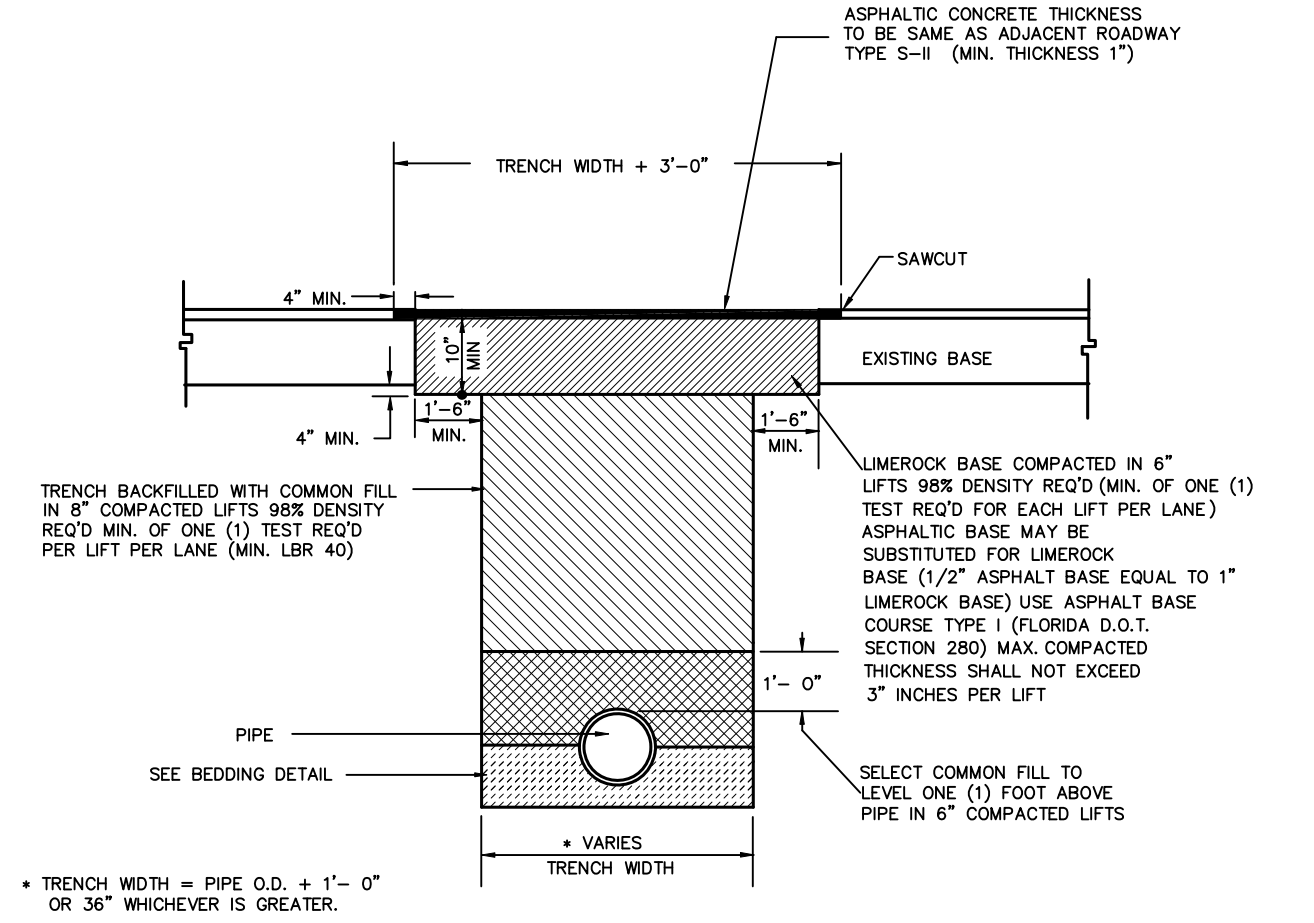


- NOTES: 1) ALL PROCTOR AND DENSITY TESTS SHALL BE TAKEN BY A CERTIFIED LABORATORY  
 2) ALL TESTS SHALL BE COMPLETED AND MEET MINIMUM DENSITY REQUIREMENTS PRIOR TO ADDITIONAL BACK-FILLING  
 3) ORDINANCE 82-91 REQUIRES A R.O.W. PERMIT FOR ALL WORK WITHIN PUBLIC ROADS. THE R.O.W. PERMIT REQUIREMENTS SHALL SUPERSEDE THIS DETAIL.

**BACKFILL - PAVED ROADWAYS**  
**U-02**

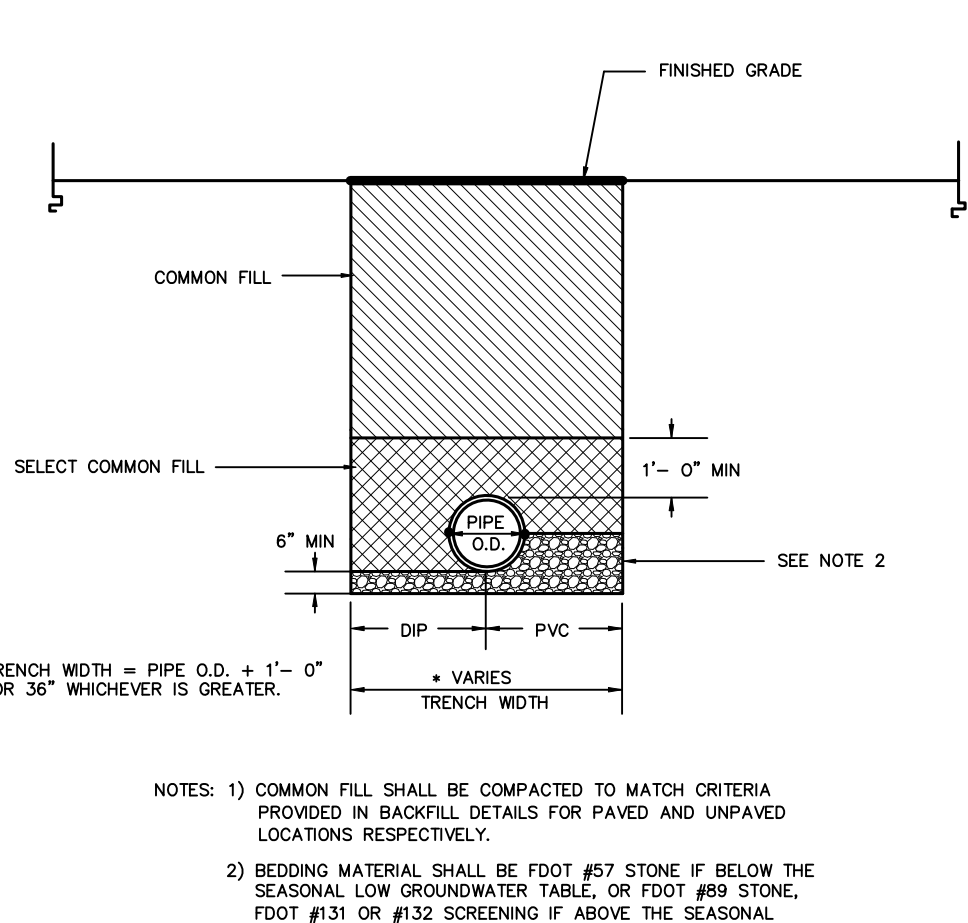

- NOTES: 1) COMMON FILL SHALL BE COMPACTED TO MATCH CRITERIA PROVIDED IN BACKFILL DETAILS FOR PAVED AND UNPAVED LOCATIONS RESPECTIVELY.  
 2) BEDDING MATERIAL SHALL BE FOOT #57 STONE IF BELOW THE SEASONAL LOW GROUNDWATER TABLE, OR FOOT #39 STONE, FOOT #31 OR #32 SCREENING IF ABOVE THE SEASONAL LOW GROUNDWATER TABLE.  
 3) ORDINANCE 82-91 REQUIRES A R.O.W. PERMIT FOR ALL WORK WITHIN PUBLIC ROADS. THE R.O.W. PERMIT REQUIREMENTS SHALL SUPERSEDE THIS DETAIL.

**PIPE BEDDING & BACKFILL**  
**U-03**

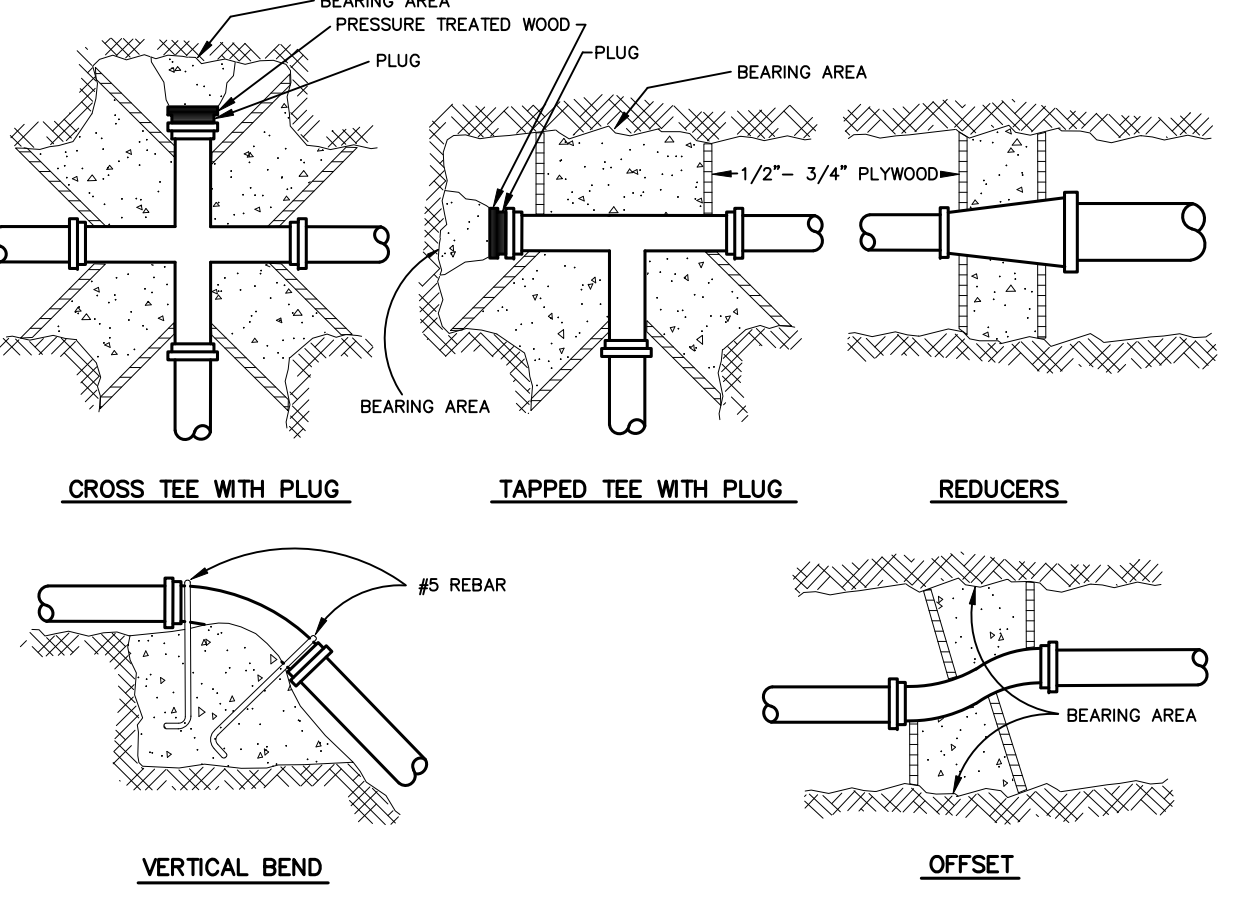


MINIMUM BEARING AREAS IN SQUARE FEET FOR THRUST BLOCKS

PIPE SIZE	TEES	90° BEND	45° BEND	22 1/2° BEND	VALVES & PLUGS
4"	1	1	1	1	1
6"	3	4	2	1	3
8"	5	7	4	2	5
10"	8	12	6	3	9
12"	12	16	9	5	12
16"	16	20	12	7	16
20"	24	20	17	10	24
24"	34	34	24	13	34

TYPICAL THRUST BLOCKS

**THRUST BLOCKS NO. 1**  
**U-04**

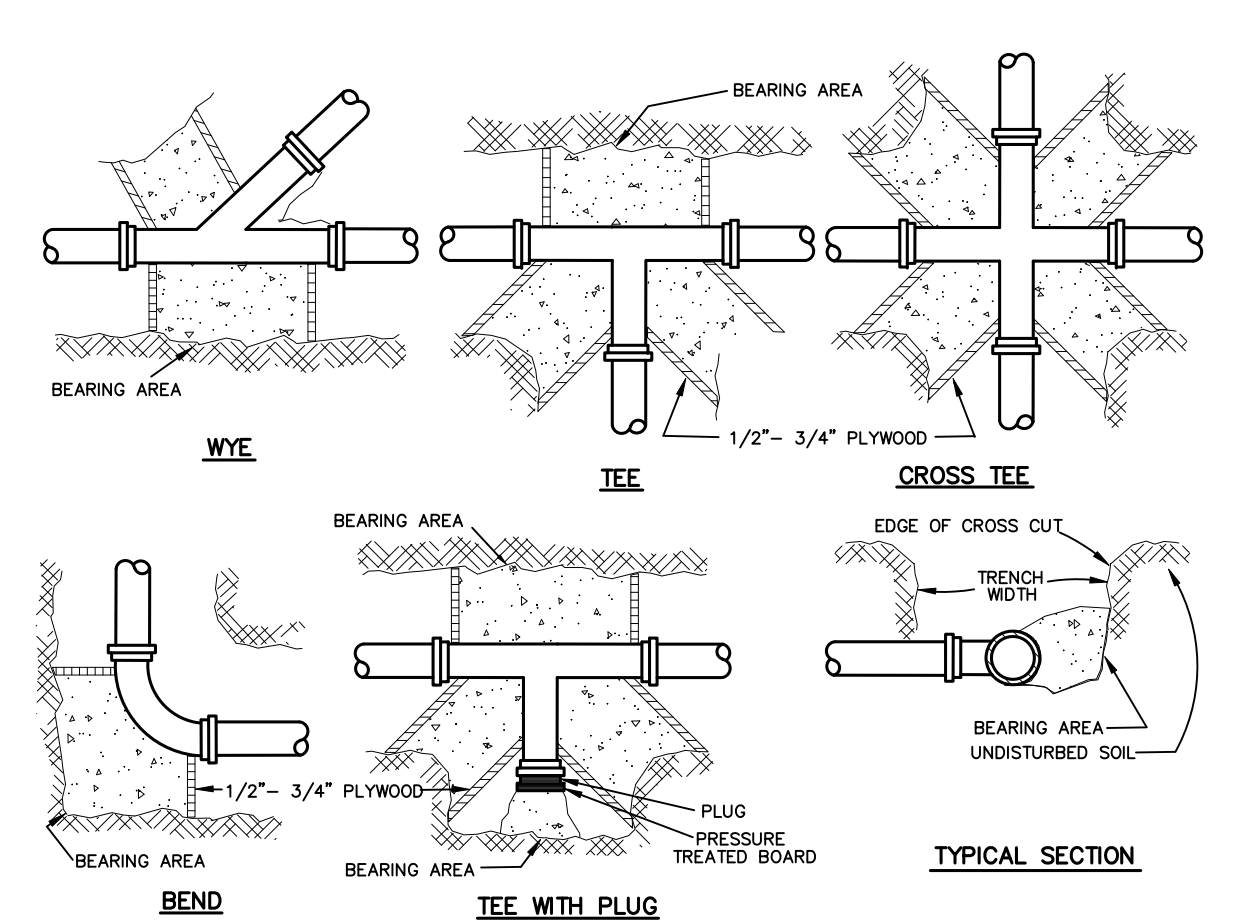


MINIMUM BEARING AREAS IN SQUARE FEET FOR THRUST BLOCKS


PIPE SIZE	TEES	90° BEND	45° BEND	22 1/2° BEND	VALVES & PLUGS
4"	1	1	1	1	1
6"	3	4	2	1	3
8"	5	7	4	2	5
10"	8	12	6	3	9
12"	12	16	9	5	12
16"	16	20	12	7	16
20"	24	20	17	10	24
24"	34	34	24	13	34

TYPICAL THRUST BLOCKS

**THRUST BLOCKS NO. 2**  
**U-05**

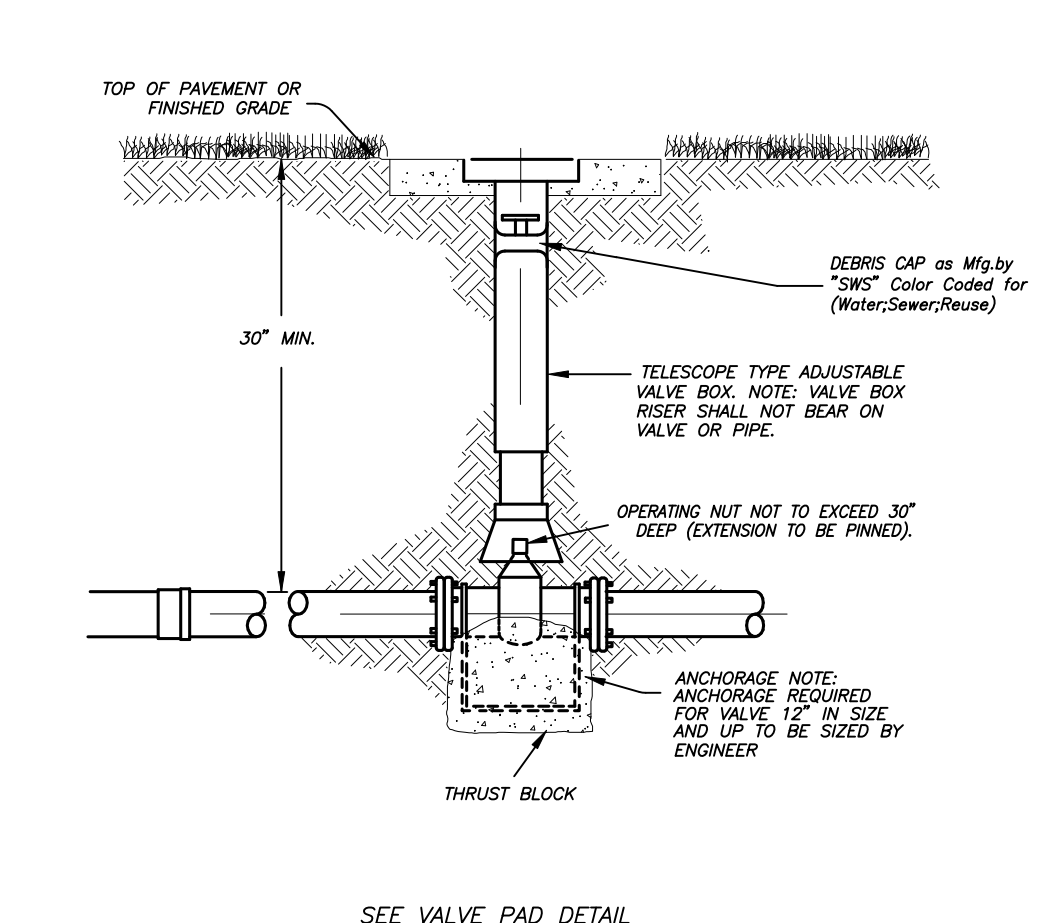


**TYPICAL IN-LINE VALVE (WATER/SEWER/REUSE)**  
**U-14**

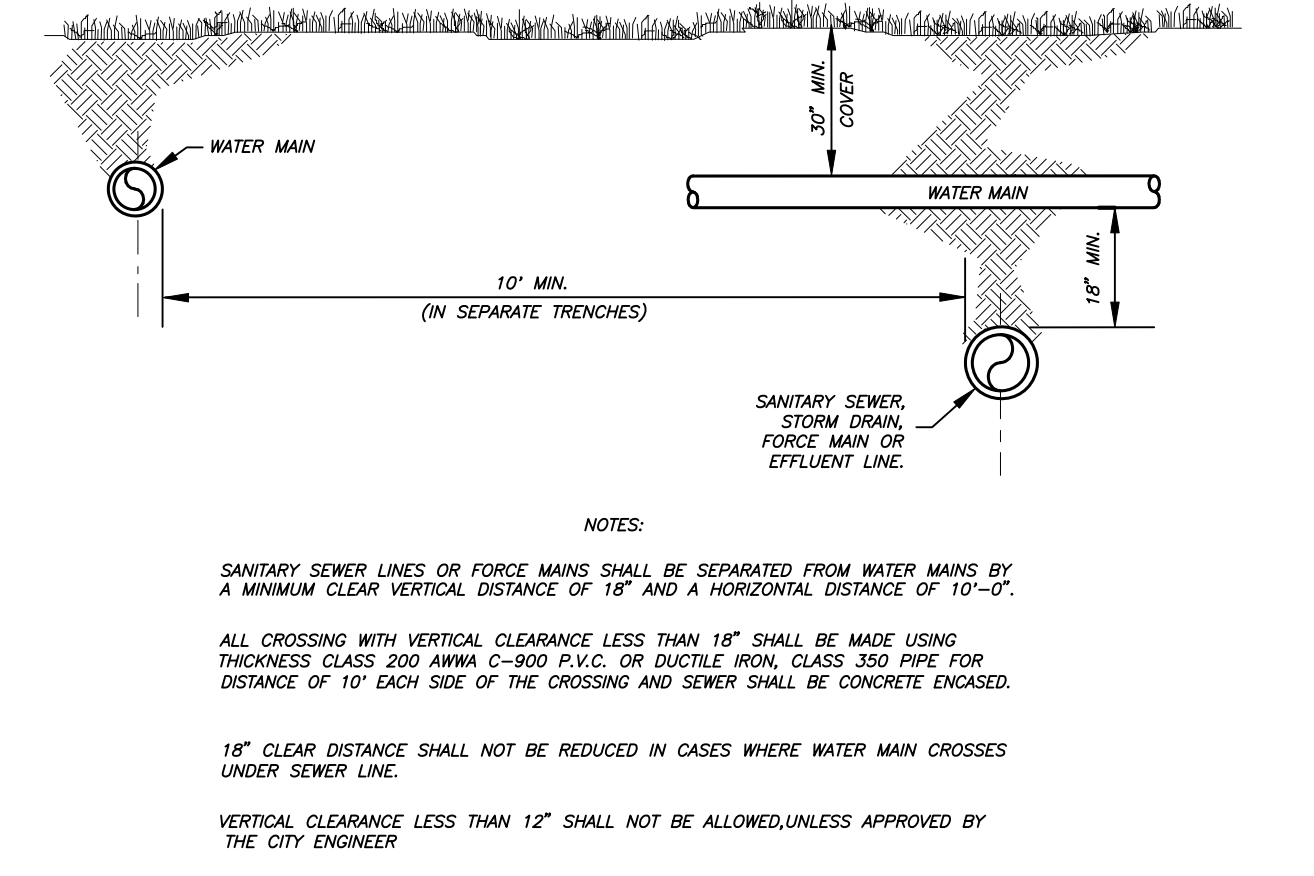

- NOTES:  
 1. SANITARY SEWER LINES OR FORCE MAINS SHALL BE SEPARATED FROM WATER MAINS BY A MINIMUM CLEAR VERTICAL DISTANCE OF 18\"/>


**CROSS OVER**  
**U-07**

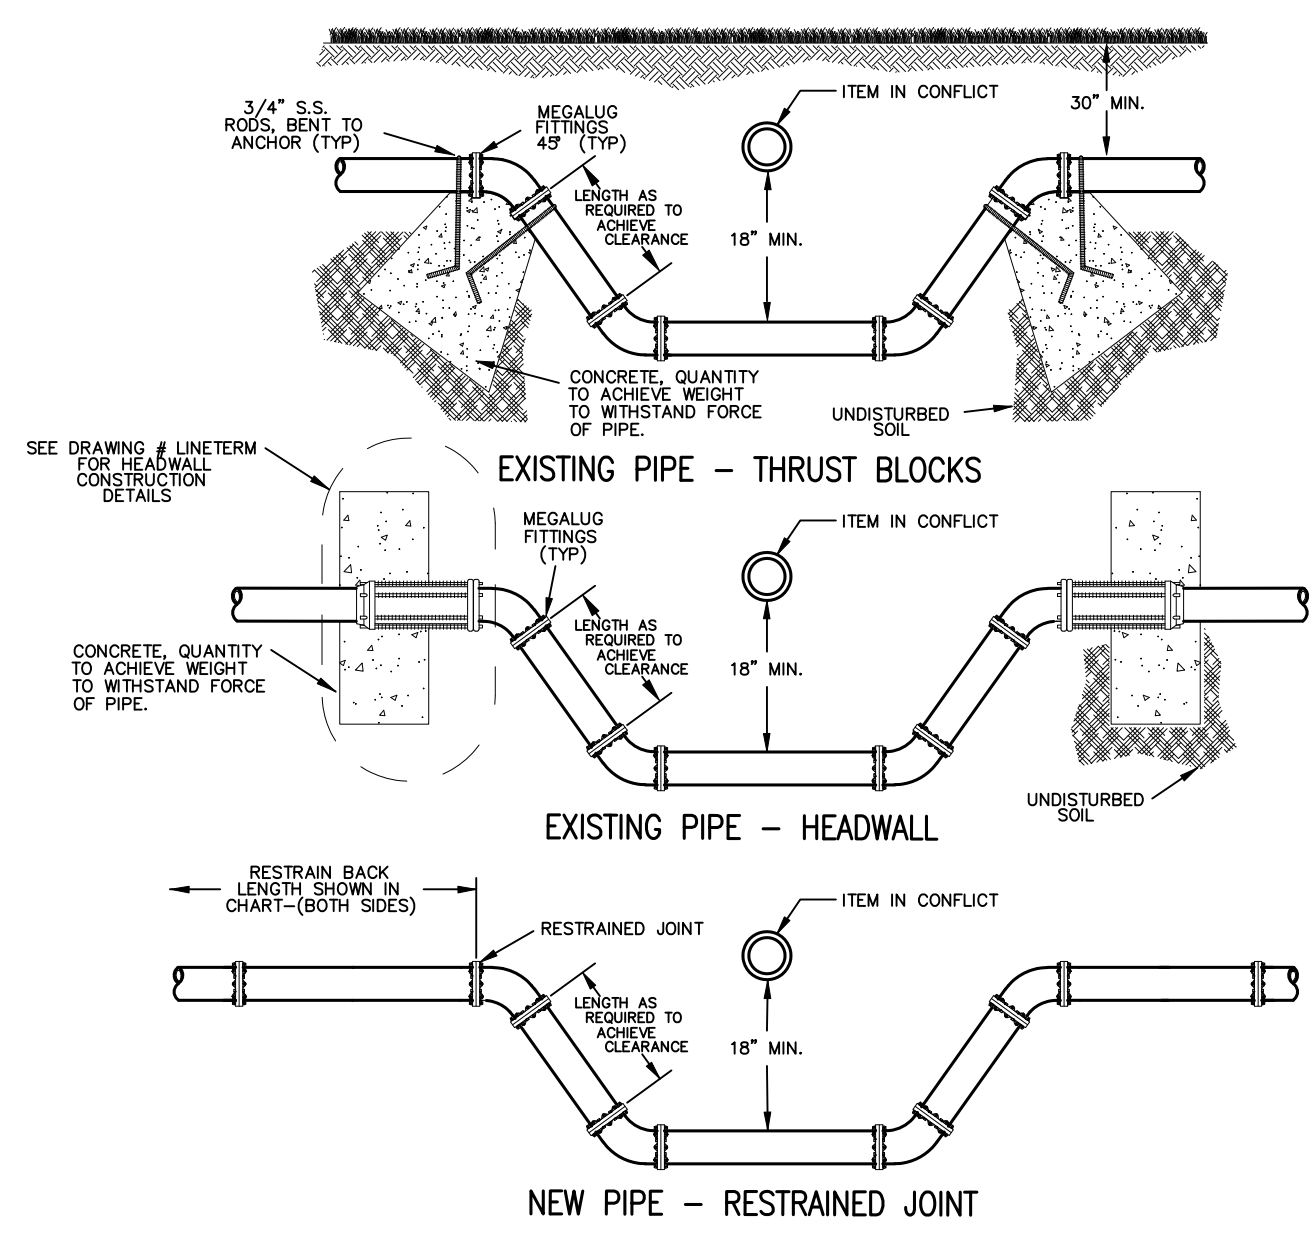

\*RESTRAINED JOINT PIPE DISTANCES FOR NEW PIPE (IN FEET)


PIPE SIZE	90° BEND	45° BEND	22 1/2° BEND	11 1/4° BEND
8"	74	31	15	7
10"	87	38	17	9
12"	100	41	20	10
16"	123	51	24	12
20"	143	59	29	14
24"	162	67	32	16
30"	184	76	37	18
36"	207	86	41	20

**TYPICAL CONFLICT CROSSING**  
**U-08**

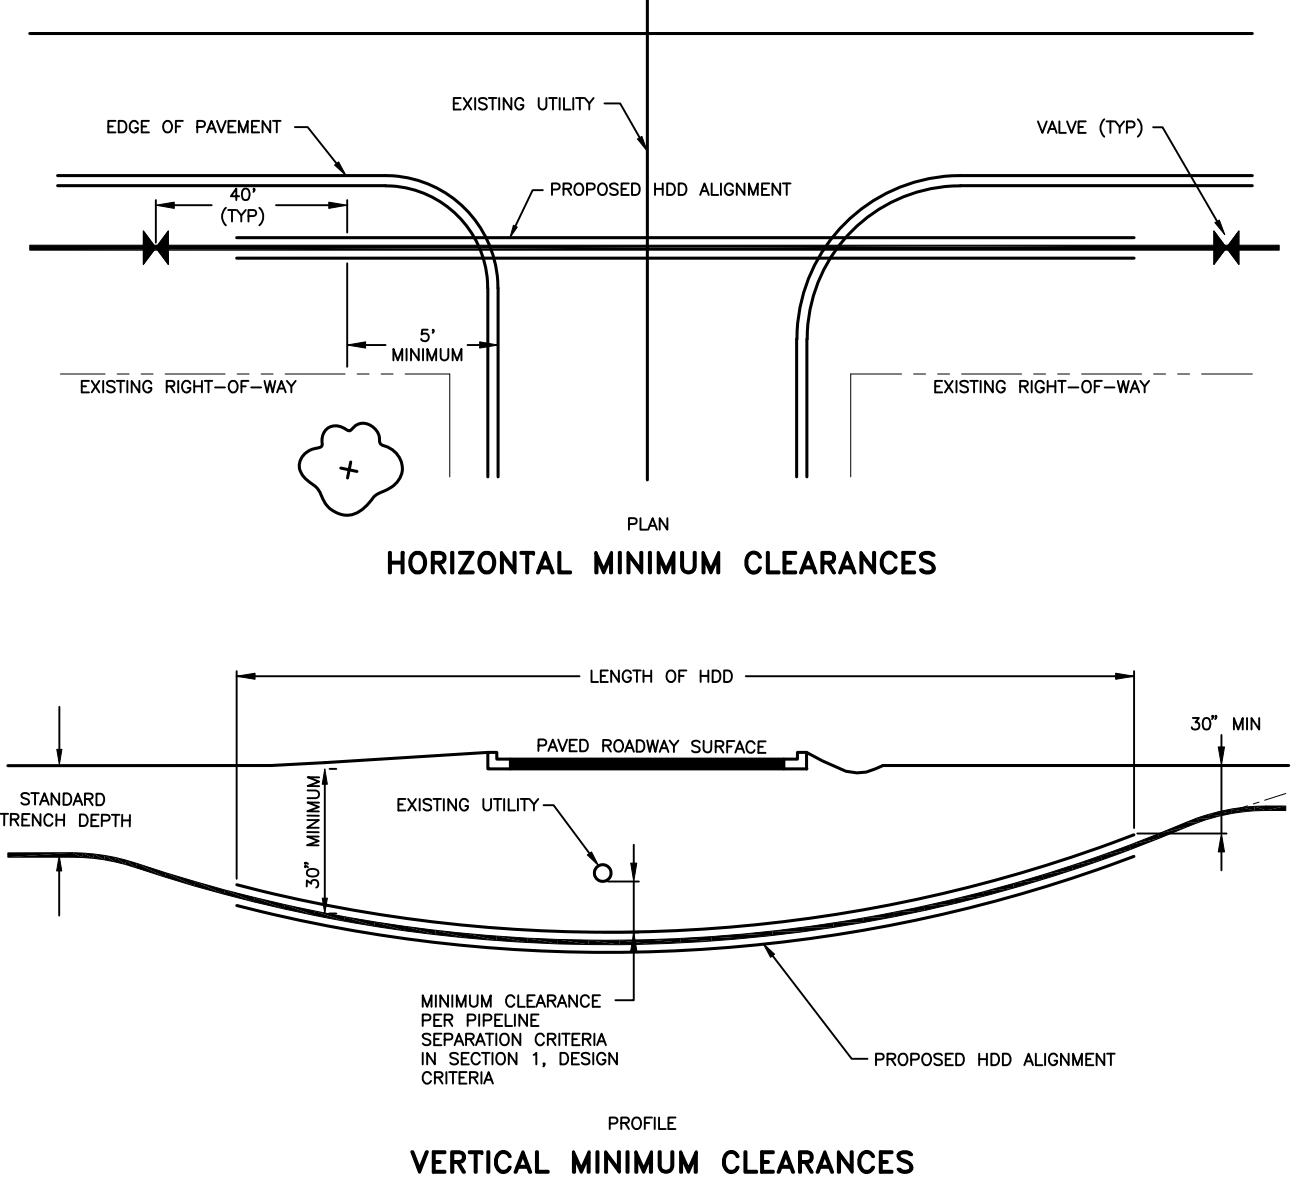

- HDD INSTALLATION NOTES:  
 1. ALL WORK SHALL BE IN ACCORDANCE WITH SECTIONS 1 AND 02.300 OF THE COLLIER COUNTY UTILITIES STANDARDS MANUAL.  
 2. ALL HDD INSTALLATION ACTIVITIES SHALL BE IN ACCORDANCE WITH THE FLORIDA D.O.T. UTILITY ACCOMMODATIONS MANUAL AND THE CITY UTILITIES STANDARDS.  
 3. THE CONTRACTOR SHALL BE RESPONSIBLE FOR NOTIFICATION OF AFFECTED AGENCIES AND COORDINATION WITH ALL UTILITIES PRIOR TO CONSTRUCTION.  
 4. ALL CONSTRUCTION MATERIALS, INCLUDING DRILLING FLUID, SHALL BE REMOVED FROM THE SITE PRIOR TO RESTORATION OF DISTURBED AREAS.  
 5. ALL RESTORATION WORK SHALL BE IN ACCORDANCE WITH THE CITY UTILITIES STANDARD MANUAL.  
 6. EXCAVATIONS SHALL BE RESTORED IN ACCORDANCE WITH THE CITY UTILITIES STANDARD MANUAL AND STANDARD DETAILS.  
 7. CASING DIAMETER SHALL BE IN ACCORDANCE WITH THE TECHNICAL SPECIFICATIONS.  
 8. NO SPACERS REQUIRED.  
 9. ALLOW 40\"/>

**TYPICAL HORIZONTAL DIRECTIONAL DRILL UNDER A ROADWAY**  
**U-11**

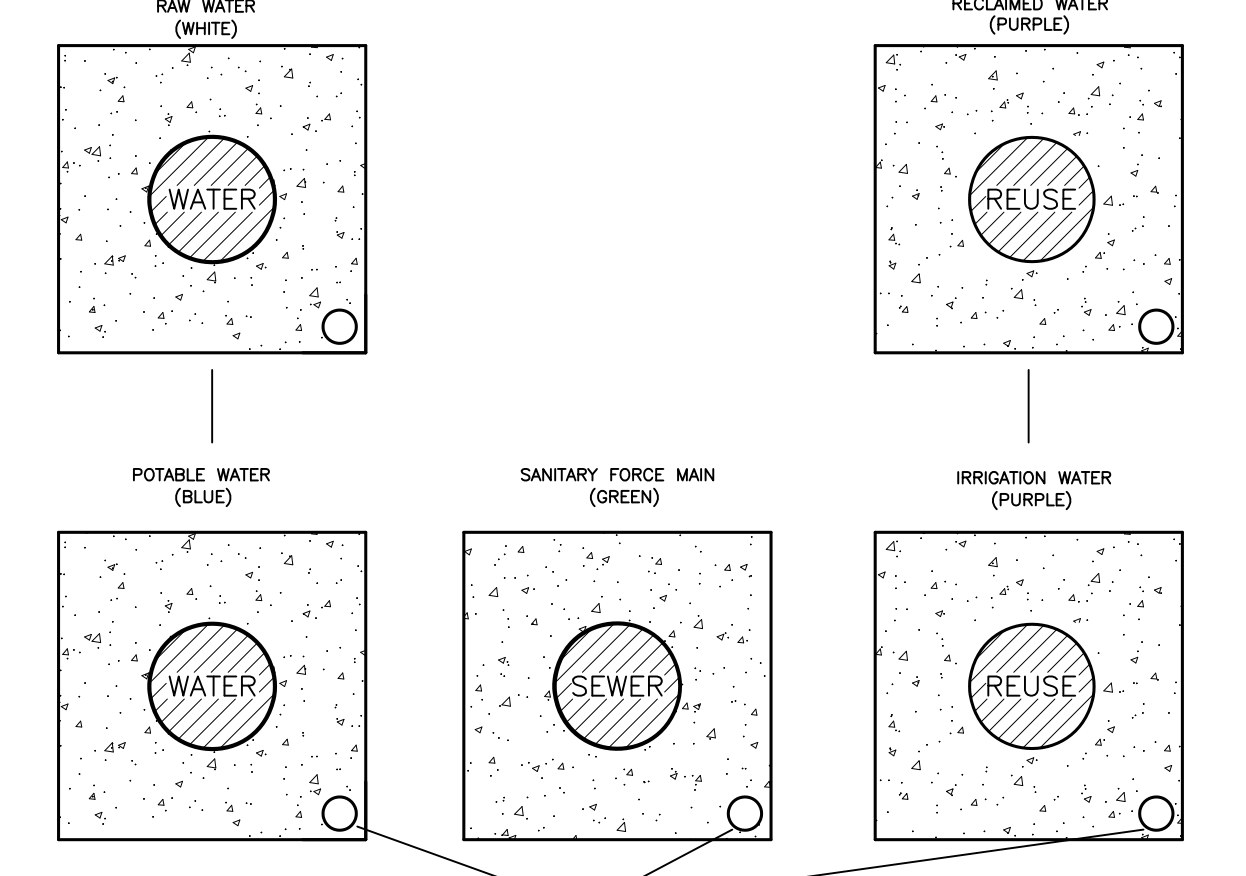

**VALVE PAD DETAIL**  
**U-15**


RESTRAINED PIPE LENGTH IN FEET (1)

PIPE SIZE IN INCHES	TEE (3)	REDUCER (4)
6 x 4	0	40
6 x 6	34	
8 x 4	0	72
8 x 8	55	
10 x 6	3	74
10 x 10	75	
12 x 4	0	122
12 x 8	31	75
12 x 12	95	
16 x 6	0	153
16 x 10	44	107
16 x 16	134	
18 x 8	0	157
18 x 12	68	108
18 x 18	152	
20 x 10	20	161
20 x 16	120	77
20 x 20	170	
24 x 12	37	187
24 x 18	132	109
24 x 24	204	
30 x 16	78	213
30 x 20	136	165
30 x 30	252	
36 x 18	84	259
36 x 24	170	191
36 x 36	298	

RESTRAINED PIPE LENGTH IN FEET (1)

PIPE SIZE IN INCHES	HORIZONTAL BENDS				DEAD ENDS (2)	45° VERTICAL BENDS	
	90°	45°	22-1/2°	11-1/4°		UPPER	LOWER
4	23	9	5	2	55	23	8
6	32	13	6	3	77	32	11
8	74	31	15	7	100	41	14
10	87	36	17	9	120	50	17
12	100	41	20	10	141	58	20
16	123	51	24	12	181	75	25
18	133	55	27	13	200	83	28
20	143	59	29	14	218	90	30
24	162	67	32	16	253	105	35
30	184	76	37	18	303	125	41
36	207	86	41	20	350	145	47

**PIPE RESTRAINT SCHEDULE**  
**U-09**

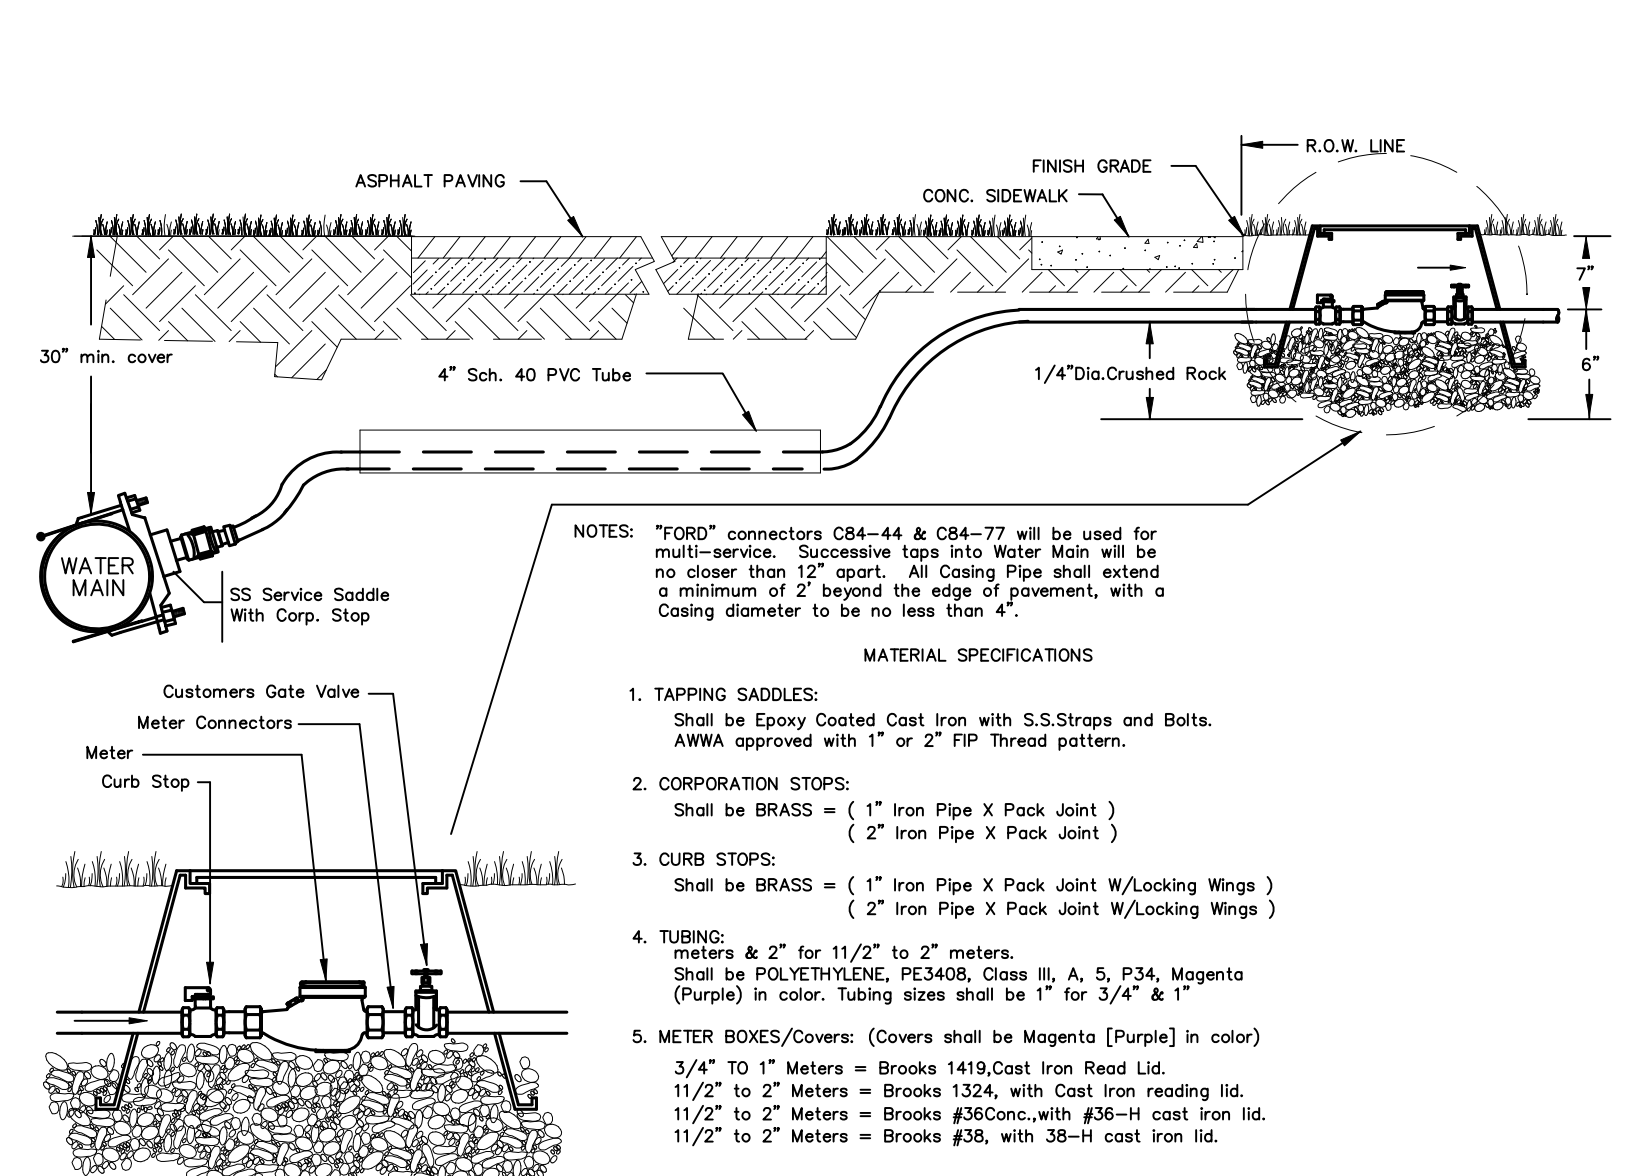


- NOTES: "FORD" connectors CB4-44 & CB4-77 will be used for multi-service. Successive taps into Water Main will be no closer than 12\"/>


MATERIAL SPECIFICATIONS

  1. TAPPING SADDLES: Shall be Epoxy Coated Cast Iron with S.S.Straps and Bolts. AWWA approved with 1\"/>
  - 2. CORPORATION STOPS: Shall be BRASS = (1\"/>
  - 3. CURB STOPS: Shall be BRASS = (1\"/>
  - 4. TUBING: meters & 2\"/>
  - 5. METER BOXES/Covers: (Covers shall be Magenta (Purple) in color) 3/4\"/>

**METER SETTING DETAIL IRRIGATION OR RECLAIMED R-01**

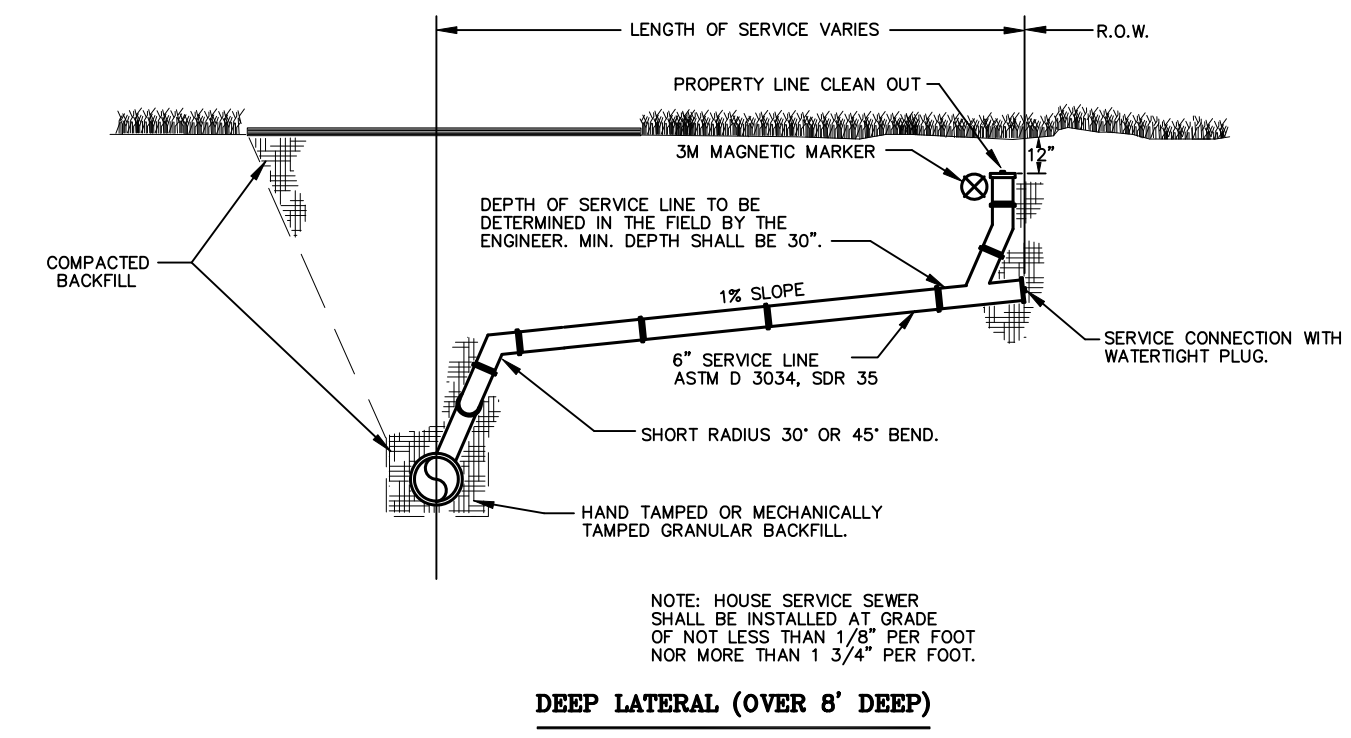


**DEEP LATERAL (OVER 8' DEEP) WW-01**

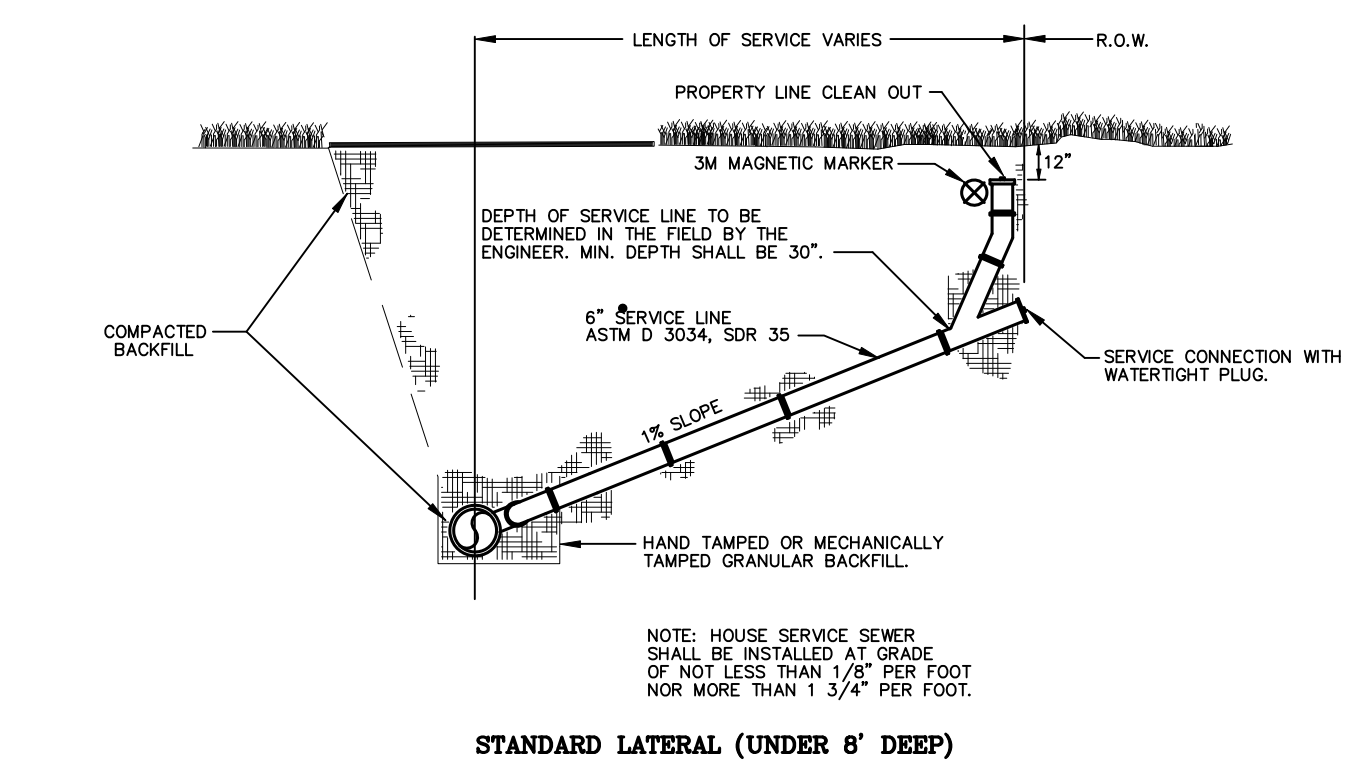


**STANDARD LATERAL (UNDER 8' DEEP) WW-01**


**SEWER LATERALS WW-01**

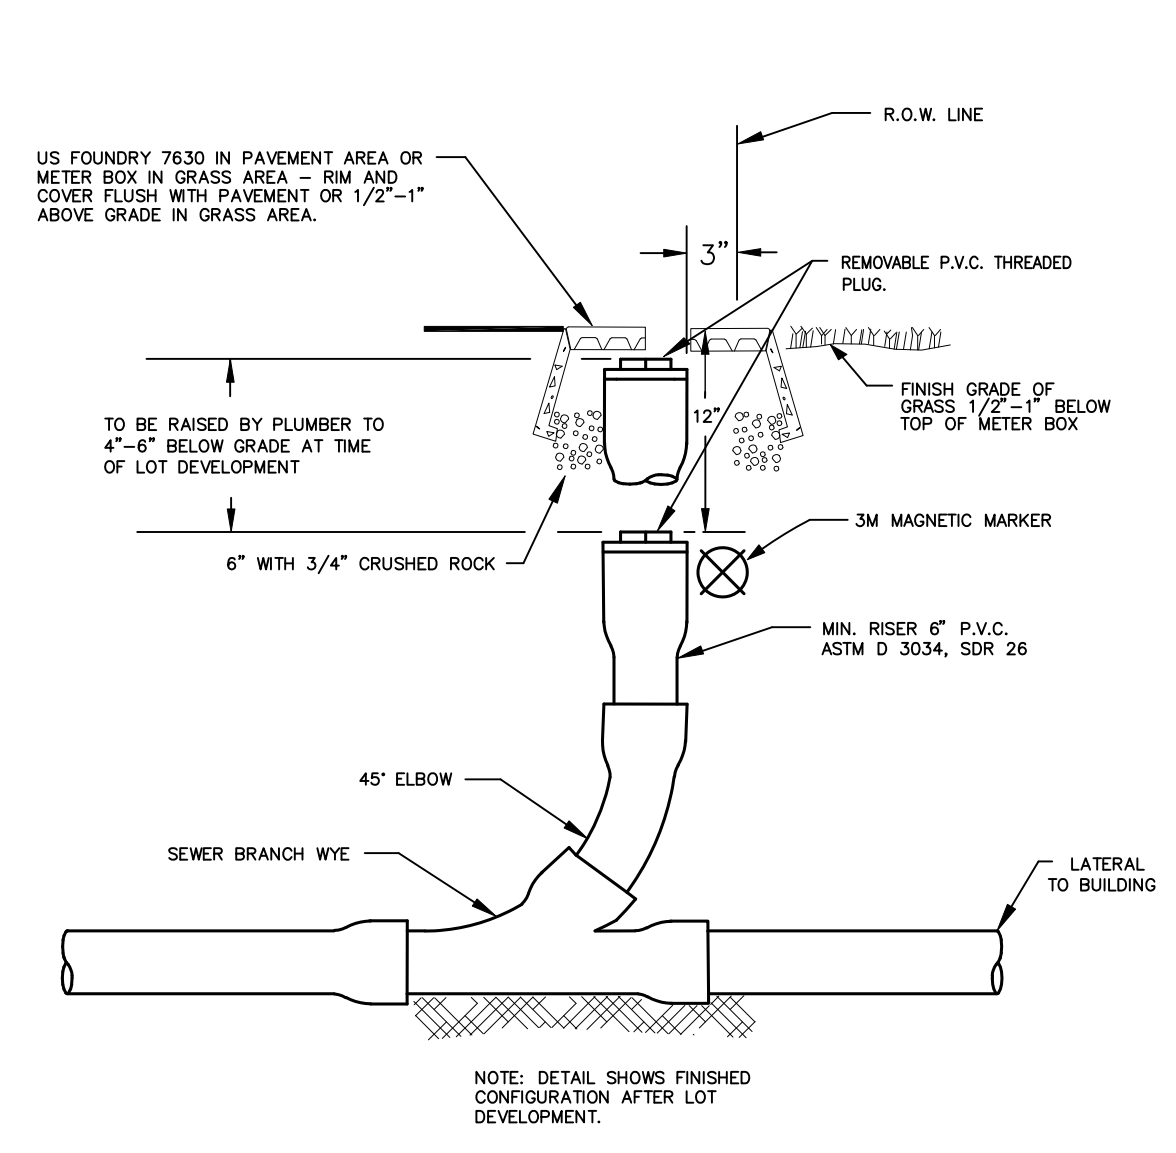


**PROPERTY LINE CLEANOUT WW-02**

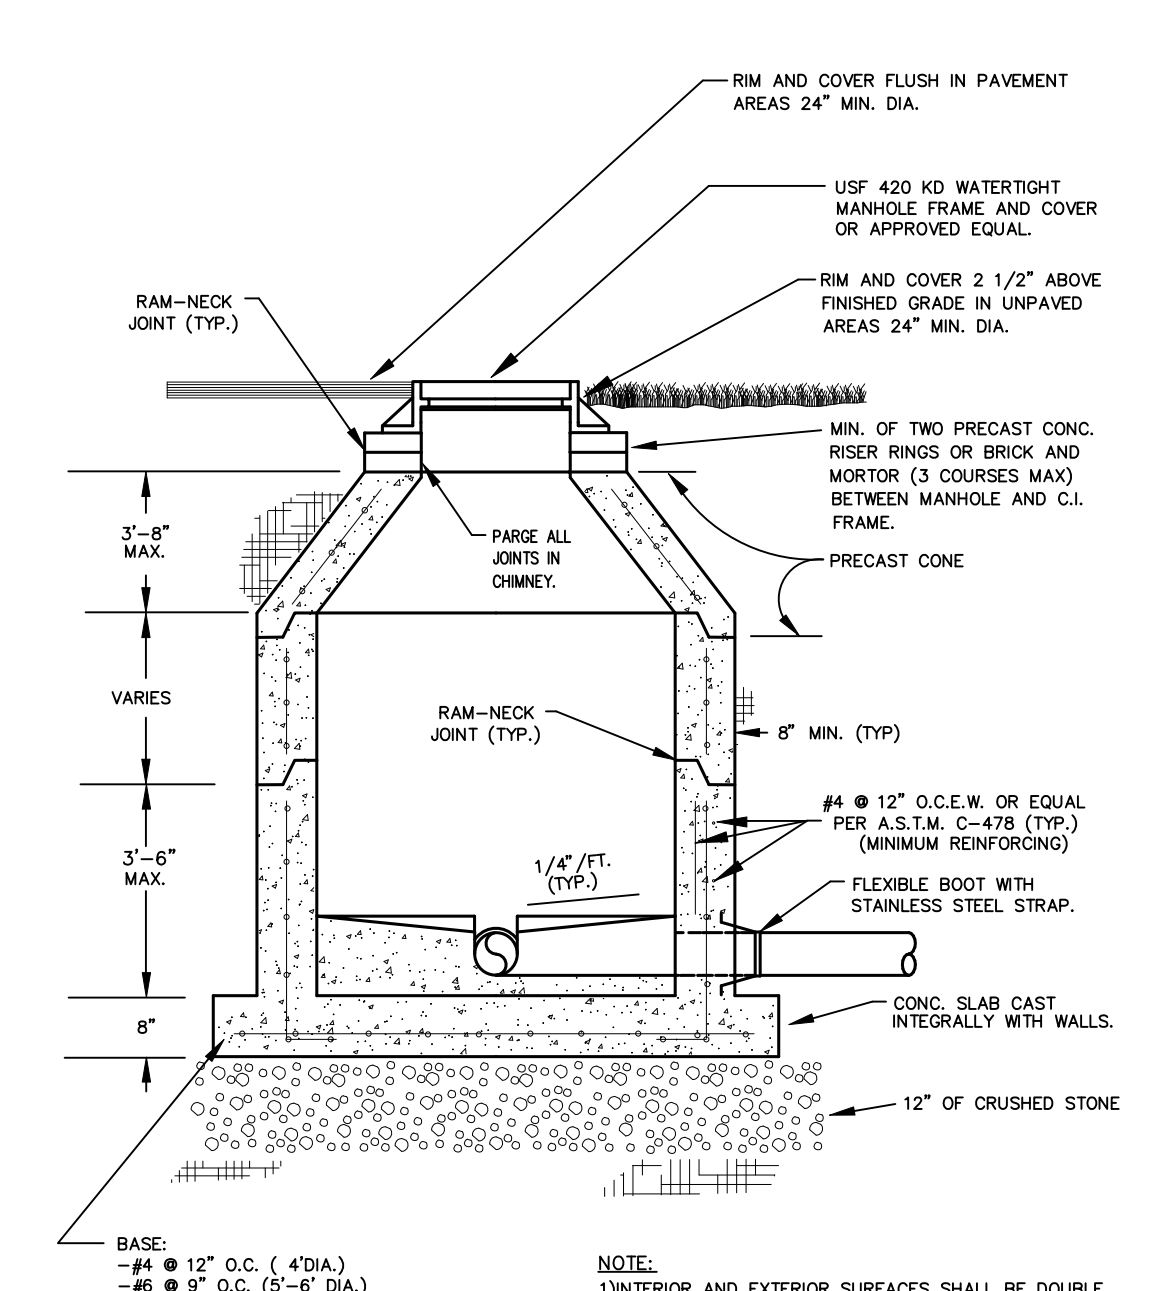


**STANDARD PRE-CAST MANHOLE WW-05**

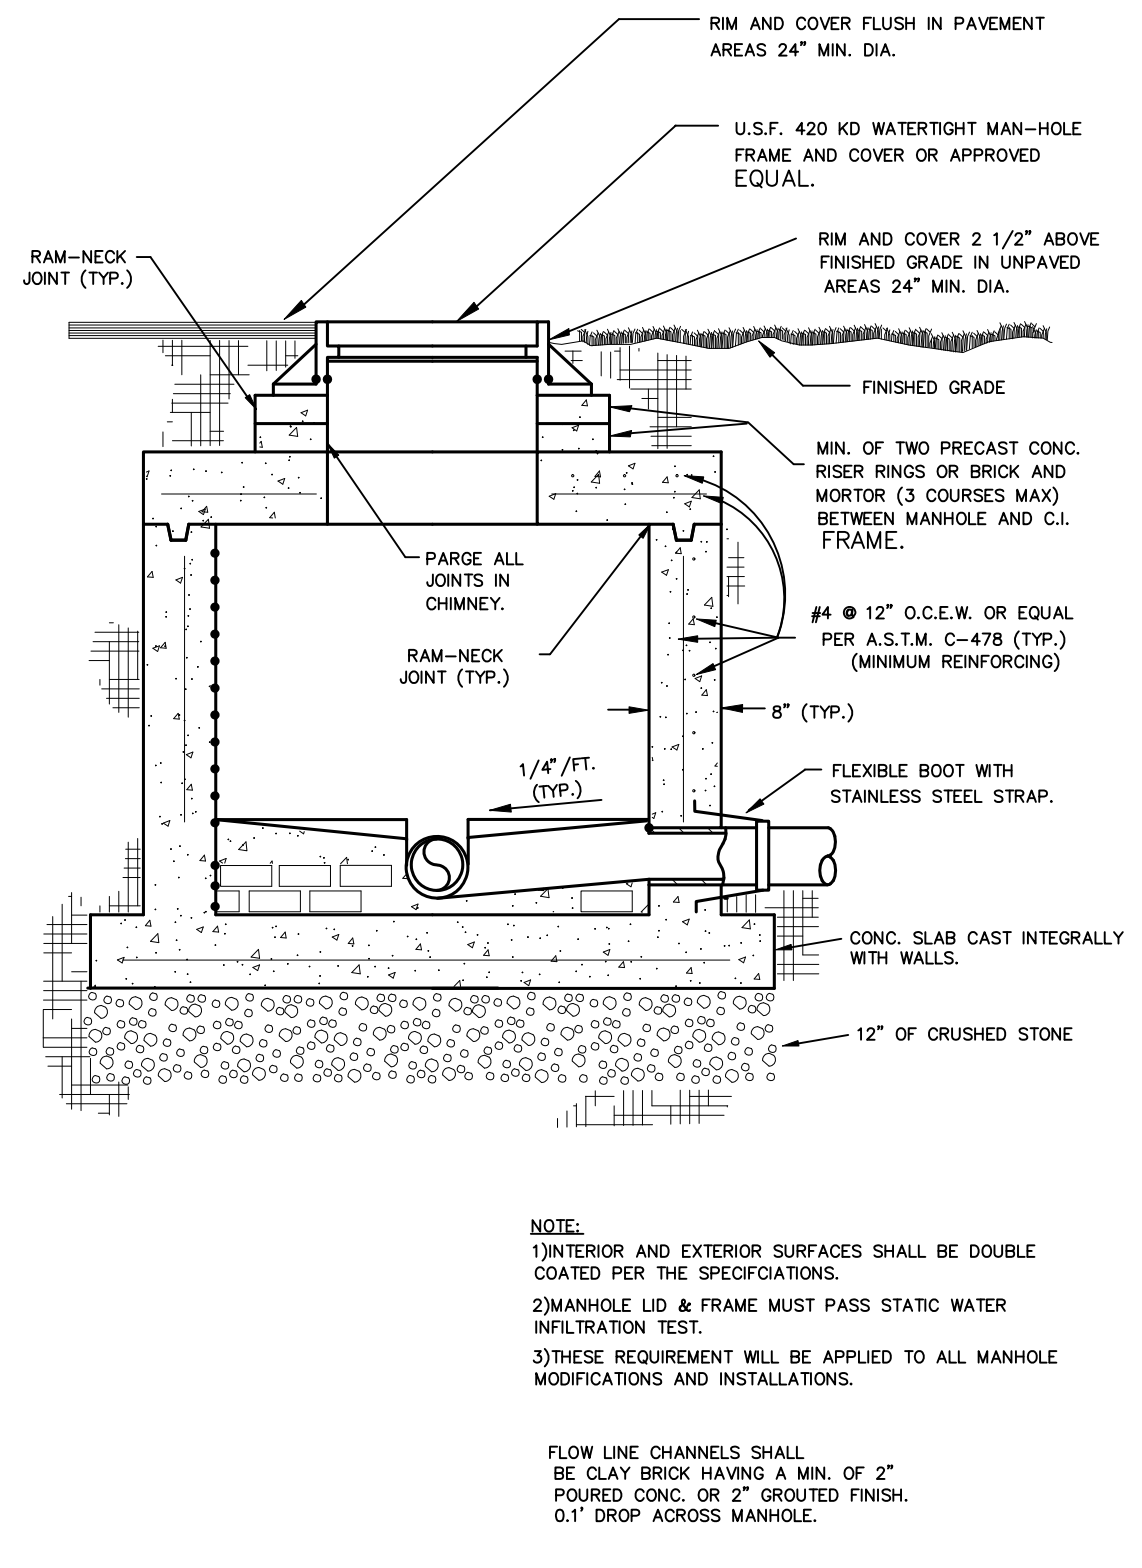


**SHALLOW MANHOLE WW-06**

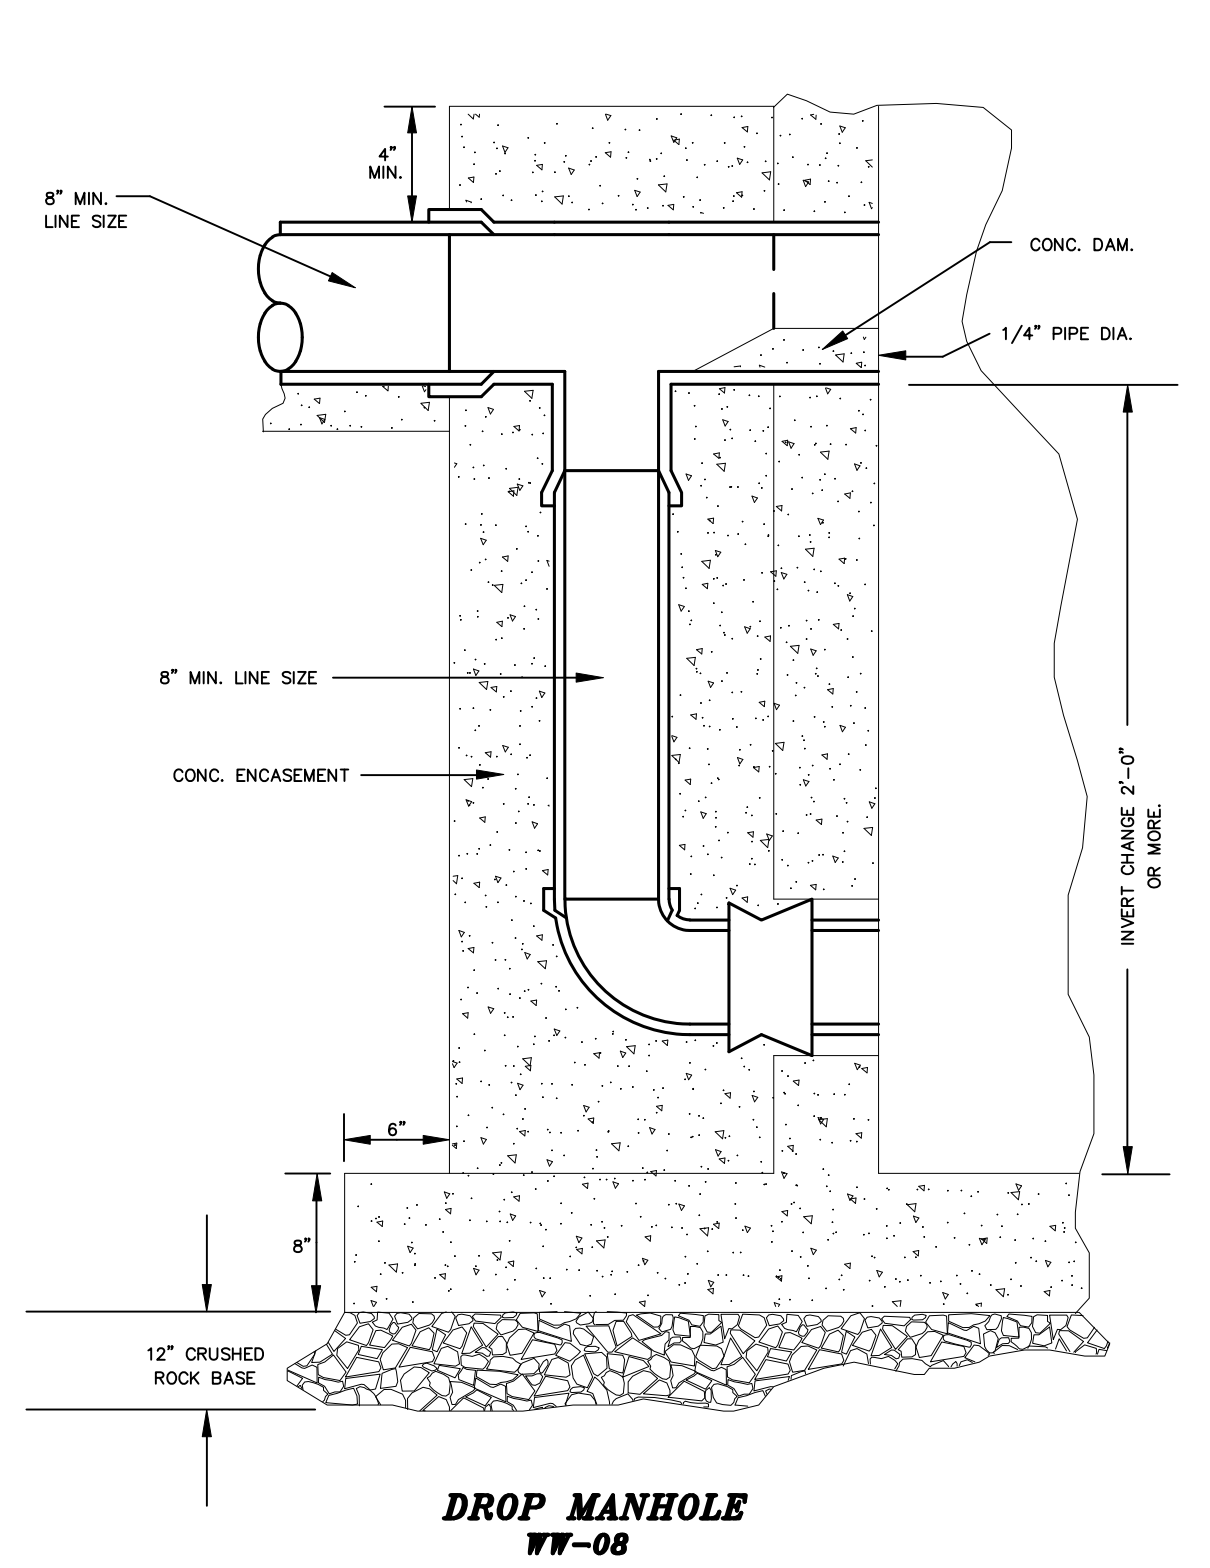


**DROP MANHOLE WW-08**

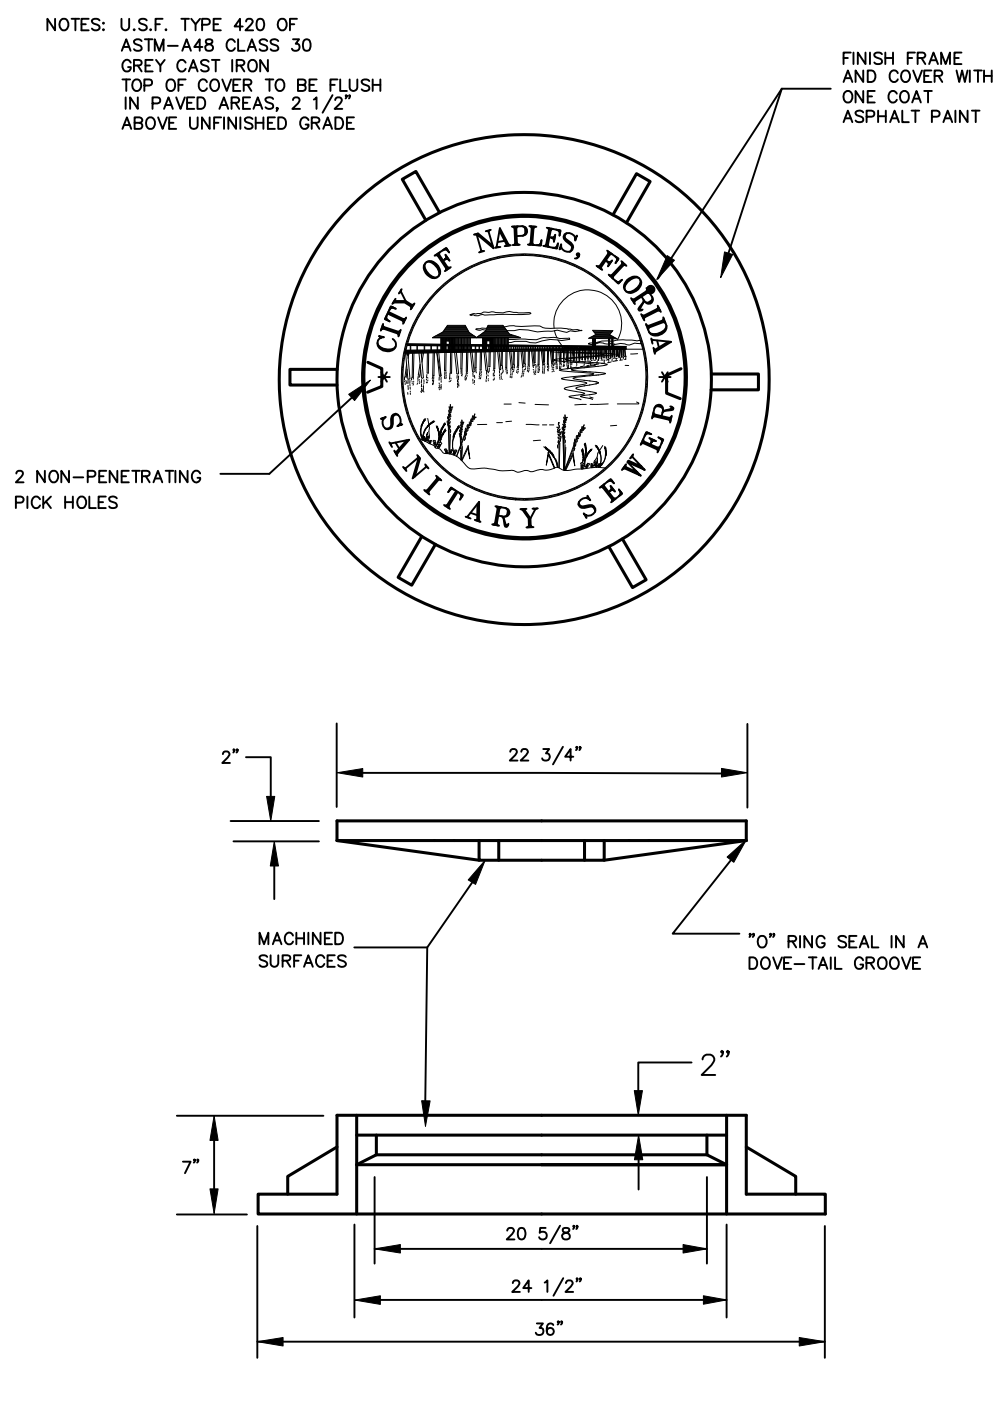

**STANDARD MANHOLE COVER WW-09**

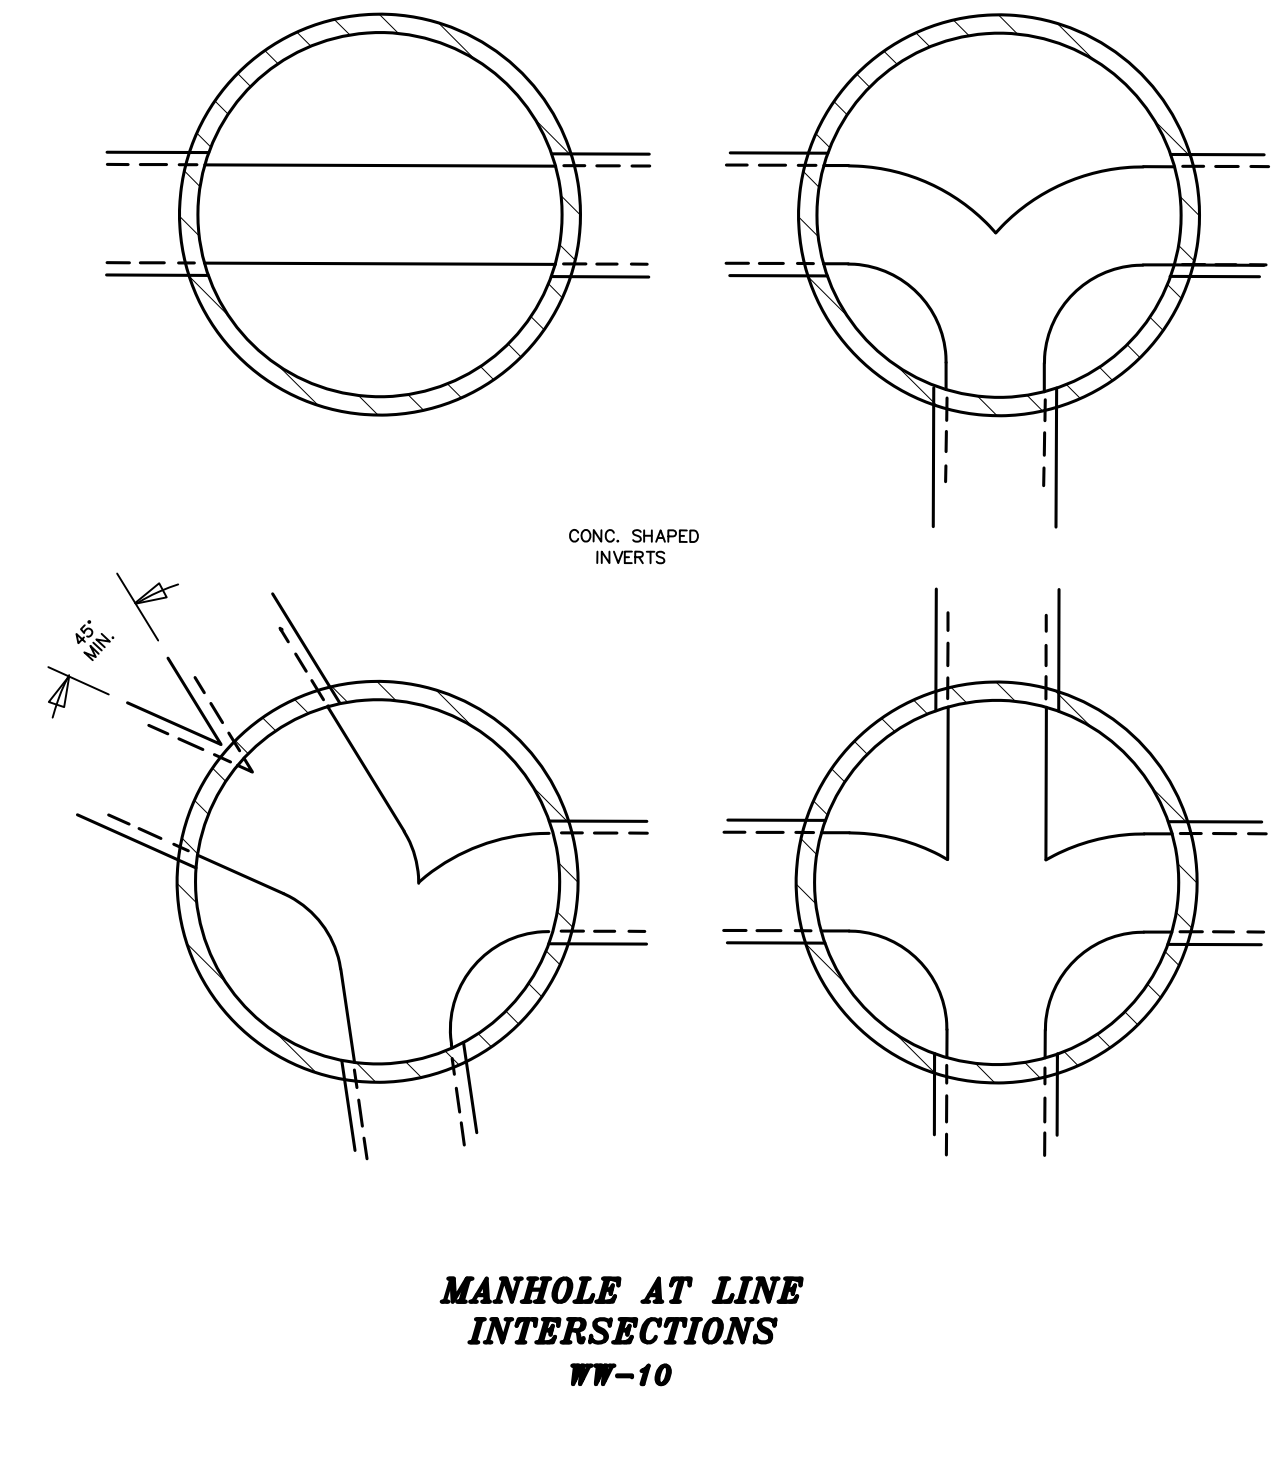

**MANHOLE AT LINE INTERSECTIONS WW-10**

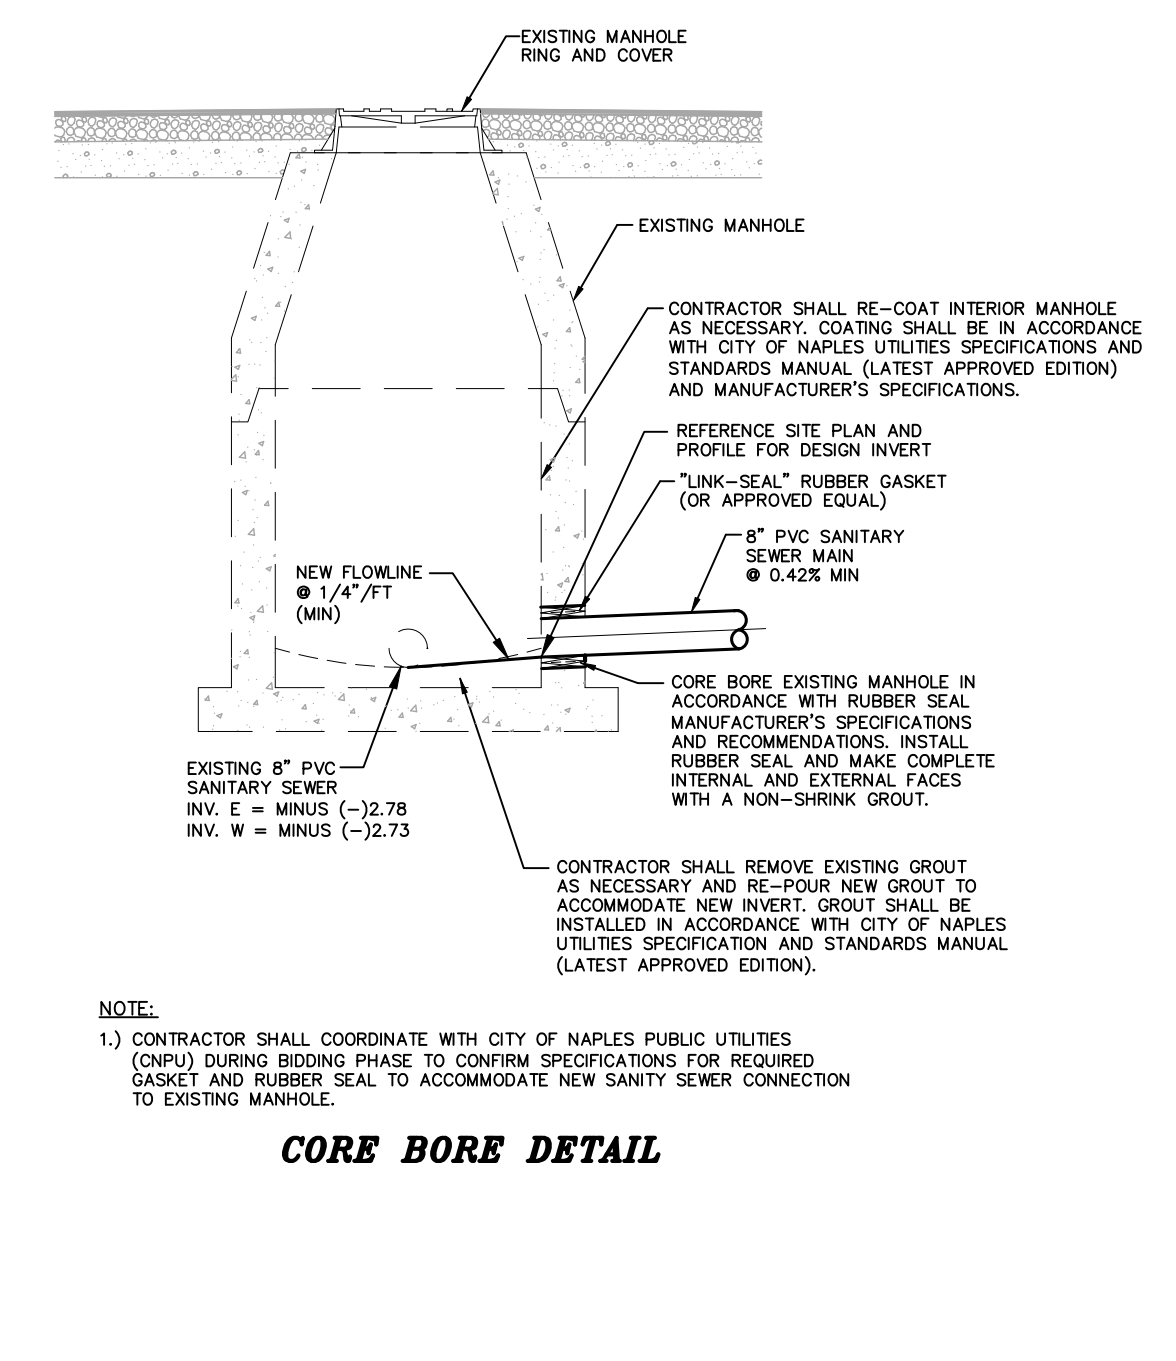


**CORE BORE DETAIL**


**BIDDING PLANS ONLY NOT FOR CONSTRUCTION PERMITTING PROCESS INCOMPLETE**

2. 505, 25E REV. DATE: 2/2/2012 DRAWN BY / EMP. NO.: SEC.-TWP.-RGE:		COLLER ISSUE DATE: ISSUE DESCRIPTION: LEAD DESIGNER: CMW_89458 LEAD TECHNICIAN: CMW_89458		CITY OF NAPLES CITY OF NAPLES RECYCLE TRANSFER FACILITY		PROJ. START DATE: MAY 2012 HORIZONTAL SCALE: N.T.S. VERTICAL SCALE: N.T.S. CROSS REF. NUMBER:		CITY OF NAPLES SANITARY SEWER AND IRRIGATION DETAILS WILSONMILLER PROJECT NUMBER: 215610640		<b>PRELIMINARY</b> INDEX NUMBER: 215610640c-016detl SHEET NUMBER: 16 OF 17	
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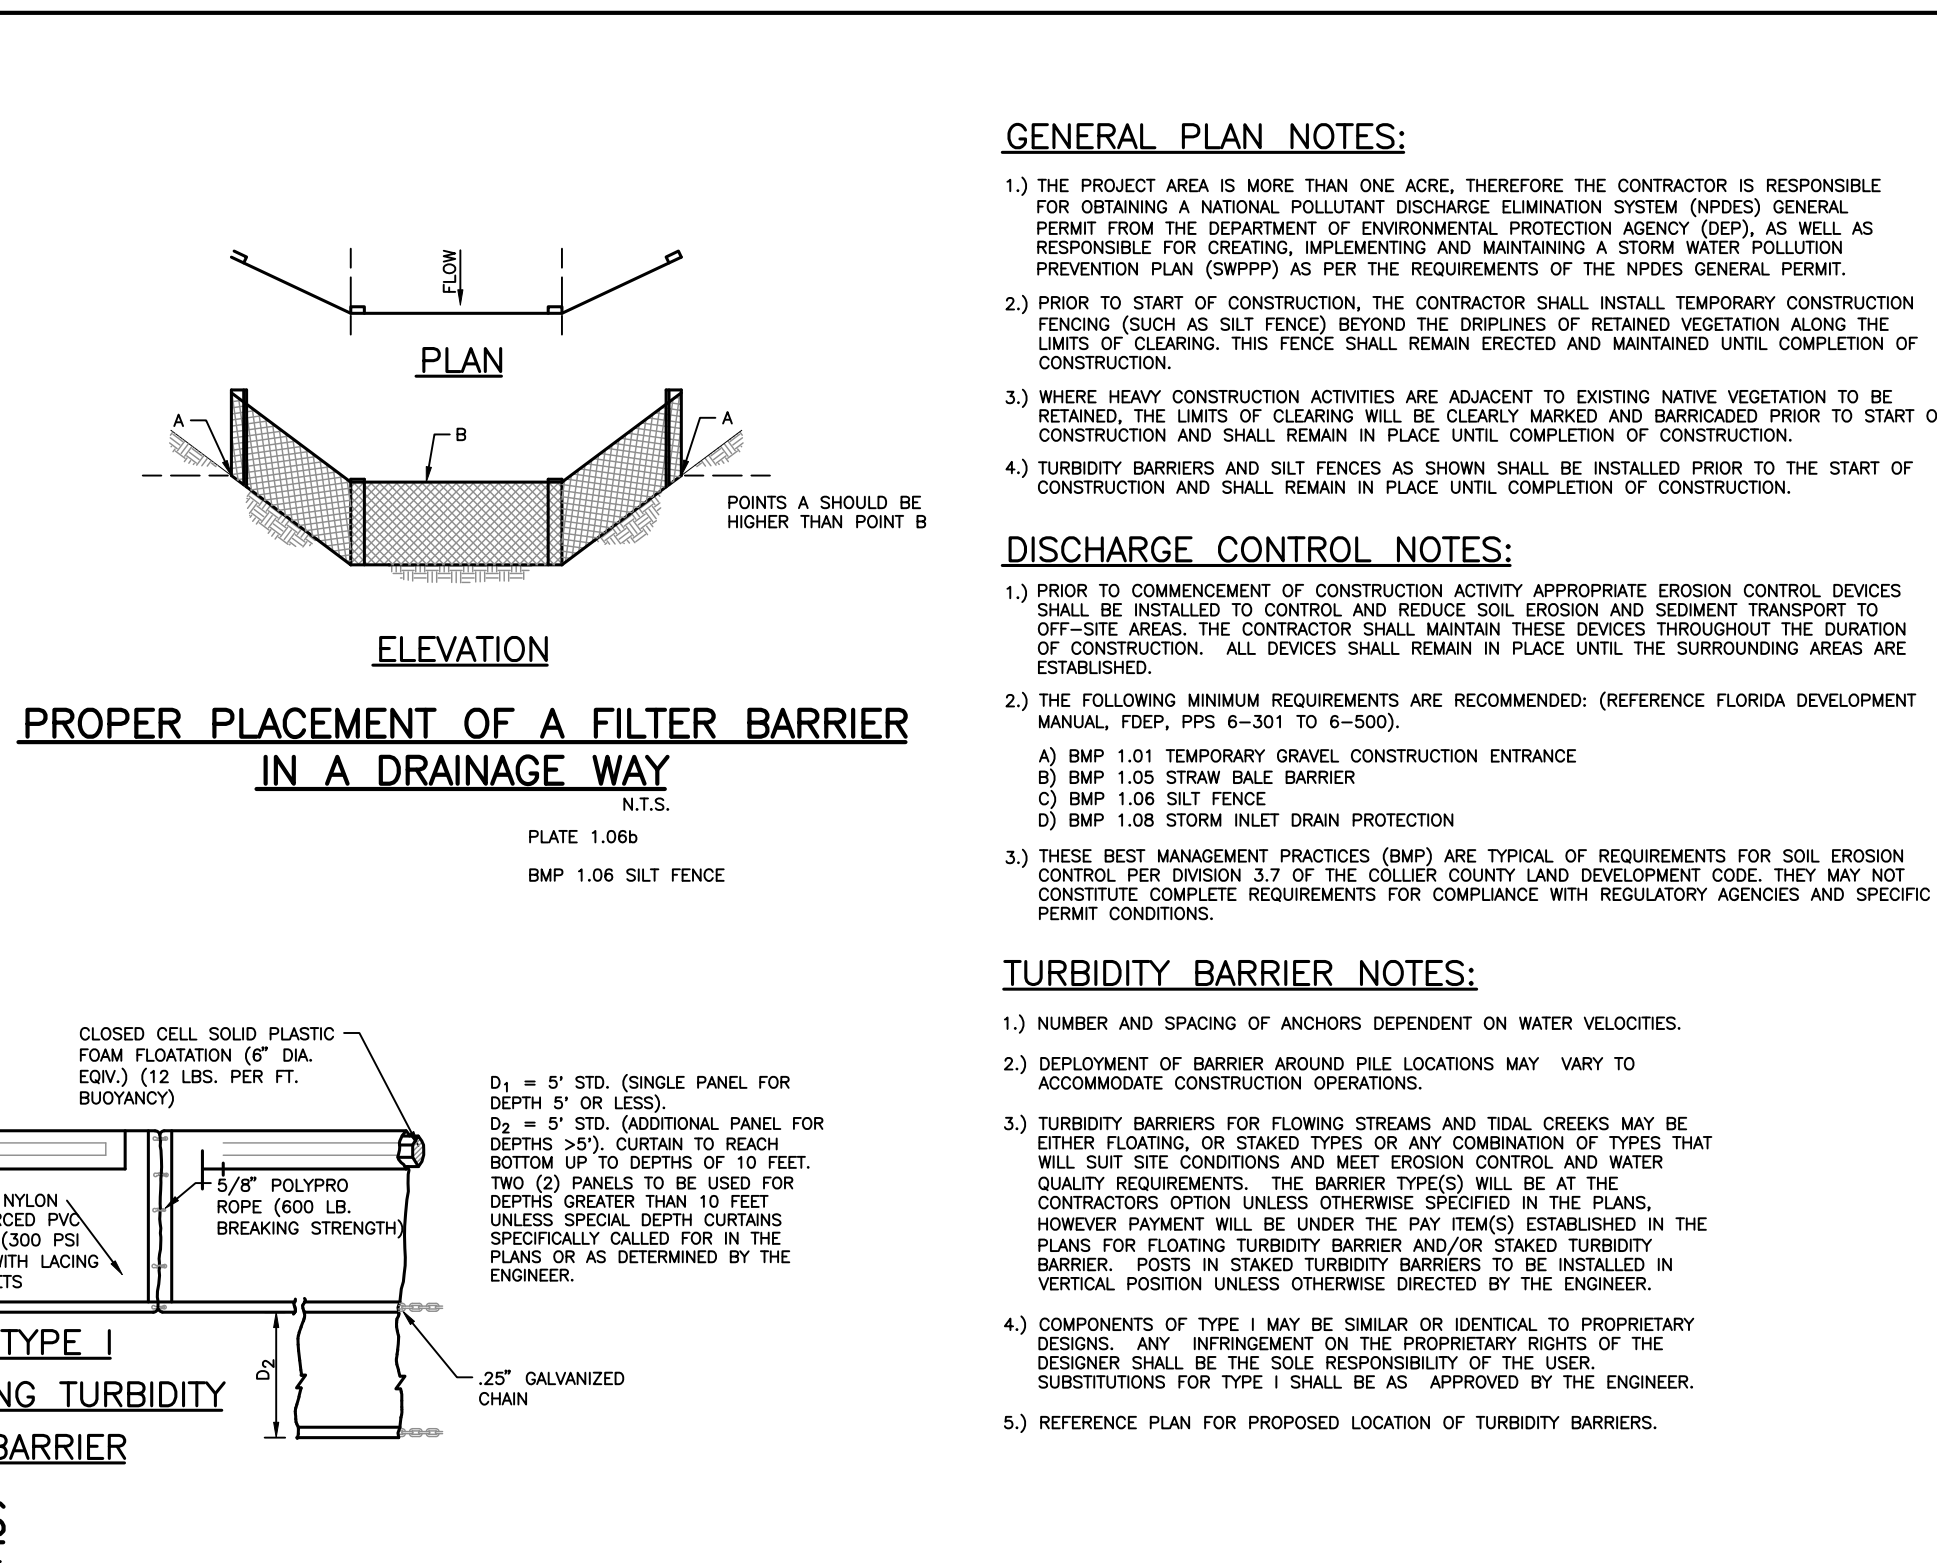
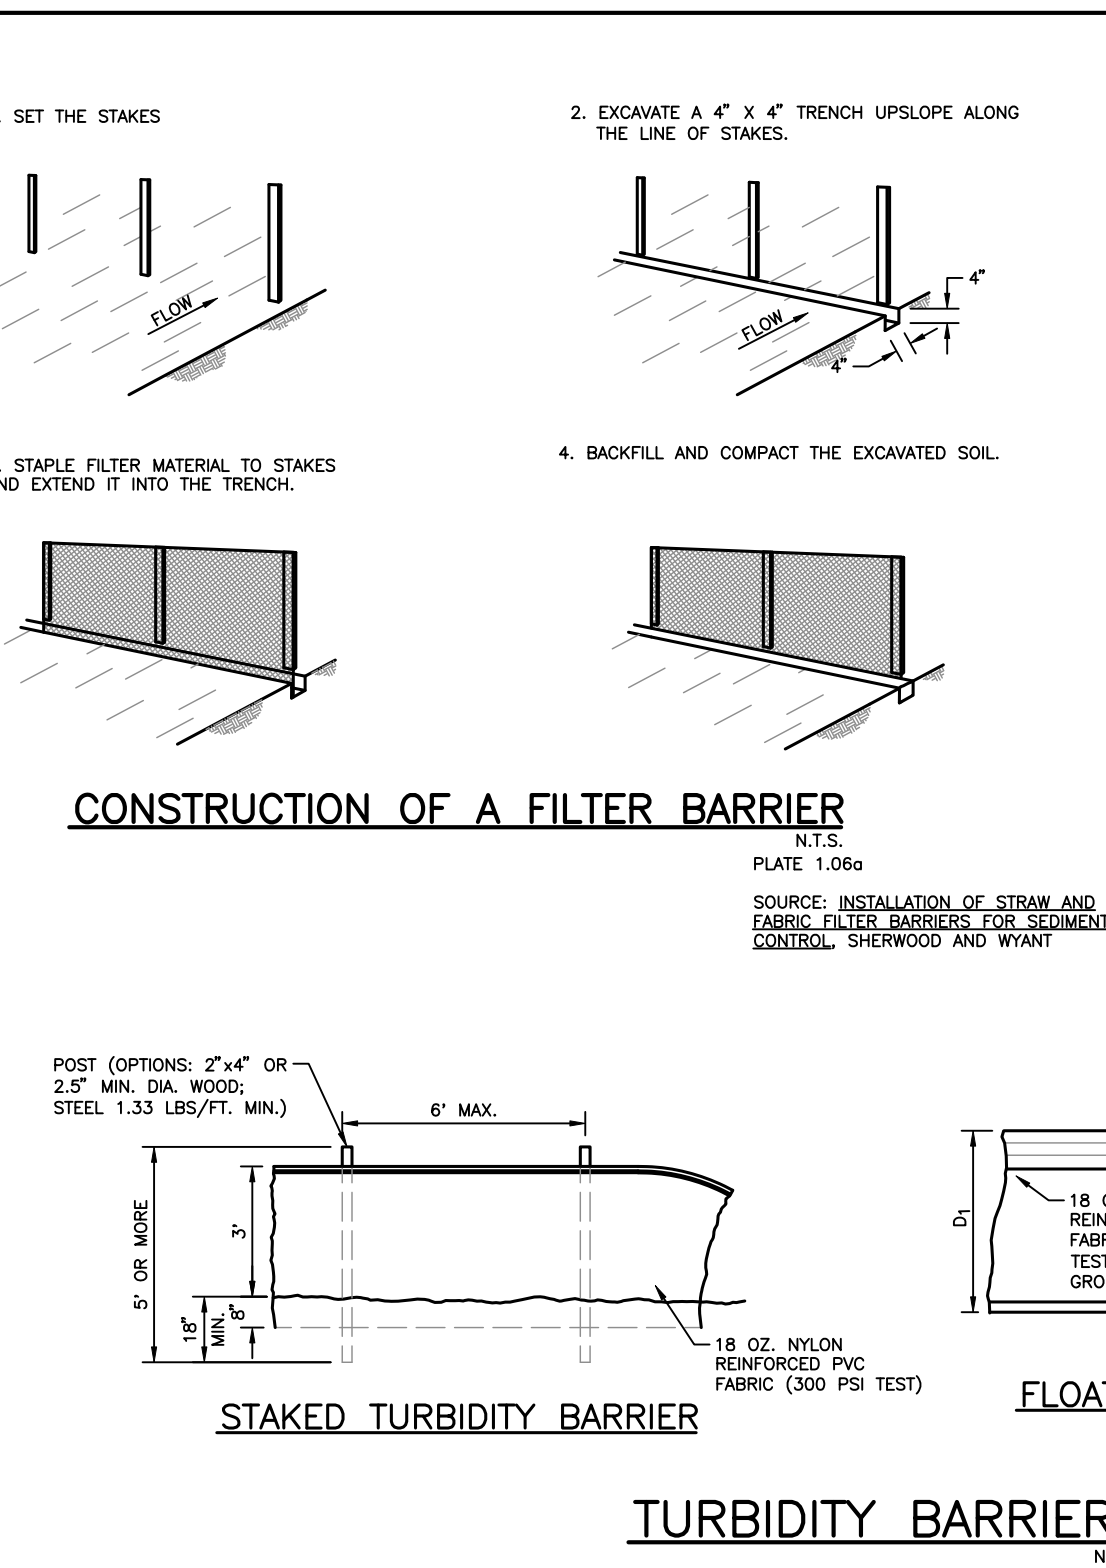
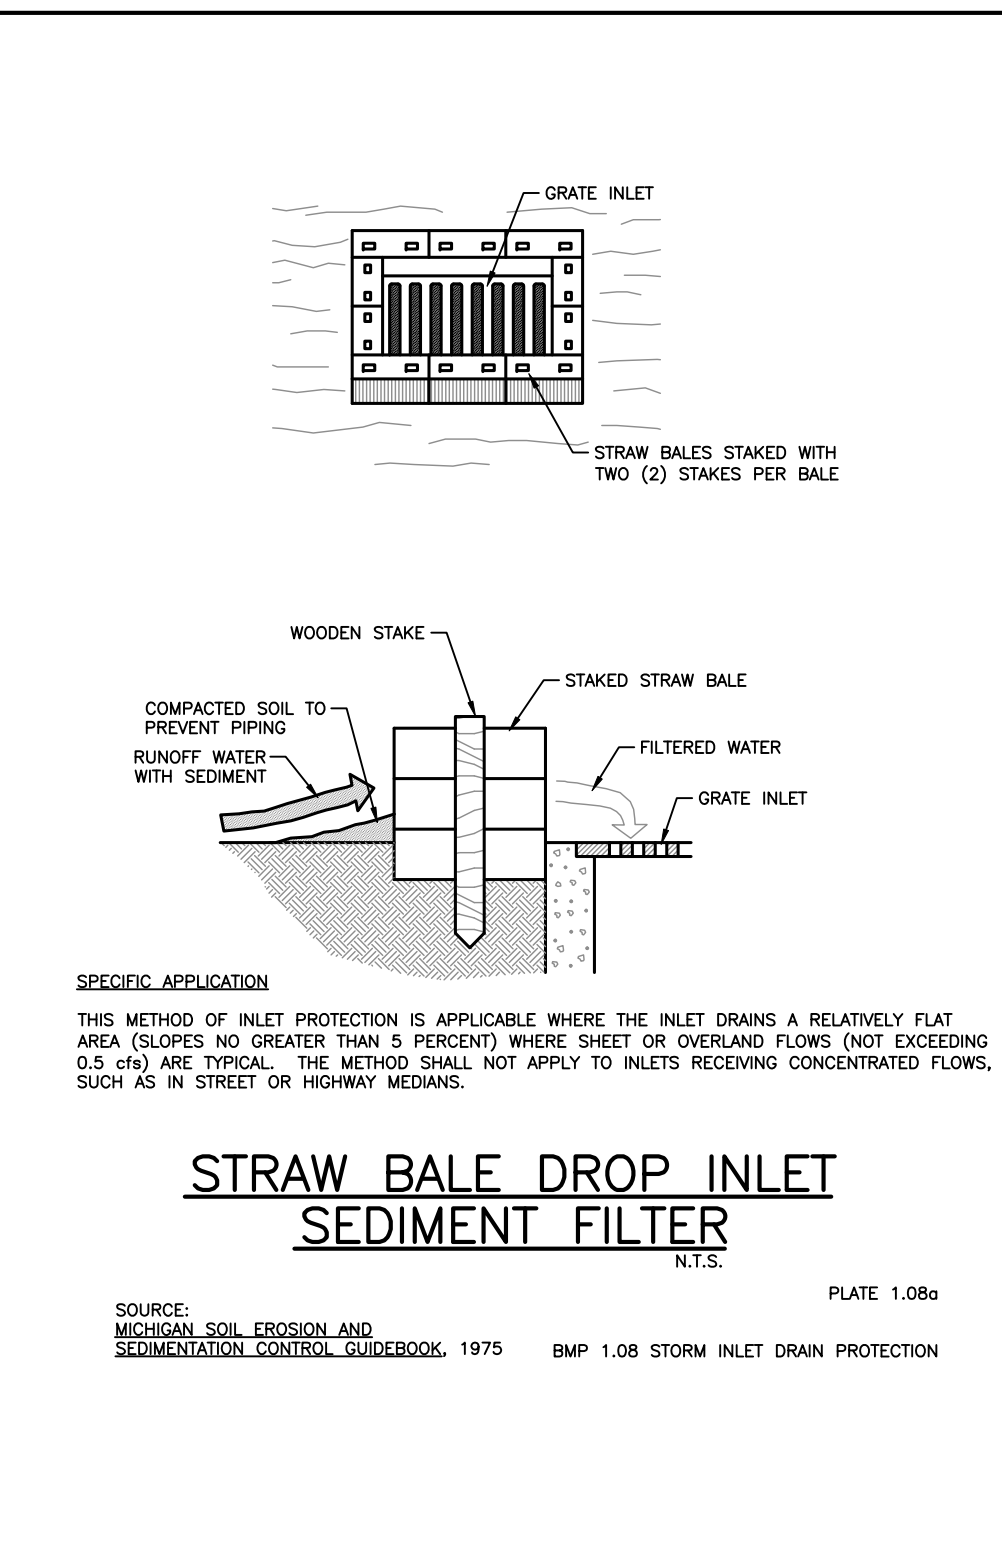
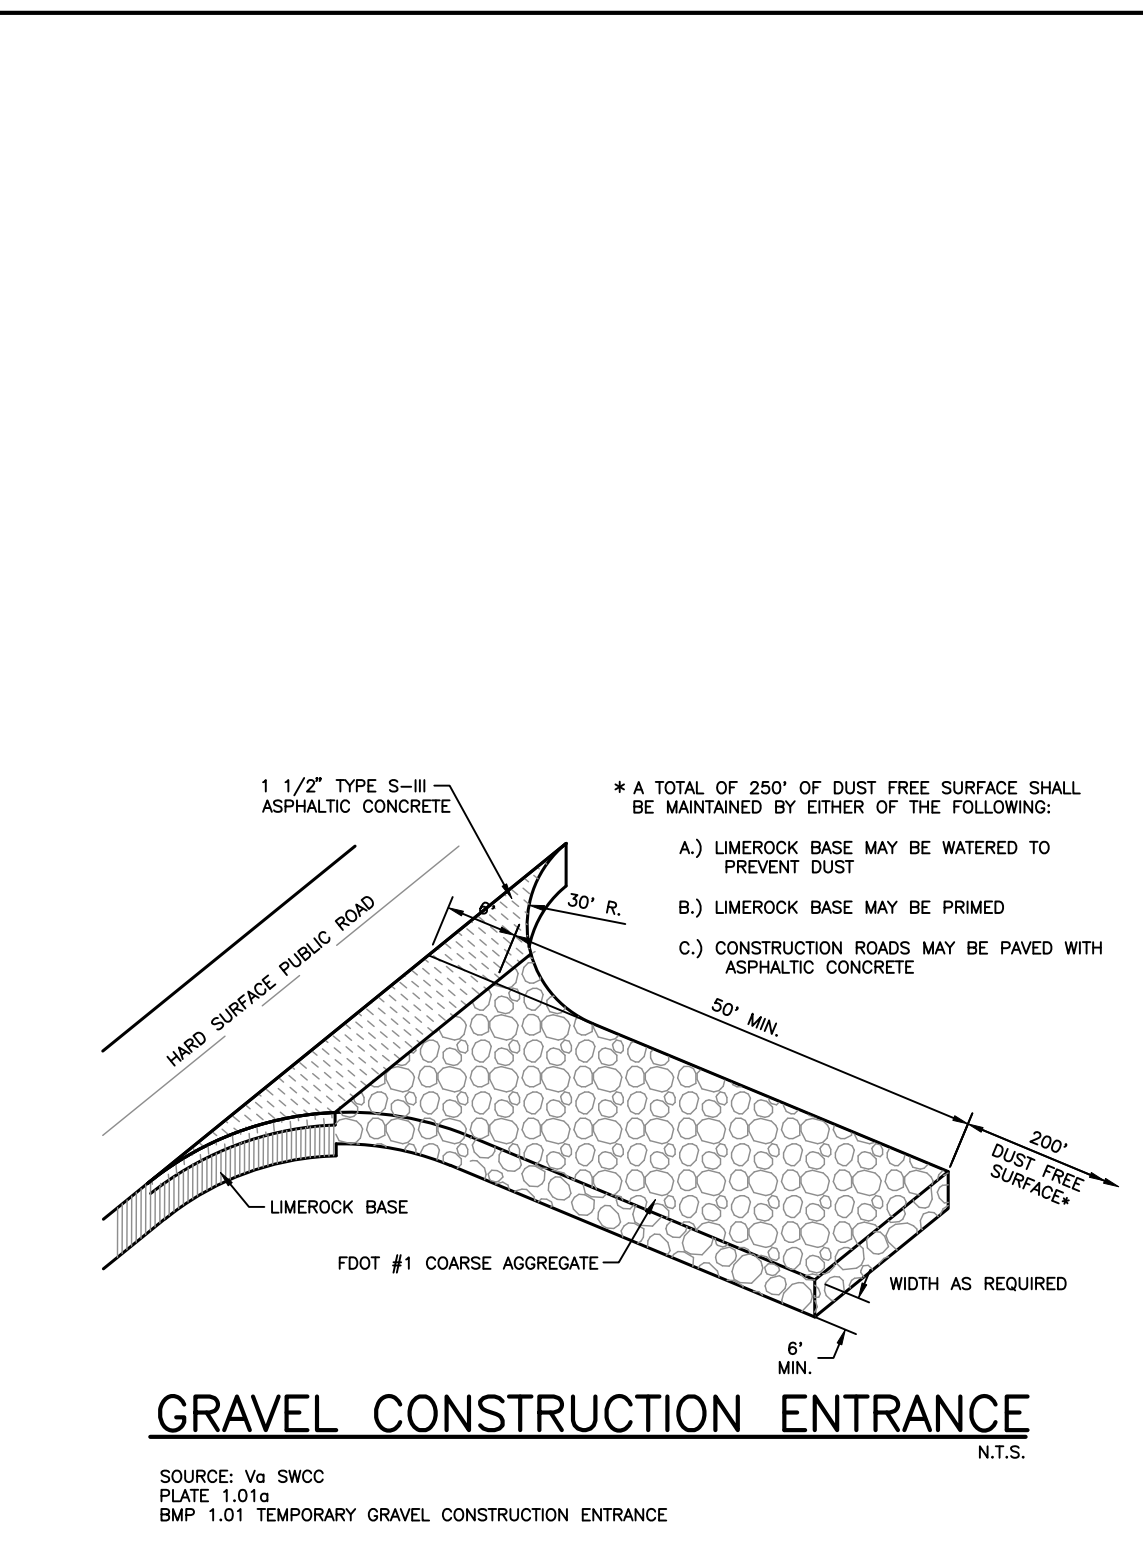
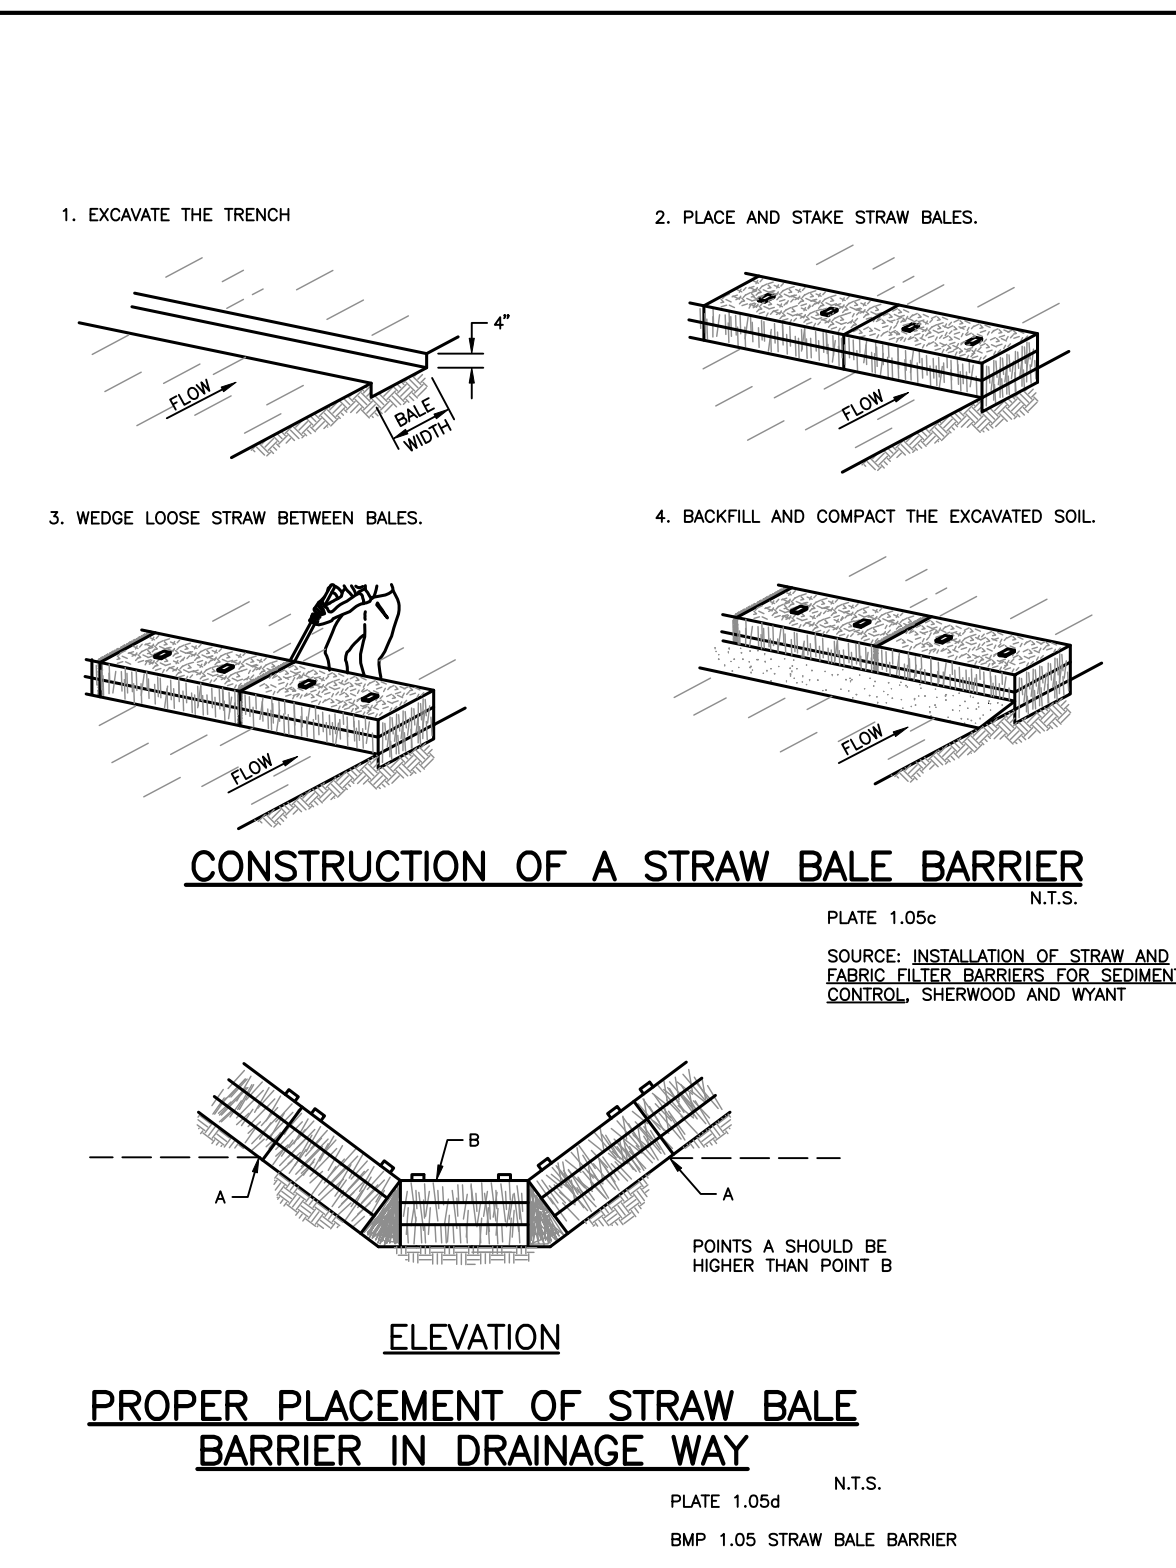


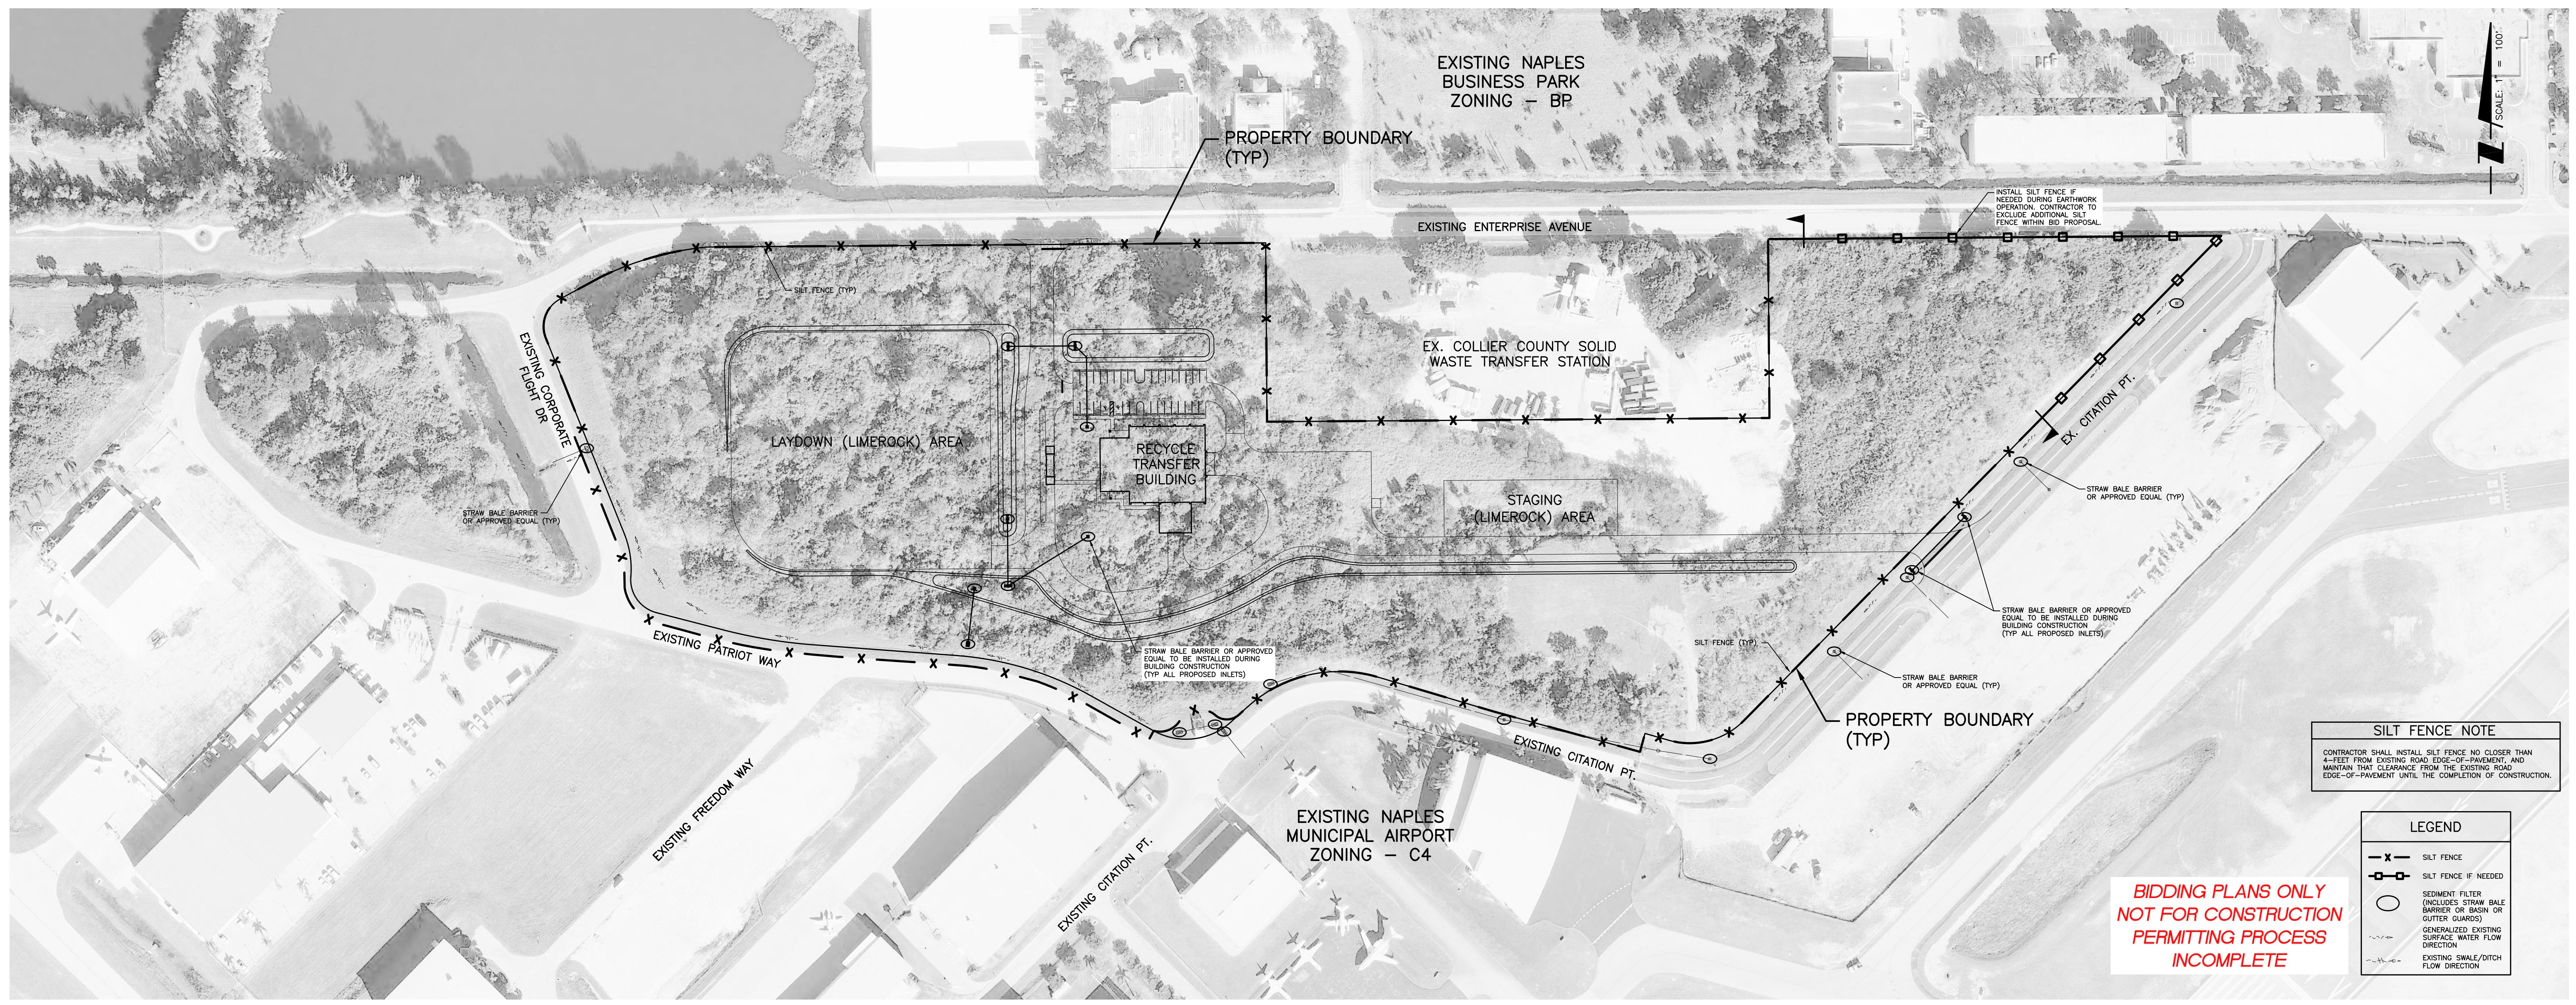

**SILT FENCE NOTE**  
 CONTRACTOR SHALL INSTALL SILT FENCE NO CLOSER THAN 4 FEET FROM EXISTING ROAD EDGE-OF-PAVEMENT, AND MAINTAIN THAT CLEARANCE FROM THE EXISTING ROAD EDGE-OF-PAVEMENT UNTIL THE COMPLETION OF CONSTRUCTION.

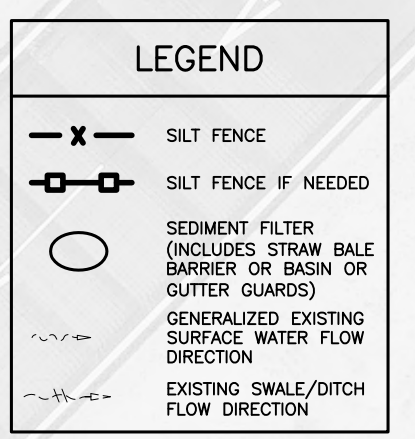

**BIDDING PLANS ONLY  
 NOT FOR CONSTRUCTION  
 PERMITTING PROCESS  
 INCOMPLETE**



<p>DATE: 7/26/2012 10:02:33 AM          PROJECT: 215610640c-017npdes</p>	<p>CITY: COLLIER          ISSUE DATE: MAY 2012          ISSUE DESCRIPTION: NDPEs DISCHARGE CONTROL PLAN AND DETAILS</p>	<p>CLIENT: CITY OF NAPLES          PROJECT: CITY OF NAPLES RECYCLE TRANSFER FACILITY</p>	<p>PROJ. START DATE: MAY 2012          HORIZONTAL SCALE: 1" = 100'          VERTICAL SCALE: N/A          COPYRIGHT: WilsonMiller Inc. 2009</p>	<p>TITLE: NDPEs DISCHARGE CONTROL PLAN AND DETAILS          CROSS REF. NUMBER: ---          WILSONMILLER PROJECT NUMBER: 215610640</p>	<p><b>PRELIMINARY</b></p> <p>PROJECT NUMBER: 215610640c-017npdes          SHEET NUMBER: 17 OF 17</p>
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